PROJECT	DATA		ARCHITE
ADDRESS: 16492 BARNSTABLE CIRCLE HUNTING COUNTY NAME : COUNTY OF ORANGE ASSESSOR PARCEL NUMBER: 178 06 212 ZONE: R1-CZ OCCUPANCY GROUPS: V-B LOT SIZE: 5,255 SF NUMBER OF STORY: 3-STORY BUILDING CLASSIFICATION: SINGLE FAMILY RESIDENTIAL TYPE OF CONSTRUCTION: TYPE V-B FIRE SPRINKLER : "YES" FIRE SPRINKLER PER CRC R313 CODES COMPLY 2019 CALIFORNIA RESIDENTIAL CODE 2019 CALIFORNIA RESIDENTIAL CODE 2019 CALIFORNIA FIRE CODE			SECTION: SECTION LETTER SHEET NUMBER DETAIL: DETAIL: DETAIL: DETAIL: DETAIL: DETAIL: DETAIL: DETAIL: DETAIL: DETAIL: NUMBER SHEET NUMBER SHEET LAYOUT DESI VIEW NUMBER SHEET SHEET NUMBER SHEET SHEET SHEET SHEET SHEET SHEET SHEET SHEET SHEET SHEET SHEET SHEET SHEET SHE
2019 CALIFORNIA GREEN BUILDING STANDARDS CODE OF HUNTINGTON BEACH CITY			CENTER LINE PROPERTY LINE
GENERAL INFO	ORMATION		SCO
PROPOSED:NEW ADDITIONLOT SIZE:5,255 SFEXISTING ZONE:R1-CZTYPE OF CONSTRUCTION:V-BAPN:178 06 212EXISTING HOME INFORMATION(E) LOT COVERAGE (1,816 SF)TOTAL (E) LIVING AREA(E) GARAGE (2 CAR GARAGE)(E) BEDROOM	MAX. 50%	34.55% 2,692 SF 438 SF 4	DEFERI
(E) BATHROOM		3.5	
NEW HOME INFORMATION FRONT SET BACK REAR SET BACK HEIGHT LIMIT (N)BEDROOM (N)BATHROOM TOTAL BALCONY AREA 1ST FLOOR LIVING AREA 2ND FLOOR LIVING AREA 3RD FLOOR LIVING AREA	REQUIRED 15' 10' 5' 35'	PROVIDED 20' 10' 5' 4 5 BATHS + 1 POWDER 118 SF 2,024 SF 2,114 SF 871 SF	
TOTAL LIVING AREA LOT COVERAGE (2,566 SF)	MAX. 50%	5,009 SF 48,83%	
 A. APPLICATIONS FOR WHICH NO PERMIT IS ISSUED WITHIN 180 DAYS F (R105.3.2 CRC) B. EVERY PERMIT ISSUED SHALL BECOME INVALID UNLESS WORK AUTH IS SUSPENDED OR ABANDON FOR A PERIOD OF 180 DAYS. A SUCCES BE EXTENDED IF A WRITTEN REQUEST STATING JUSTIFICATION FOR OF THE PERMIT AND GRANTED BY THE BUILDING OFFICIAL. NO MORE INVALID SHALL PAY A REACTIVATION FEE OF APPROXIMATELY 50% O EXPIRED FOR UP TO (6) MONTHS. WHEN A PERMIT HAS BEEN EXPIRE SHALL BE APPROXIMATELY 100% OF THE ORIGINAL PERMIT FEE. (F C. FIRE SPRINKLER PLANS STAMPED AND APPROVED BY THE CITY OF H AT TIME OF FRAMING INSPECTION. D. WATER CLOSETS SHALL HAVE AN AVERAGE WATER CONSUMPTION O PER FLUSH AFTER JULY 1, 2011. (402.2 CPC) 	ORIZED IS COMMENCED N SSFUL INSPECTION MUST EXTENSION AND AN EXTE THAN (1) EXTENSION MA OF THE ORIGINAL PERMIT F ED FOR A PERIOD IN EXCE R105.5 CRC)	WITHIN180 DAYS OR IF THE WORK AUTH BE OBTAINED WITHIN 180 DAYS . A PER INSION FEE IS RECEIVED PRIOR TO EXE Y BE GRANTED. PERMITS WHICH HAVE FEE AMOUNT WHEN THE PERMIT HAS B ISS IF ONE (1) YEAR, THE REACTIVATION DEPARTMENT SHALL BE PROVIDED AT	CPVC AND CPC, INSTA CPC, INSTA CPVC WATE MIT MAY PIRATION I. ALL CONST BECOME CALIFORNIA EEN CALIFORNIA N FEE J. TWO SEPAI CBC) ELEC THE SITE ENERGY CO 1. THE ENE

F. SHOWER HEADS SHALL HAVE A WATER FLOW NOT TO EXCEED 2.0 GALLONS PER MINUTE. (402.1.1 CPC)

MINUTE.

G. SFAUCETS IN KITCHENS, WET BARS, LAVATORIES, LAUNDRY SINKS, ETC. SHALL HAVE A WATER FLOW NOT TO EXCEED 1.8 GALLONS PER

GINEER OF RECORD SHALL INSPECT THE SLAB AND FOUNDATION SYSTEM INSTALLATION JUST PRIOR TO CONCRETE POUR TO AT THE FOUNDATION INSTALLATION IS IN ACCORDANCE WITH THE APPROVED PLANS AND DESIGN. THE ENGINEER OF RECORD IN PREPARE A REPORT STATING THE FOUNDATION INSTALLATION IS IN ACCORDANCE WITH THE APPROVED PLANS AND DESIGN. DATION INSPECTION AND APPROVAL TO POUR CONCRETE WILL NOT BE APPROVED UNTIL THE INSPECTION CERTIFICATION THE ENGINEER OF RECORD HAS BEEN RECEIVED AND APPROVED BY THE CITY OF **HUNTINGTON BEACH** BUILDING DIVISION. 2. THE ENGINEER OF RECORD SHALL ALSO INSPECT THE COMPLETED FRAMING SYSTEM OF THE HOME AFTER THE INSTALLATION OF THE ROUGH PLUMBING, MECHANICAL, ELECTRICAL SYSTEMS AND THE EXTERIOR OF THE HOMES HAS BEEN WEATHER WRAPPED. THE ENGINEER OF RECORD SHALL THEN PREPARE A REPORT STATING THAT TEH FRAMING SYSTEM HAS BEEN INSTALLED IN ACCORDANCE WITH THE APPROVED PLANS AND DESIGN. THE ROUGH FRAMING, PLUMBING, MECHANICAL, ELECTRICAL AND EXTERIOR WEATHER BARRIER INSPECTION SHALL NOT BE APPROVED UNTIL THE INSPECTION CERTIFICATION LETTER BY THE ENGINEER OF RECORD HAS BEEN RECEIVED AND APPROVED BY THE CITY OF HUNTINGTON BEACH BUILDING DIVISION.



ECTURAL SYMBOL	DIRECTORY	NOTES	
EXTERIOR ELEVATION: ELEVATION LETTER SHEET NUMBER INTERIOR ELEVATION: SHEET NUMBER ELEVATION LETTER ELEVATION LETTER EQUIPMENT NUMBER	OWNER: RUBICON INVESTMENT PROPERTIES LLC 16492 BARNSTABLE CIRCLE HUNTINGTON BEACH, CA 92649 TEL. (714) 956 5977 DESIGNER: ANHA STUDIO 12862 JOY STREET, GARDEN GROVE, CA 92840		SHEET CV.1 A0.1 A0.2 A0.3
ELEVATION TAG ELEVATION ESIGNATION F ELEVATION F ELEV	STRUCTURAL ENG. TRUONG DONG 15751 BROOKHURST ST, #225, WESTMINSTER, CA 92683 TEL. (714) 204 2874		A0.4 A0.5 A0.6 A0.7 A0.8 A0.9
GRAPHIC SCALE			
OPE OF WORK	VICINITY	MAP	
RED SUBMITTAL			
	16492 BARNSTABL HUNTINGTON BEA		
AGENCY RE	QUIREMENTS		

AGENUT REQUIREMENTS

ING MATERIALS WITHIN A BUILDING SHALL BE IN ACCORDANCE WITH Sec. 604.1 OF THE CALIFORNIA PLUMBING CODE. Pex, OTHER PLASTIC WATER PIPING SYSTEMS SHALL BE INSTALLED IN ACCORDANCE WITH THE REQUIREMENTS OF Sec. 604 OF THE LLATION STANDARDS OF APPENDIX 1 OF THE CPC AND THE MANUFACTURERS RECOMMENDED INSTALLATION STANDARDS. ER PIPING REQUIRES A CERTIFICATION OF COMPLIANCE AS SPECIFIED IN Sec.604.1.1 OF THE CPC PRIOR TO PERMIT ISSUANCE.

RUCTION SHALL COMPLY WITH THE 2019 EDITIONS OF THE CALIFORNIA RESIDENTIAL CODE, CALIFORNIA BUILDING CODE, A ELECTRICAL CODE, CALIFORNIA MECHANICAL CODE, CALIFORNIA PLUMBING CODE, CALIFORNIA FIRE CODE, AND 2019 A ENERGY CODE.

RATE SITE VISITS AND REPORTS PREPARED BY THE ENGINEEROF RECORD FOR THE NEW HOME DESIGN ARE REQUIRED; (109.3.8 TRICAL CODE, CALIFORNIA MECHANICAL CODE, CALIFORNIA PLUMBING CODE, CALIFORNIA FIRE CODE, AND 2019 CALIFORNIA ODE.

- SYSTEM LINES, AND PRIVATE SERVICE UTILITIES.

- INSPECTIONS SHALL BE AS REQUIRED BY SECTION 1705 OF THE CBC.

NEW SINGLE HOUSE 16492 BARNSTABLE CIRCLE HUNTINGTON BEACH, CA 92649

DRAWING INDEX

ARCHITECTURAL		STRUCTURAL
DESCRIPTION	SHEET	DESCRIPTION
COVER SHEET		
EXISTING FLOOR PLANS NEW SITE PLAN FIRST FLOOR PLAN SECOND FLOOR PLAN THIRD NEW SITE PLAN ROOF PLAN		
ELEVATIONS ELEVATIONS		
ELEVATION CERTIFICATE		

K. A PRE-CONSTRUCTION MEETING IS REQUIRED IMMEDIATELY PRIOR TO THE START OF CONSTRUCTION. THIS MEETING SHALL TAKE PLACE AT THE SITE OF THE NEW HOME. THE MEETING MUST INCLUDE A REPRESENTATIVE OF THE BUILDING DIVISION, THE GENERAL CONTRACTOR, A REPRESENTATIVE OF EACH OF THE SUBCONTRACTORS (ELECTRICAL, PLUMBING, MECHANICAL, GRADING, OFF-SITE CONTRACTOR, ETC.) DEPENDANT UPON WHAT SUB-CONTRACTORS ARE TO BE INVOLVED IN THE NEW CONSTRUCTION AND A REPRESENTATIVE OF THE OWNER MAY BE PRESENT. THE MEETING WILL REVIEW REQUIRED PERMITS, TEMPORARY POWER REQUIREMENTS, DOCUMENTS REQUIRED TO BE ON THE SITE, INSPECTION REQUIREMENTS, FIELD CORRECTION NOTICE PROCEDURE, CHANGES IN THE FIELD, FINAL INSPECTIONS AND GAS AND POWER RELEASES, QUESTIONS FROM THE CONTRACTORS OR OWNER AND ANY OTHER SPECIAL PROCEDURES OR CONDITIONS FOR THAT PARTICULAR NEW HOME. THE PRE-CONSTRUCTION MEETING SHALL BE SCHEDULED THROUGH THE BUILDING DIVISION FRONT COUNTER AT 714-229-6730.

L. ALL DOORS AND WINDOWS SHALL MEET CITY OF HONTINGTON BEACH SECURITY ORDINANCE.

M. PROVIDE FOR MAINTENANCE, REPAIR, AND REPLACEMENT BY A HOMEOWNERS ASSOCIATION (HOA) FOR ALL COMMON AREA LANDSCAPE, IRRIGATION, DRAINAGE FACILITIES, WATER QUALITY BMP'S, WATER SYSTEM LINES, FIRE SYSTEM LINES, SEWER

N. CONCRETE SLAB AND UNDER-FLOOR INSPECTION SHALL BE MADE AFTER IN-SLAB OR UNDER FLOOR REINFORCING STEEL AND BUILDING SERVICE EQUIPMENT, CONDUITS, PIPING OR OTHER ANCILLARY BUILDING TRADE PRODUCTS OR EQUIPMENT ARE INSTALLED, BUT BEFORE ANY CONCRETE IS PLACED OR FLOOR SHEATHING IS INSTALLED, INCLUDING THE SUBFLOOR. (R109.1.1.1)

O. ROUGH INSPECTION OF PLUMBING, MECHANICAL, GAS, AND ELECTRICAL SYSTEMS SHALL BE MADE PRIOR TO COVERING OR CONCEALMENT, BEFORE FIXTURES OR APPLIANCES ARE SET OR INSTALLED, AND PRIOR TO FRAMING INSPECTION. (R109.1.2)

P. THE PLANS SHALL PROVIDE STATEMENT SPECIFICALLY LISTING ALL REQUIRED SPECIAL INSPECTIONS FOR THE PROJECT. SPECIAL

STAMP:



12862 Joy Street, Suite A Garden Grove CA 92840 Tel: (714) 200 4122 ANHA studio Email: aha@anha-studio.com

SINGLE FAMILY HOUSE

16492 BARNSTABLE CIRCLE HUNTINGTON BEACH, CA 92649

RUBICON INVESTMENT **PROPERTIES LLC** 16492 BARNSTABLE CIRCLE HUNTINGTON BEACH, CA 92649

Tel: (714) 856 5977

BUILDING DEPARTMENT SUBMITTAL:

REVISIONS: 1 9/22/2021

Planning Correction

PROJECT DIRECTOR: JOB CAPTAIN: SENIOR ASSOCIATE: ASSOCIATES: PROJECT NUMBER PROJECT CAD FILE:

SHEET TITLE: **COVER SHEET**

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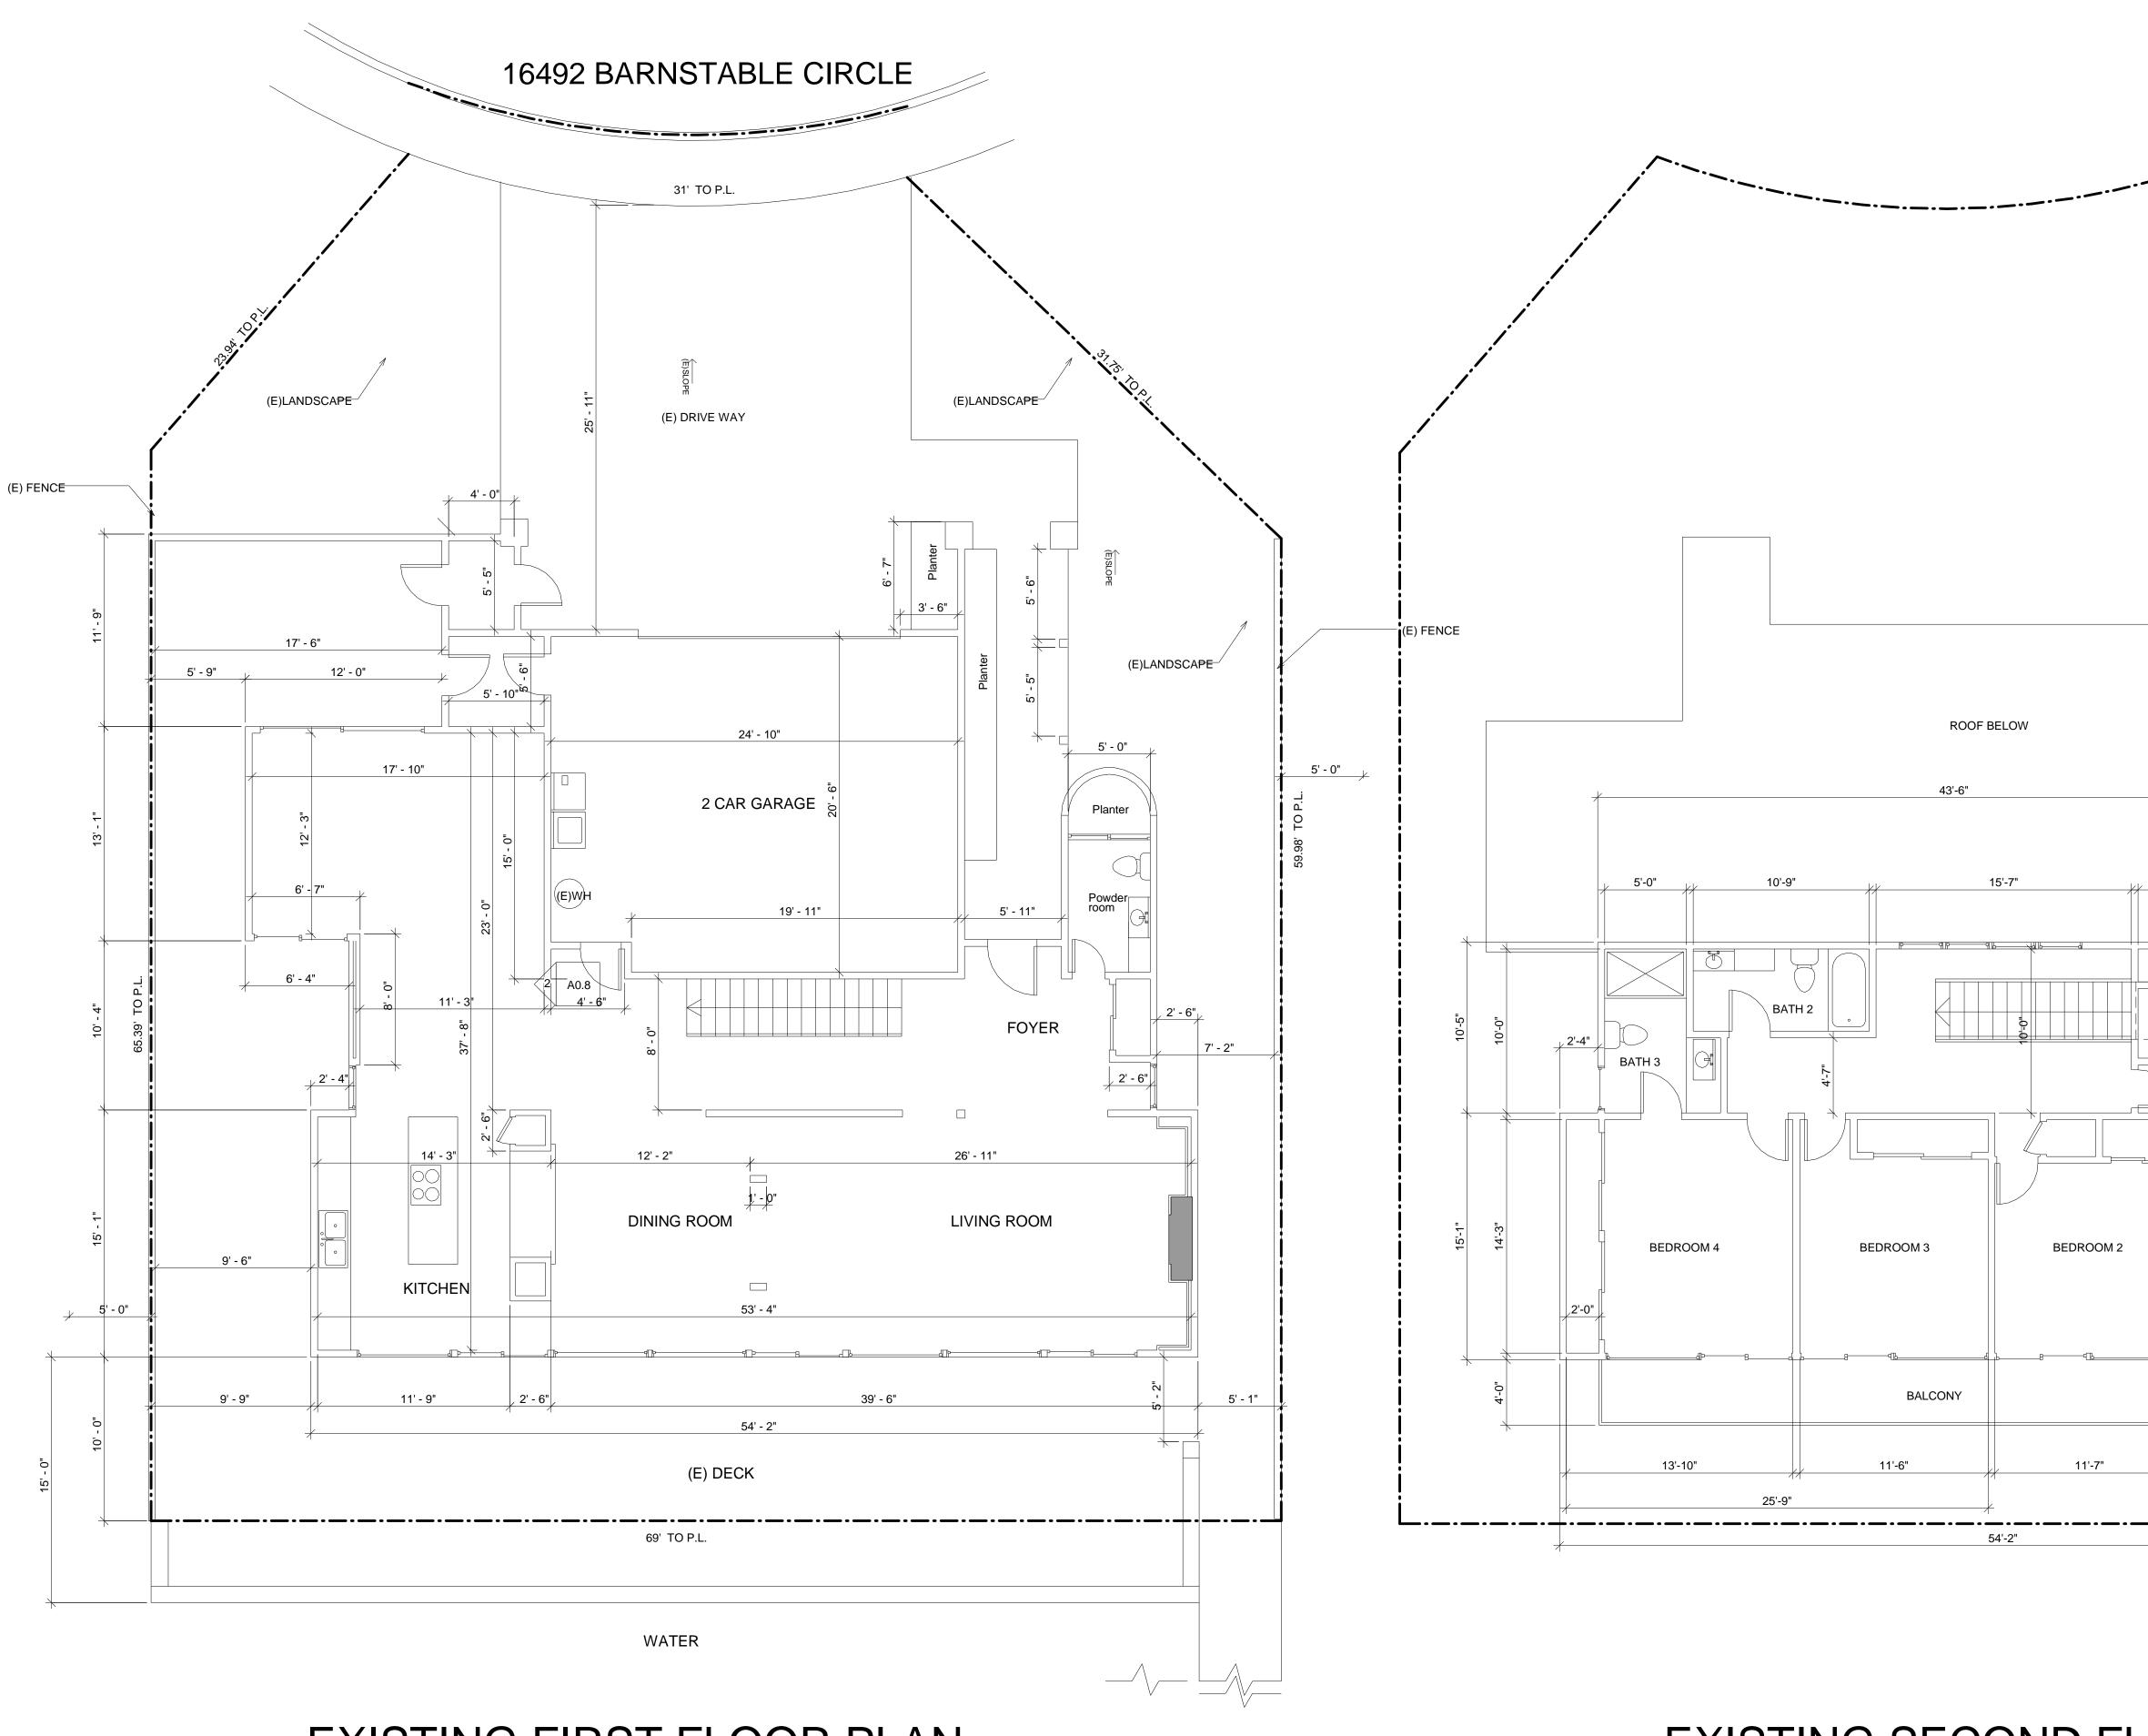
SHEET NUMBER:

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 $\mathbf{\nabla}$ **Z** PLOT REFERENCE DATE:

MM/DD/YYYY

EXISTING FIRST FLOOR PLAN SCALE: 3/16" = 1'-0"



SCALE: 3/16" = 1'-0"

GENERAL INFORMATION

ADDRESS: 16492 BARNSTABLE CIRCLE HUNTINGTON BEACH, CA 92649 LOT SIZE: 4,968 SF.

(E) LOT COVERAGE (2,359 SF) 47.48% TOTAL (E) LIVING AREA (E) GARAGE (2 CAR GARAGE) (E) BEDROOM

(E) BATHROOM

2,905 SF 500 SF 4

3 BATHS + 1 POWDERS

5'-10" 10'-6" W.I.C. BATH 1 MASTER BEDROOM 1 15'-2" 15'-7"

EXISTING SECOND FLOOR PLAN



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SINGLE FAMILY HOUSE

16492 BARNSTABLE CIRCLE HUNTINGTON BEACH, CA 92649

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SHEET TITLE: **EXISTING FLOOR** PLAN

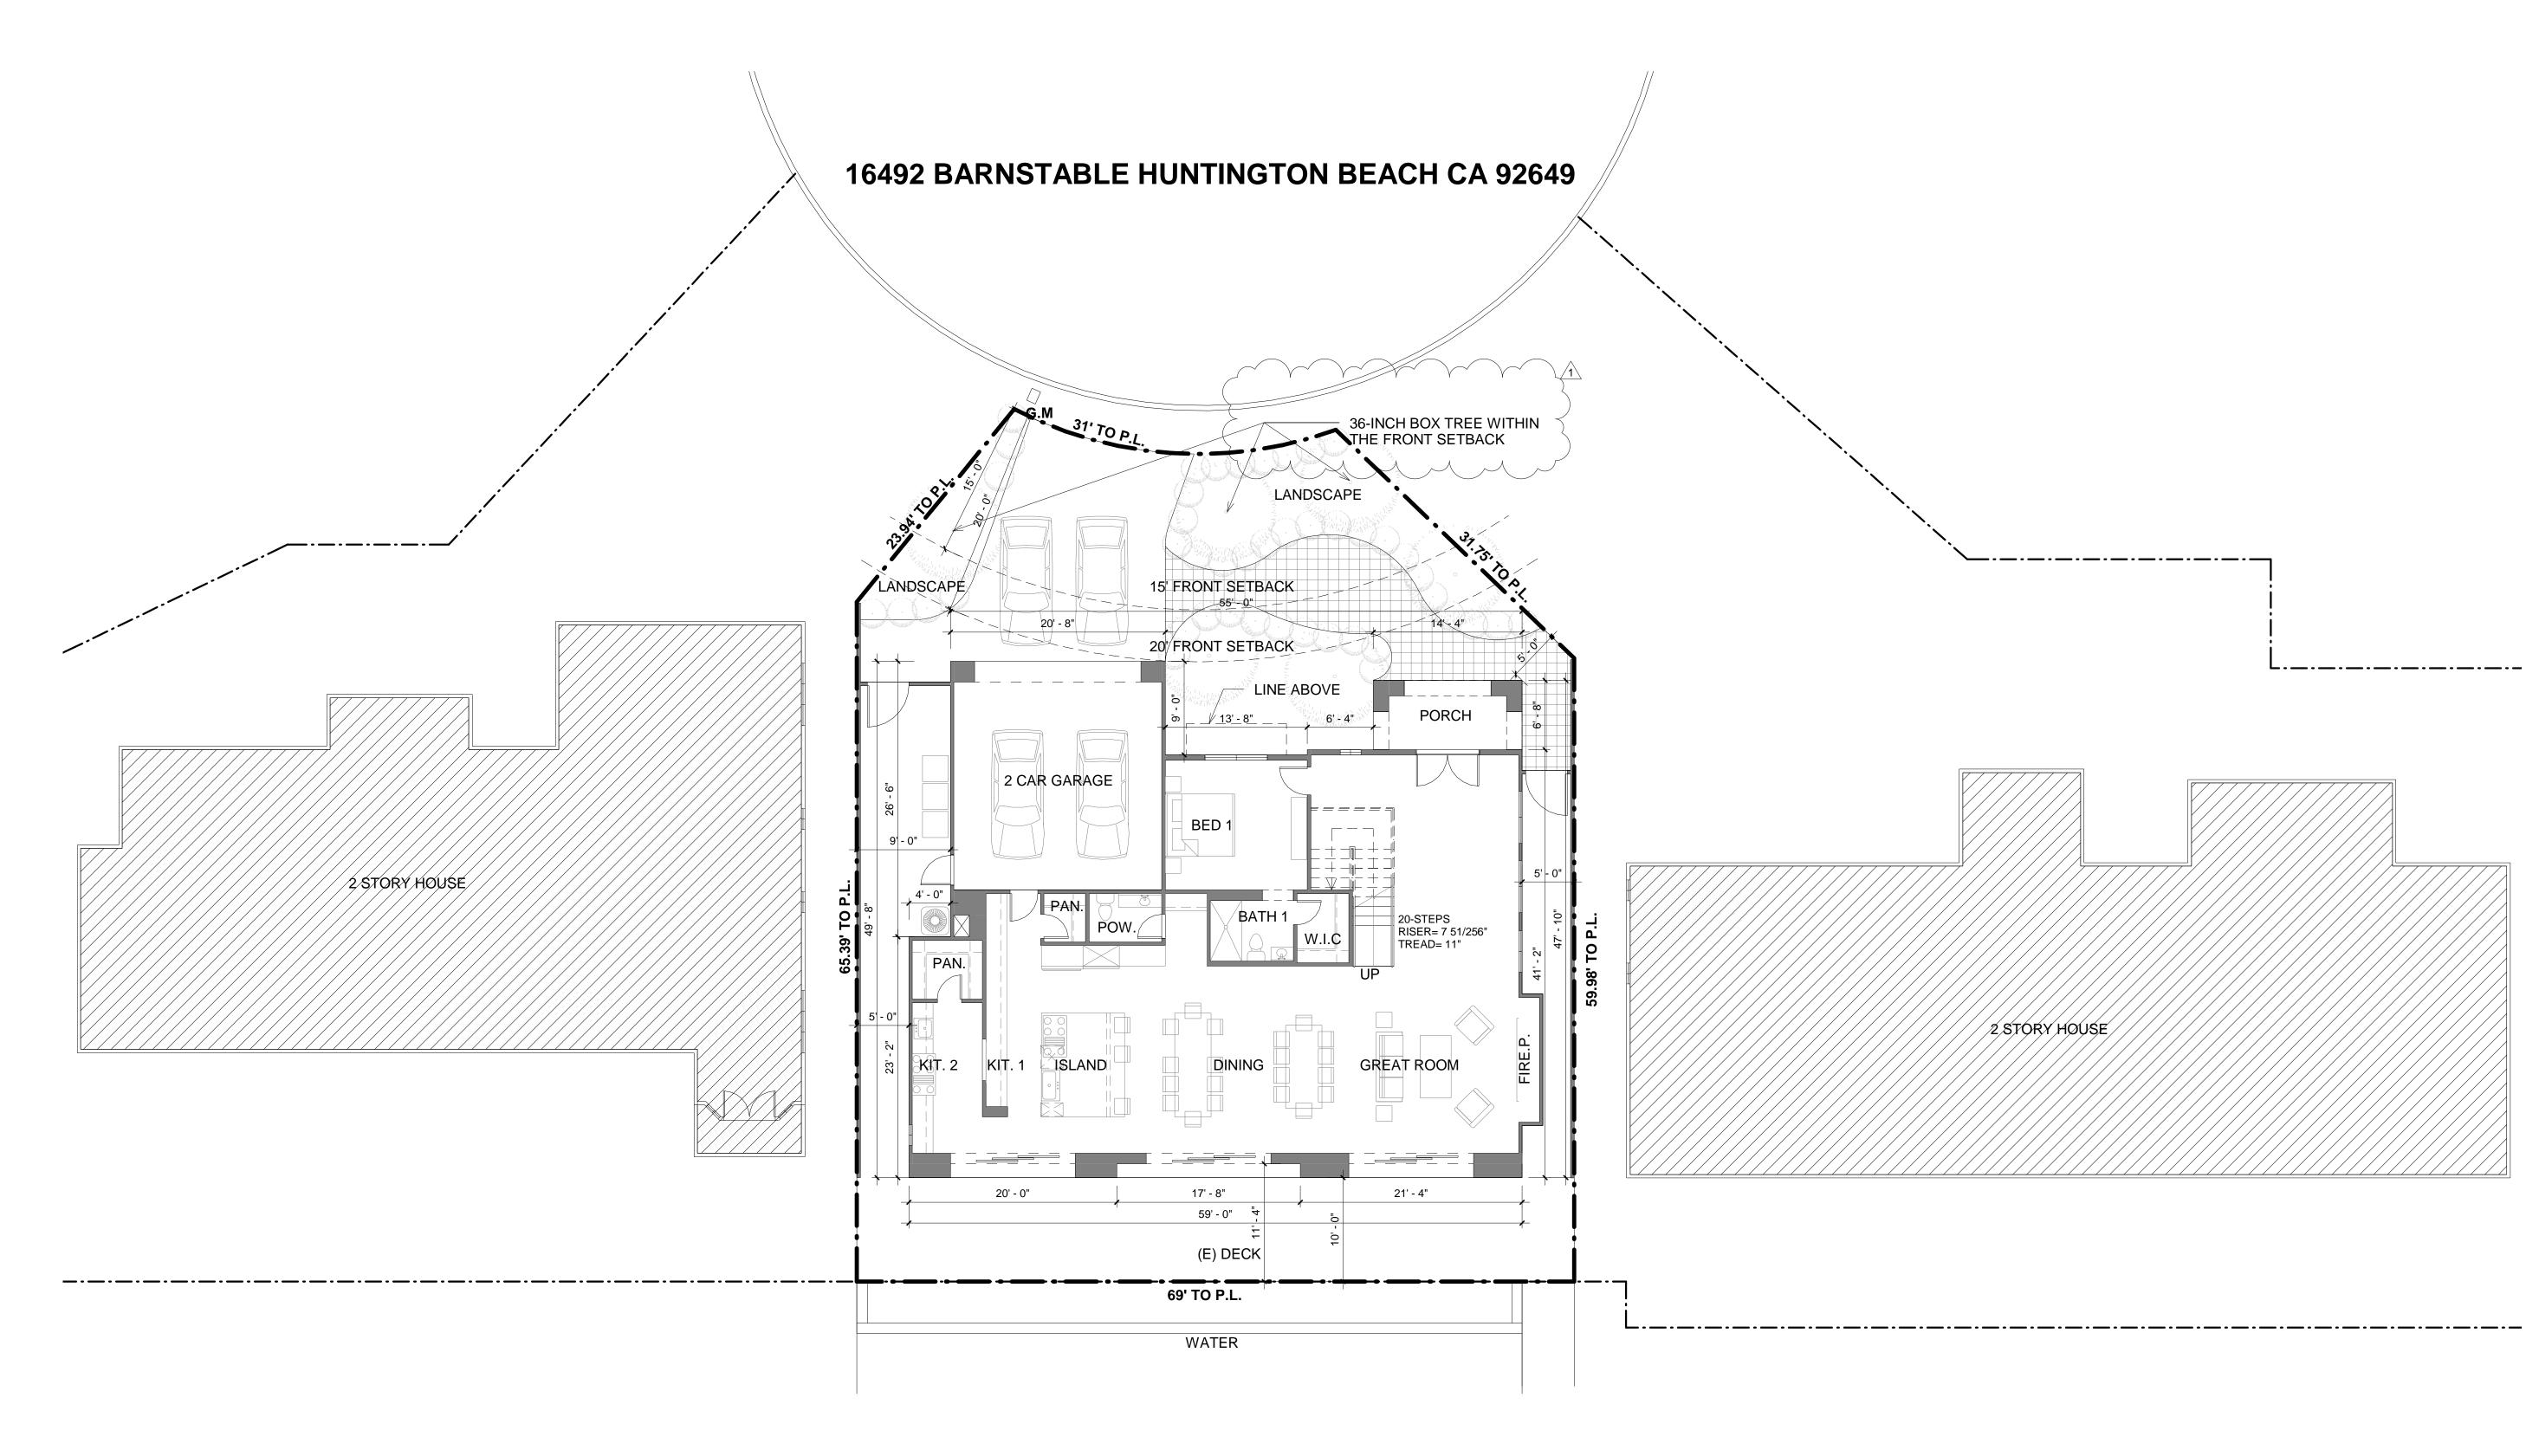
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PLOT REFERENCE DATE:

04/29/21



NEW SITE PLAN

SCALE: 1/8" = 1'-0"

STAMP:



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SINGLE FAMILY HOUSE

16492 BARNSTABLE CIRCLE HUNTINGTON BEACH, CA 92649

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BUILDING DEPARTMENT SUBMITTAL

REVISIONS: 9/22/2021

Planning Correction

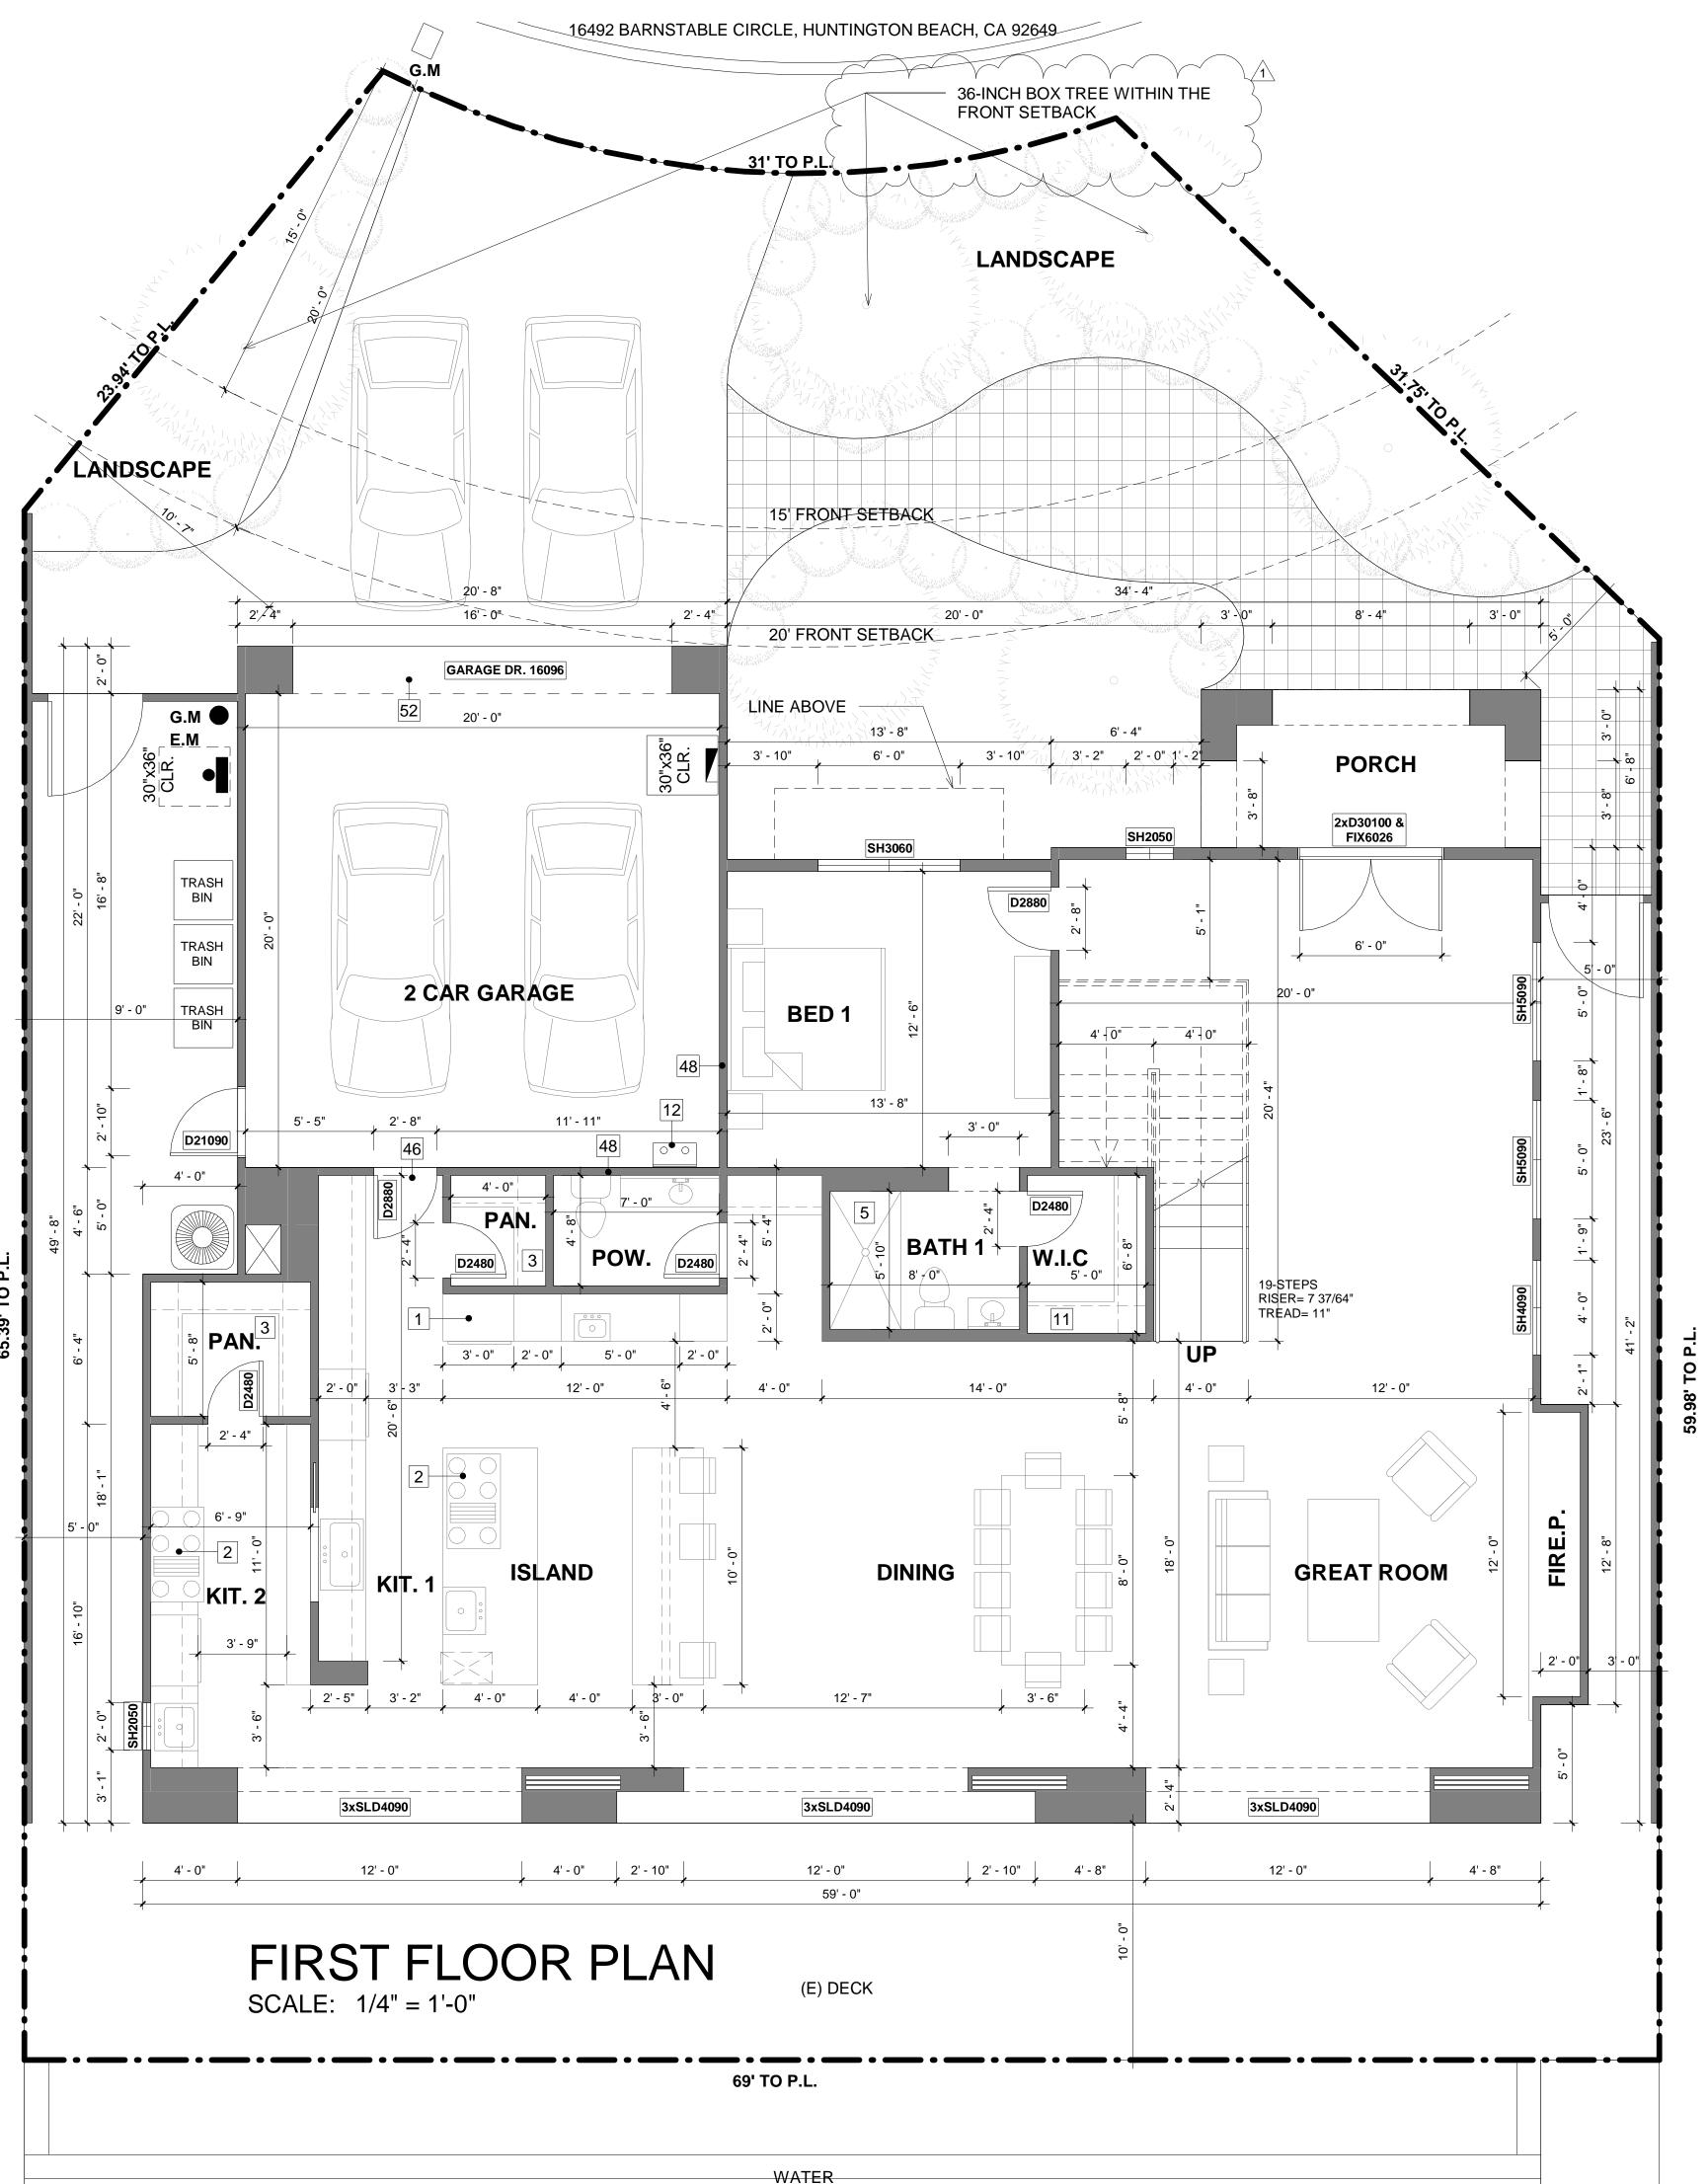
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SHEET TITLE: NEW SITE PLAN

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FLOOR PLAN NOTE

- 1, 48" CLEAR REFRIGERATOR SPACE, PLUMB FOR WATER SUPPLY, VERIFY WIDTH AND DEPTH IF BUILT- IN REFRIGERATOR.
- 2. 36" COOKTOP AND METAL EXHAUST HOOD ABV. W/ LIGHT AND FAN. (MIN. 100 C.F.M., MAX.3 SONE, AND VENTED TO OUTSIDE AIR).
- 3. PANTRY.
- 4. 30" BUILT-IN OVEN/ MICROWAVE COMBINATION. 5. 5'-0" PRE-FAB FIBERGLASS TUB/ SHOWER WITH WATER RESISTANT WAINSCOT TO 72" ABOVE DRAIN (UNLESS NOTED OTHERWISE). PROVIDE SHOWER URTAINROD (UNLESS NOTED OTHERWISE)
- 6. HOT-MOP SHOWER W/ TILE. SEE PLAN FOR SIZE. TILE TO 72" ABOVE DRAIN U.N.O. 7. SHATTERPROOF GLASS SHOWER ENCLOSURE. 8. 60" X 42" OVAL DROP-IN TUB WITH TILE WAINSCOT. PROVIDE MOTOR ACCESS
- PANEL AT OPTIONAL SPA / HYDROMASSAGE BATHTUBS. 9. SHOWER SEAT. SEE PLAN FOR HEIGHT.
- 10. LINEN CABINET.
- 11. BUILT-IN SHELVES BY OTHERS. 12. TANKLESS WATER HEATER.
- 13. 14" X 14" SHAMPOO NICHE AT 48" ABV.F.F.
- 14. TEMPERATURE AND PRESSURE RELIEF VALVE.
- 15. 3" DIAMETER BUMPER PIPE 36" HIGH WITH MINIMUM 12" EMBEDMENT. 16. PROVIDE WATER AND WASTE FOR WASHER.
- 17. PROVIDE SMITTY PAN WITH DRAIN BENEATH WASHER.
- 18. DRYER VENT (MAX. 14 FEET LENGTH INCLUDING TWO 90 DEGREE ELBOWS) PER C.M.C. 504.4.2.1. 19. 14"X6" GARAGE EXHAUST VENT. SCREENED AND LOUVERED.
- 20. PLUMBING WASTE DROP FROM ABOVE.
- 21. F.A.U. IN ATTIC. PROVIDE 30" X 30" CLEAR, ATTIC ACCESS PANEL (OR PER C.M.C. 304.4) PROVIDE FUEL GAS, LIGHT AND SWITCH. 22. 22"X30" ROUGH FRAMED ATTIC ACCESS OPENING PER C.R.C R807.1.
- 23. LINE OF DECORATIVE PORCH RAILING. SEE ELEVATIONS. 24. LINE OF EXTERIOR BALCONY GUARD. SEE ELEVATIONS FOR DETAIL. TOP OF
- GUARDS SHALL NOT BE LESS THAN 42" IN HEIGHT, OPEN GUARDS SHALL HAVE INTERMEDIATE RAILS OR AN ORNAMENTAL. PATTERN SUCH THAT A SPHERE 4" IN DIAMETER CANNOT PASS THROUGH PER C.R.C. R312.1.2.
- 25. DUCT CHASE. VERIFY WITH H.V.A.C. DRAWINGS. 26. BALLOON FRAMED WALLS. SEE STRUCTURAL FRAMING PLANS.
- 27. LINE OF CRIPPLE WALL ABOVE.
- 28. LOCATION OF WATER CLOSET AT FLOOR ABOVE.
- 29. PROVIDE 100 SQ. IN. MIN. OPENING FOR MAKE UP AIR AT LAUNDRY ROOM PER C.M.C. 504.4.1. 30. 2X6 STUD WALL.
- 31. PONY WALL, SEE PLAN FOR HEIGHT.
- 32. DIRECT VENT GAS APPLIANCE FIREPLACE IS TO BE COMLIANT AND TESTED UNDER THE 2016 C.R.C. REFERENCED STANDARDS OR PROVIDE A 2015 I.R.C. EVALUATION REPORT, NOVUS NDV4842 OR APPROVED EQ). 33. ECLETRICAL SERVICE PANEL. (SEE UTILITY PLAN). SEE GÉNERAL NOTES FOR GROUNDING INFORMATION.
- 34. NEWEL POST.
- 35. FLAT SOFFIT. SEE PLAN FOR HETGHT OR DETAIL.
- 36. ARCHED SOFFIT. 37. LINE OF FLOOR ABOVE.
- 38. SHELF, SEE PLAN FOR HEIGHT.
- 39. ENCLOSED USABLE SPACED UNDER STAIRS SHALL BE PROTECTED ON
- ENCLOSED SIDE WITH 1/2" GYPSUM BOARD PER C.R.C. R302.7.
- 40. 42" HIGH GUARD PER C.R.C. R312.1.2. 41. 34"-38" HIGH HANDRAIL ABOVE NOISING PER C.R.C. R311.7.8.1.
- 42. LINE OF SYNTHETIC STONE VENEER. SEE ELEVATION.
- 43. LINE OF MASONRY VENEER SEE ELEVATION FOR HEIGHT. SEE SLAB INTERFACE PLAN FOR LENGTH OF RETURN.
- 44. LINE OF +2" WAINSCOT. SEE ELEVATION FOR HEIGHT. 45. LINE OF WAINSCOT FURRING. SEE ELEVATION FOR HEIGHT. SEE SLAB
- INTERFACE PLAN FOR MORE INFORMATION. 46. DOOR OPENINGS BETWEEN A PRIVATE GARAGE AND DWELLING UNTIL SHALL BE EQUIPPED WITH EITHER SOLID WOOD DOORS OR SOLID OR HONEYCOMB CORE STEEL DOORS NOT LESS THAN I 3/8" THICK, OR DOORS IN COMPLIANCE WITH C.R.C. R302.5. DOORS SHALL BE SELF-CLOSING AND SELF-LATCHING.
- 47. SHAMPOO NICHE (12 1/2" X 15 1/2") AT +48". 48. GARAGE BENEATH HABITABLE RÓOM ABOVE SHALL BE SEPARATED BY TYPE 'X' 5/8" GYP. BOARD ON THE GARAGE SIDE.
- 49. 42" PARAPET WALL 50. 5/8" TYPE "X" GYPSUM BOARD WALL AND CEILING UNDER THE INTERIOR STAIRWAY.
- 51. AUTOMATIC GARAGE DOOR OPENER SHALL BE LISTED AND LABELED IN ACCORDANCE WITH UL 325.
- 52. 5/8" TYPE "X" GYP. BOARD 1-HOUR WALL & CEILING.

DOOR PLAN NOTE

- 1. ALL INTERIOR DOORS TO BE HOLLOW CORE I 3/8" THICK UNLESS NOTED OTHERWISE, (SEE PLAN FOR SIZE), AT DOULBE INTERIOR DOOR CONDITIONS PROVIDE DEADBOLT AT TOP OF INACTIVE DOOR.
- 2. ALL GARAGE SERVICE DOORS TO BE HOLLOW CORE I 3/4" THICK EXTERIOR GRADE. (SEE PLAN FOR SIZE) 3. ALL ENTRY DOORS TO BE SOLID CORE I 3/4" THICK (SEE PLAN FOR SIZE), AT
- DOULE ENTRY DOORS PROVIDE DEADBOLT AT TOP AND BOTTOM OF INACTIVE DOOR 4. ALL EXTERIOR FRENCH DOORS TO BE SOLID CORE I 3/4" THICK (SEE PLAN FOR
- SIZE), AT DOULE FRENCH DOORS PROVIDE DEADBOLT AT TOP AND BOTTOM OF INACTIVE DOOR.
- 5. EMERGENCY ESCAPE AND RESCUE OPENINGS SHALL HAVE A NET CLEAR OPENING OF 5.7 S.F. THE NET CLEAR OPENING DIMENSIONS REQUIRED BY THIS SECTION SHALL BE OBTAINED BY THE NORMAL OPERATION OF THE EMERGENCY ESCAPE AND RESCUE OPENING FROM THE INSIDE. THE NET CLEAR HEIGHT OPENING SHALL BE NOT LESS THAN 24 INCHES AND THE NET CLEAR WIDTH SHALL BE NOT LESS THAN 20 INCHES. EXCEPTION : GRADE FLOOR OR BELOW GRADE OPENINGS SHALL HAVE A NET CLEAR OPENING OF NOT LESS THAN 5 SQUARE FEET. (C.R.C. R310.2.1) EMERGENCY ESCAPE AND RESCUE OPENING SHALL HAVE A SILL HEIGHT
- NOT MORE THAN 44" ABOVE THE FLOOR. (C.R.C.R310.2.2) 6. WINDOW FALL PROTECTION: WHEN TOP OF THE WINDOW SILL IS LOCATED LESS THAN 24 INCHES ABOVE THE FINISH FLOOR AND GREATER THAN 72 INCHES ABOVE THE FINISHED GRADE OR OTHER SURFACE BELOW ON THE EXTERIOR OF THE BUILDING, THE OPERABLE WINDOW SHALL COMPLY WITH THE R312.2.1 (1), (2) & (3).

SLAB INTERFACE NOTES

- 1. 36" SQUARE CONCRETE STOOP.(SLOPE MIN. 1/4 PER FOOT)
- 2. CONCRETE STOOP, SEE PLAN FOR SIZE AND LOCATION. (SLOPE MIN. 1/4" PER FOOT
- 3. CONCRETE PORCH/ PATIO. (SLOPE MIN. 1/4" PER FOOT)
- 4. 36" WIDE CONCRETE WALK.
- 5. PROVIDE CONDUIT UNDER SLAB FOR ISLAND COUNTER ELECTRICAL. 6. PROVIDE WATER LINE SLEEVE FROM KITCHEN SINK TO REFRIG. FOR ICE MAKER. 7. PROVIDE TOE FTG, FOR MASONRY VENEER TYP.
- 8. RAISED ENTRY, SEE PLAN FOR HEIGHT AND EXTENT.

GENERAL SLAB NOTES

INDICATES DROP IN SLAB (SEE DETAIL)

- 1. VERIFY MINIMUM FOUNDATION DEPTH, WIDTH, REINFORCING STEEL AND ADDITIONAL EXPANSIVE SOIL REQUIREMENTS WITH THE SOIL REPORT.
- 2. REFER TO STRUCTURAL ENGINEERING DRAWINGS FOR INFORMATION NOT SHOWN HERE.
- 3. FOR HARDSCAPE INFORMATION REFER TO LANSCAPE PLANS. 4. COURTYARDS PROVIDE POSITIVE DRAINAGE AWAY FROM BUILDING(S) TO SURFACE AREA DRAINS.
- 5. COURTYARDS DRAIN LOCATIONS TO BE DETERMINED BY CIVIL ENGINEER, SEE PRECISE GRADING PLANS FOR LOCATION. 6. WHEN REQUIRED BY SOILS ENGINEER OR OTHERS, TIE COURTYARD DRAINS AND
- ROOF DOWNSPOUTS INTO SITE AREA DRAINS.

STAMP:



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SINGLE FAMILY HOUSE

16492 BARNSTABLE CIRCLE HUNTINGTON BEACH, CA 92649

RUBICON INVESTMENT **PROPERTIES LLC**

16492 BARNSTABLE CIRCLE HUNTINGTON BEACH, CA 92649 Tel: (714) 856 5977

BUILDING DEPARTMENT SUBMITTAL

REVISIONS:

∕1∖ 9/22/2021

Planning Correction

PROJECT DIRECTOR: JOB CAPTAIN: SENIOR ASSOCIATE: ASSOCIATES: **PROJECT NUMBER:** PROJECT CAD FILE:

SHEET TITLE: FIRST FLOOR PLAN

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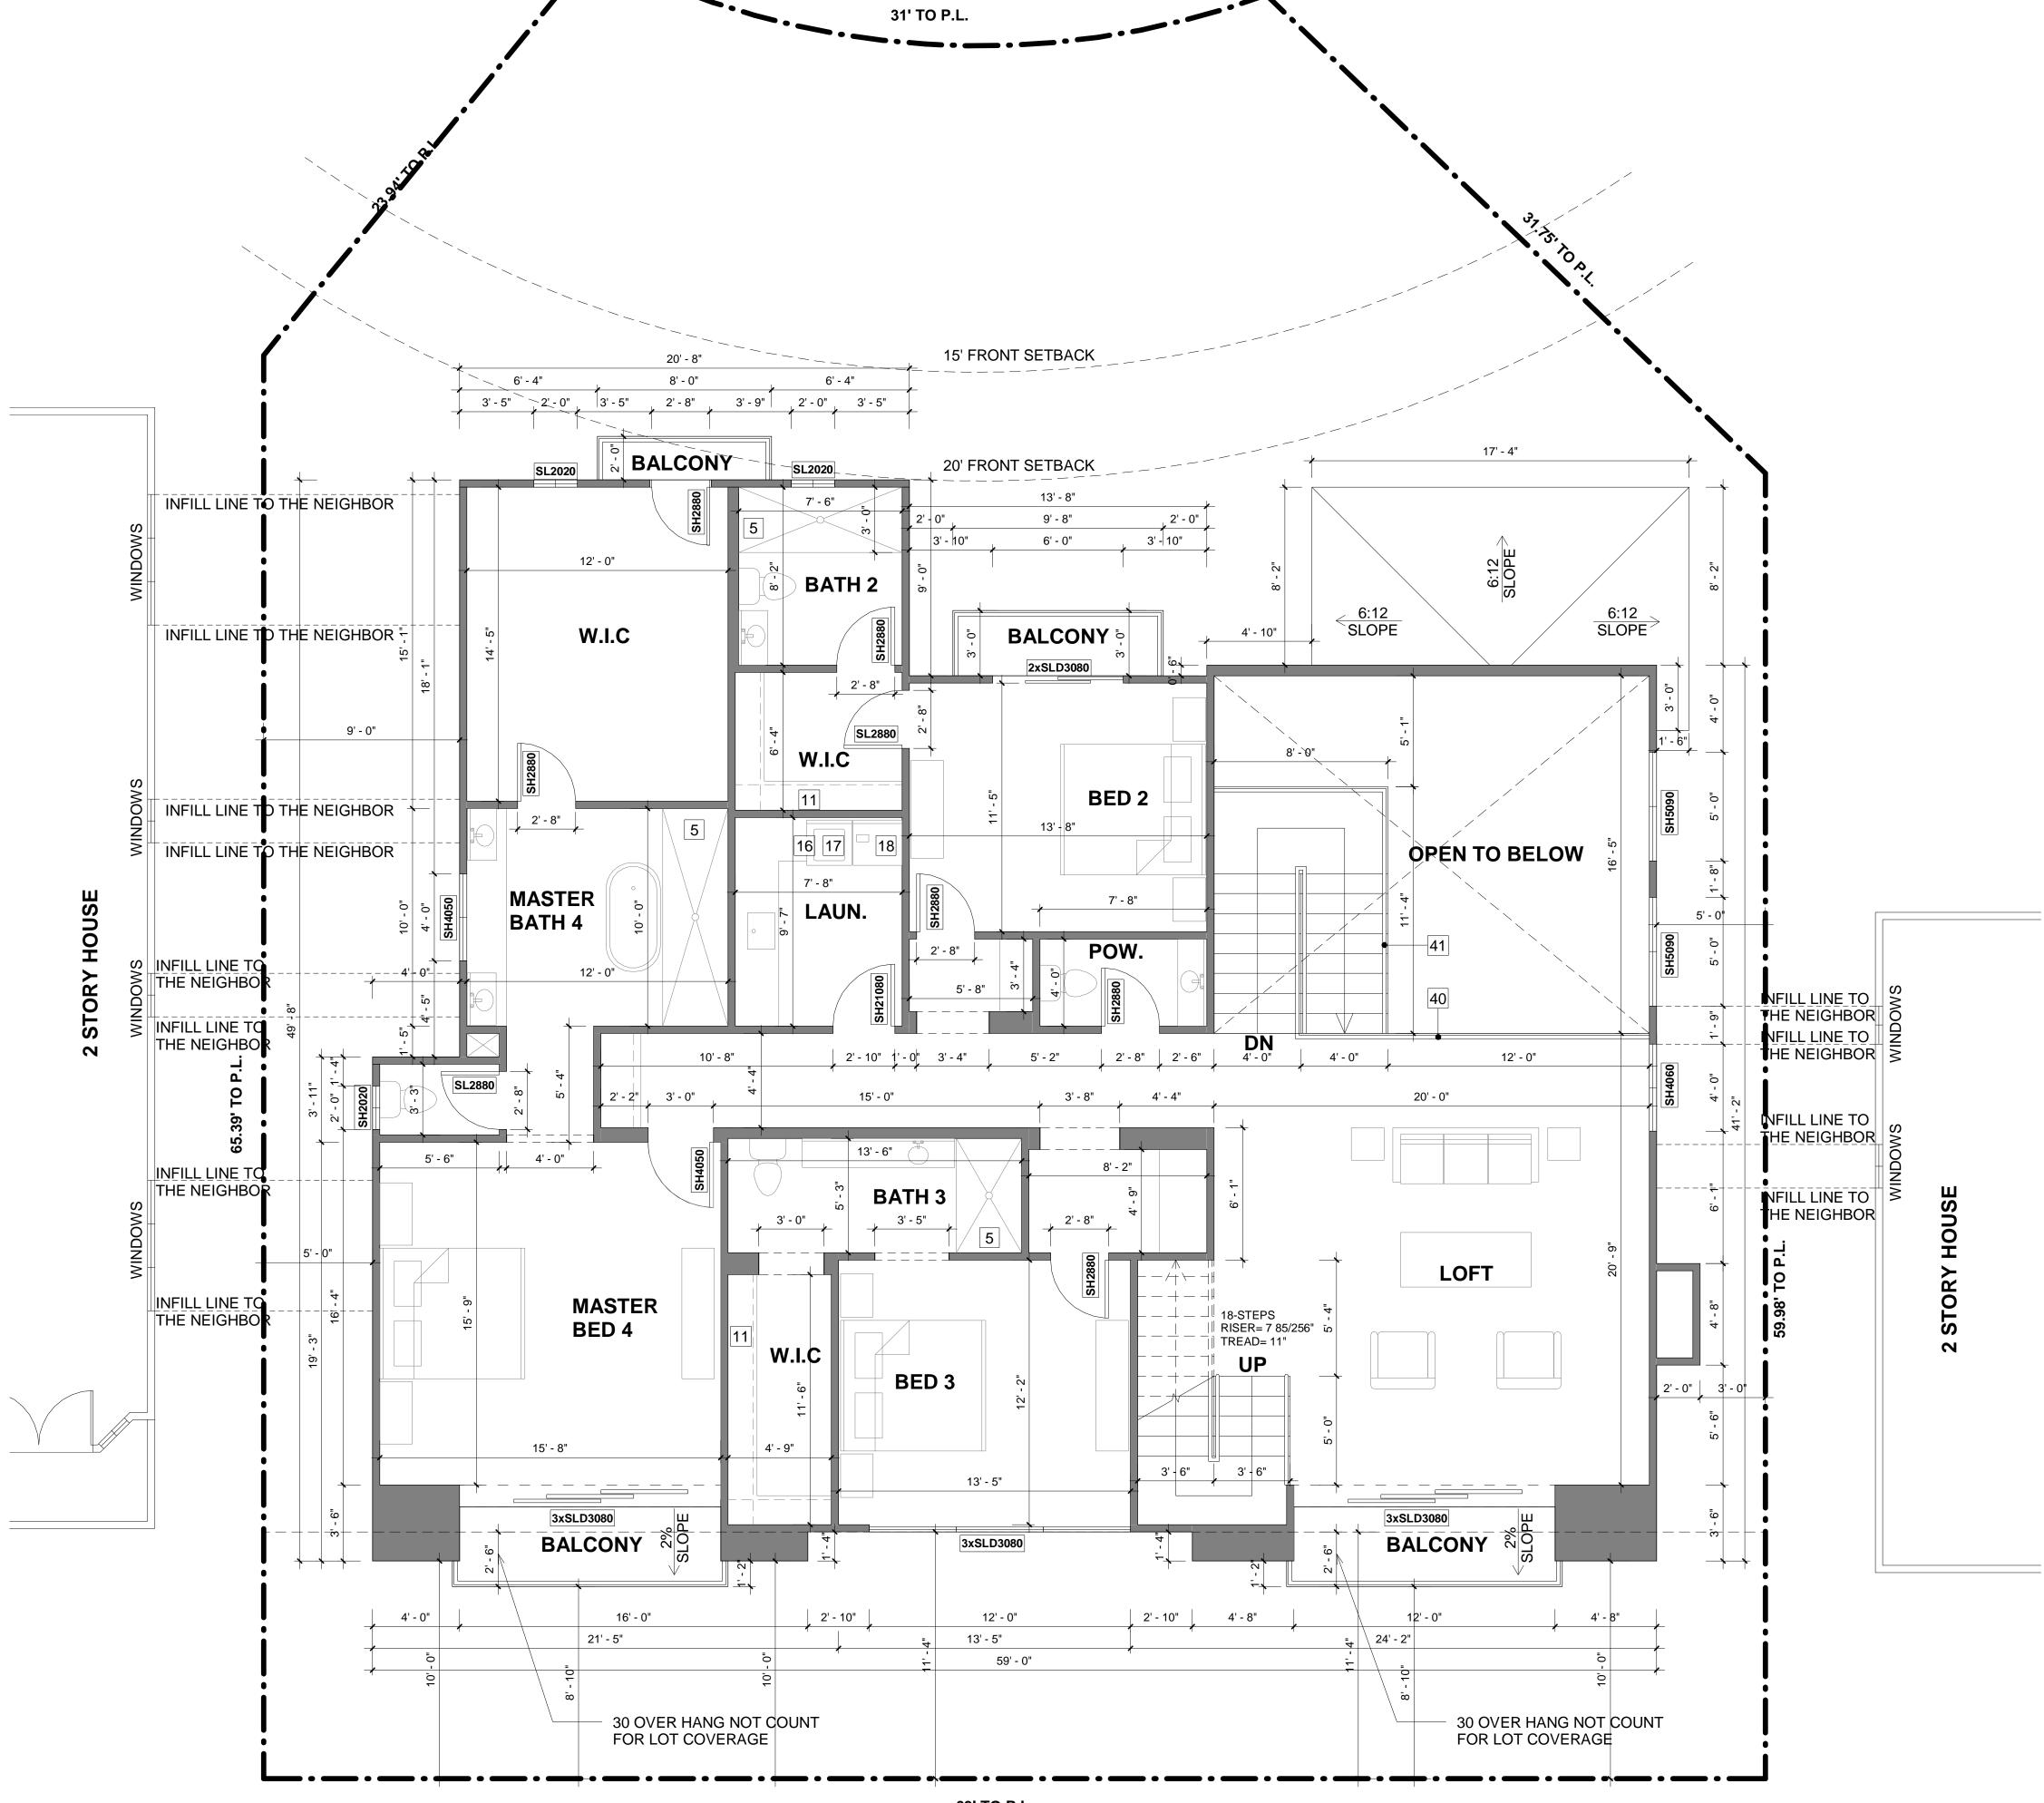
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Z PLOT REFERENCE DATE:

04/13/21





SECOND FLOOR PLAN



FLOOR PLAN NOTE

- 1. 48" CLEAR REFRIGERATOR SPACE. PLUMB FOR WATER SUPPLY. VERIFY WIDTH AND DEPTH IF BUILT- IN REFRIGERATOR.
- 2. 36" COOKTOP AND METAL EXHAUST HOOD ABV. W/ LIGHT AND FAN. (MIN. 100 C.F.M., MAX.3 SONE, AND VENTED TO OUTSIDE AIR). 3. PANTRY.
- 4. 30" BUILT-IN OVEN/ MICROWAVE COMBINATION.
- 5. 5'-0" PRE-FAB FIBERGLASS TUB/ SHOWER WITH WATER RESISTANT WAINSCOT TO 72" ABOVE DRAIN (UNLESS NOTED OTHERWISE). PROVIDE SHOWER URTAINROD (UNLESS NOTED OTHERWISE)
- 6. HOT-MOP SHOWER W/ TILE. SEE PLAN FOR SIZE. TILE TO 72" ABOVE DRAIN U.N.O. 7. SHATTERPROOF GLASS SHOWER ENCLOSURE. 8. 60" X 42" OVAL DROP-IN TUB WITH TILE WAINSCOT. PROVIDE MOTOR ACCESS
- PANEL AT OPTIONAL SPA / HYDROMASSAGE BATHTUBS. 9. SHOWER SEAT. SEE PLAN FOR HEIGHT.
- 10. LINEN CABINET.
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- 13. 14" X 14" SHAMPOO NICHE AT 48" ABV.F.F.
- 14. TEMPERATURE AND PRESSURE RELIEF VALVE. 15. 3" DIAMETER BUMPER PIPE 36" HIGH WITH MINIMUM 12" EMBEDMENT.
- 16. PROVIDE WATER AND WASTE FOR WASHER.
- 17. PROVIDE SMITTY PAN WITH DRAIN BENEATH WASHER.
- 18. DRYER VENT (MAX. 14 FEET LENGTH INCLUDING TWO 90 DEGREE ELBOWS) PER C.M.C. 504.4.2.1. 19. 14"X6" GARAGE EXHAUST VENT. SCREENED AND LOUVERED.
- 20. PLUMBING WASTE DROP FROM ABOVE.
- 21. F.A.U. IN ATTIC. PROVIDE 30" X 30" CLEAR, ATTIC ACCESS PANEL (OR PER C.M.C. 304.4) PROVIDE FUEL GAS, LIGHT AND SWITCH. 22. 22"X30" ROUGH FRAMED ATTIC ACCESS OPENING PER C.R.C R807.1.
- 23. LINE OF DECORATIVE PORCH RAILING. SEE ELEVATIONS. 24. LINE OF EXTERIOR BALCONY GUARD. SEE ELEVATIONS FOR DETAIL. TOP OF
- GUARDS SHALL NOT BE LESS THAN 42" IN HEIGHT. OPEN GUARDS SHALL HAVE INTERMEDIATE RAILS OR AN ORNAMENTAL. PATTERN SUCH THAT A SPHERE 4" IN DIAMETER CANNOT PASS THROUGH PER C.R.C. R312.1.2.
- 25. DUCT CHASE. VERIFY WITH H.V.A.C. DRAWINGS. 26. BALLOON FRAMED WALLS. SEE STRUCTURAL FRAMING PLANS.
- 27. LINE OF CRIPPLE WALL ABOVE.
- 28. LOCATION OF WATER CLOSET AT FLOOR ABOVE.
- 29. PROVIDE 100 SQ. IN. MIN. OPENING FOR MAKE UP AIR AT LAUNDRY ROOM PER C.M.C. 504.4.1. 30. 2X6 STUD WALL.
- 31. PONY WALL. SEE PLAN FOR HEIGHT.
- 32. DIRECT VENT GAS APPLIANCE FIREPLACE IS TO BE COMLIANT AND TESTED UNDER THE 2016 C.R.C. REFERENCED STANDARDS OR PROVIDE A 2015 I.R.C. EVALUATION REPORT. NOVUS NDV4842 OR APPROVED EQ). 33. ECLETRICAL SERVICE PANEL. (SEE UTILITY PLAN). SEE GÉNERAL NOTES FOR GROUNDING INFORMATION.
- 34. NEWEL POST.
- 35. FLAT SOFFIT. SEE PLAN FOR HETGHT OR DETAIL. 36. ARCHED SOFFIT.
- 37. LINE OF FLOOR ABOVE.
- 38. SHELF, SEE PLAN FOR HEIGHT.
- 39. ENCLOSED USABLE SPACED UNDER STAIRS SHALL BE PROTECTED ON
- ENCLOSED SIDE WITH 1/2" GYPSUM BOARD PER C.R.C. R302.7.
- 40. 42" HIGH GUARD PER C.R.C. R312.1.2. 41. 34"-38" HIGH HANDRAIL ABOVE NOISING PER C.R.C. R311.7.8.1.
- 42. LINE OF SYNTHETIC STONE VENEER. SEE ELEVATION.
- 43. LINE OF MASONRY VENEER SEE ELEVATION FOR HEIGHT. SEE SLAB INTERFACE PLAN FOR LENGTH OF RETURN.
- 44. LINE OF +2" WAINSCOT. SEE ELEVATION FOR HEIGHT. 45. LINE OF WAINSCOT FURRING. SEE ELEVATION FOR HEIGHT. SEE SLAB INTERFACE PLAN FOR MORE INFORMATION.
- 46. DOOR OPENINGS BETWEEN A PRIVATE GARAGE AND DWELLING UNTIL SHALL BE EQUIPPED WITH EITHER SOLID WOOD DOORS OR SOLID OR HONEYCOMB CORE STEEL DOORS NOT LESS THAN I 3/8" THICK, OR DOORS IN COMPLIANCE WITH C.R.C. R302.5. DOORS SHALL BE SELF-CLOSING AND SELF-LATCHING. 47. SHAMPOO NICHE (12 1/2" X 15 1/2") AT +48".
- 48. GARAGE BENEATH HABITABLE ROOM ABOVE SHALL BE SEPARATED BY TYPE 'X' 5/8" GYP. BOARD ON THE GARAGE SIDE. 49. 42" PARAPET WALL.
- 50. 5/8" TYPE "X" GYPSUM BOARD WALL AND CEILING UNDER THE INTERIOR STAIRWAY.

51. AUTOMATIC GARAGE DOOR OPENER SHALL BE LISTED AND LABELED IN ACCORDANCE WITH UL 325. 52. 5/8" TYPE "X" GYP. BOARD 1-HOUR WALL & CEILING.

DOOR PLAN NOTE

- 1. ALL INTERIOR DOORS TO BE HOLLOW CORE I 3/8" THICK UNLESS NOTED OTHERWISE, (SEE PLAN FOR SIZE), AT DOULBE INTERIOR DOOR CONDITIONS PROVIDE DEADBOLT AT TOP OF INACTIVE DOOR.
- 2. ALL GARAGE SERVICE DOORS TO BE HOLLOW CORE I 3/4" THICK EXTERIOR GRADE. (SEE PLAN FOR SIZE) 3. ALL ENTRY DOORS TO BE SOLID CORE I 3/4" THICK (SEE PLAN FOR SIZE), AT
- DOULE ENTRY DOORS PROVIDE DEADBOLT AT TOP AND BOTTOM OF INACTIVE DOOR 4. ALL EXTERIOR FRENCH DOORS TO BE SOLID CORE I 3/4" THICK (SEE PLAN FOR
- SIZE), AT DOULE FRENCH DOORS PROVIDE DEADBOLT AT TOP AND BOTTOM OF INACTIVE DOOR.
- 5. EMERGENCY ESCAPE AND RESCUE OPENINGS SHALL HAVE A NET CLEAR OPENING OF 5.7 S.F. THE NET CLEAR OPENING DIMENSIONS REQUIRED BY THIS SECTION SHALL BE OBTAINED BY THE NORMAL OPERATION OF THE EMERGENCY ESCAPE AND RESCUE OPENING FROM THE INSIDE. THE NET CLEAR HEIGHT OPENING SHALL BE NOT LESS THAN 24 INCHES AND THE NET CLEAR WIDTH SHALL BE NOT LESS THAN 20 INCHES. EXCEPTION : GRADE FLOOR OR BELOW GRADE OPENINGS SHALL HAVE A NET CLEAR OPENING OF NOT LESS THAN 5 SQUARE FEET. (C.R.C. R310.2.1) EMERGENCY ESCAPE AND RESCUE OPENING SHALL HAVE A SILL HEIGHT
- NOT MORE THAN 44" ABOVE THE FLOOR. (C.R.C.R310.2.2) 6. WINDOW FALL PROTECTION: WHEN TOP OF THE WINDOW SILL IS LOCATED LESS THAN 24 INCHES ABOVE THE FINISH FLOOR AND GREATER THAN 72 INCHES ABOVE THE FINISHED GRADE OR OTHER SURFACE BELOW ON THE EXTERIOR OF THE BUILDING, THE OPERABLE WINDOW SHALL COMPLY WITH THE R312.2.1 (1), (2) & (3).

SLAB INTERFACE NOTES

- 1. 36" SQUARE CONCRETE STOOP.(SLOPE MIN. 1/4 PER FOOT) 2. CONCRETE STOOP, SEE PLAN FOR SIZE AND LOCATION. (SLOPE MIN. 1/4" PER FOOT
- 3. CONCRETE PORCH/ PATIO.(SLOPE MIN. 1/4" PER FOOT)
- 4. 36" WIDE CONCRETE WALK.
- 5. PROVIDE CONDUIT UNDER SLAB FOR ISLAND COUNTER ELECTRICAL. 6. PROVIDE WATER LINE SLEEVE FROM KITCHEN SINK TO REFRIG. FOR ICE MAKER. 7. PROVIDE TOE FTG, FOR MASONRY VENEER TYP.
- 8. RAISED ENTRY, SEE PLAN FOR HEIGHT AND EXTENT.

GENERAL SLAB NOTES

INDICATES DROP IN SLAB (SEE DETAIL)

- 1. VERIFY MINIMUM FOUNDATION DEPTH, WIDTH, REINFORCING STEEL AND ADDITIONAL EXPANSIVE SOIL REQUIREMENTS WITH THE SOIL REPORT.
- 2. REFER TO STRUCTURAL ENGINEERING DRAWINGS FOR INFORMATION NOT SHOWN HFRF 3. FOR HARDSCAPE INFORMATION REFER TO LANSCAPE PLANS.
- 4. COURTYARDS PROVIDE POSITIVE DRAINAGE AWAY FROM BUILDING(S) TO SURFACE AREA DRAINS.
- 5. COURTYARDS DRAIN LOCATIONS TO BE DETERMINED BY CIVIL ENGINEER, SEE PRECISE GRADING PLANS FOR LOCATION.
- 6. WHEN REQUIRED BY SOILS ENGINEER OR OTHERS, TIE COURTYARD DRAINS AND ROOF DOWNSPOUTS INTO SITE AREA DRAINS.

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BUILDING DEPARTMENT SUBMITTAL

REVISIONS:

PROJECT DIRECTOR: JOB CAPTAIN: SENIOR ASSOCIATE: ASSOCIATES: **PROJECT NUMBER: PROJECT CAD FILE:**

SHEET TITLE:

SECOND FLOOR PLAN

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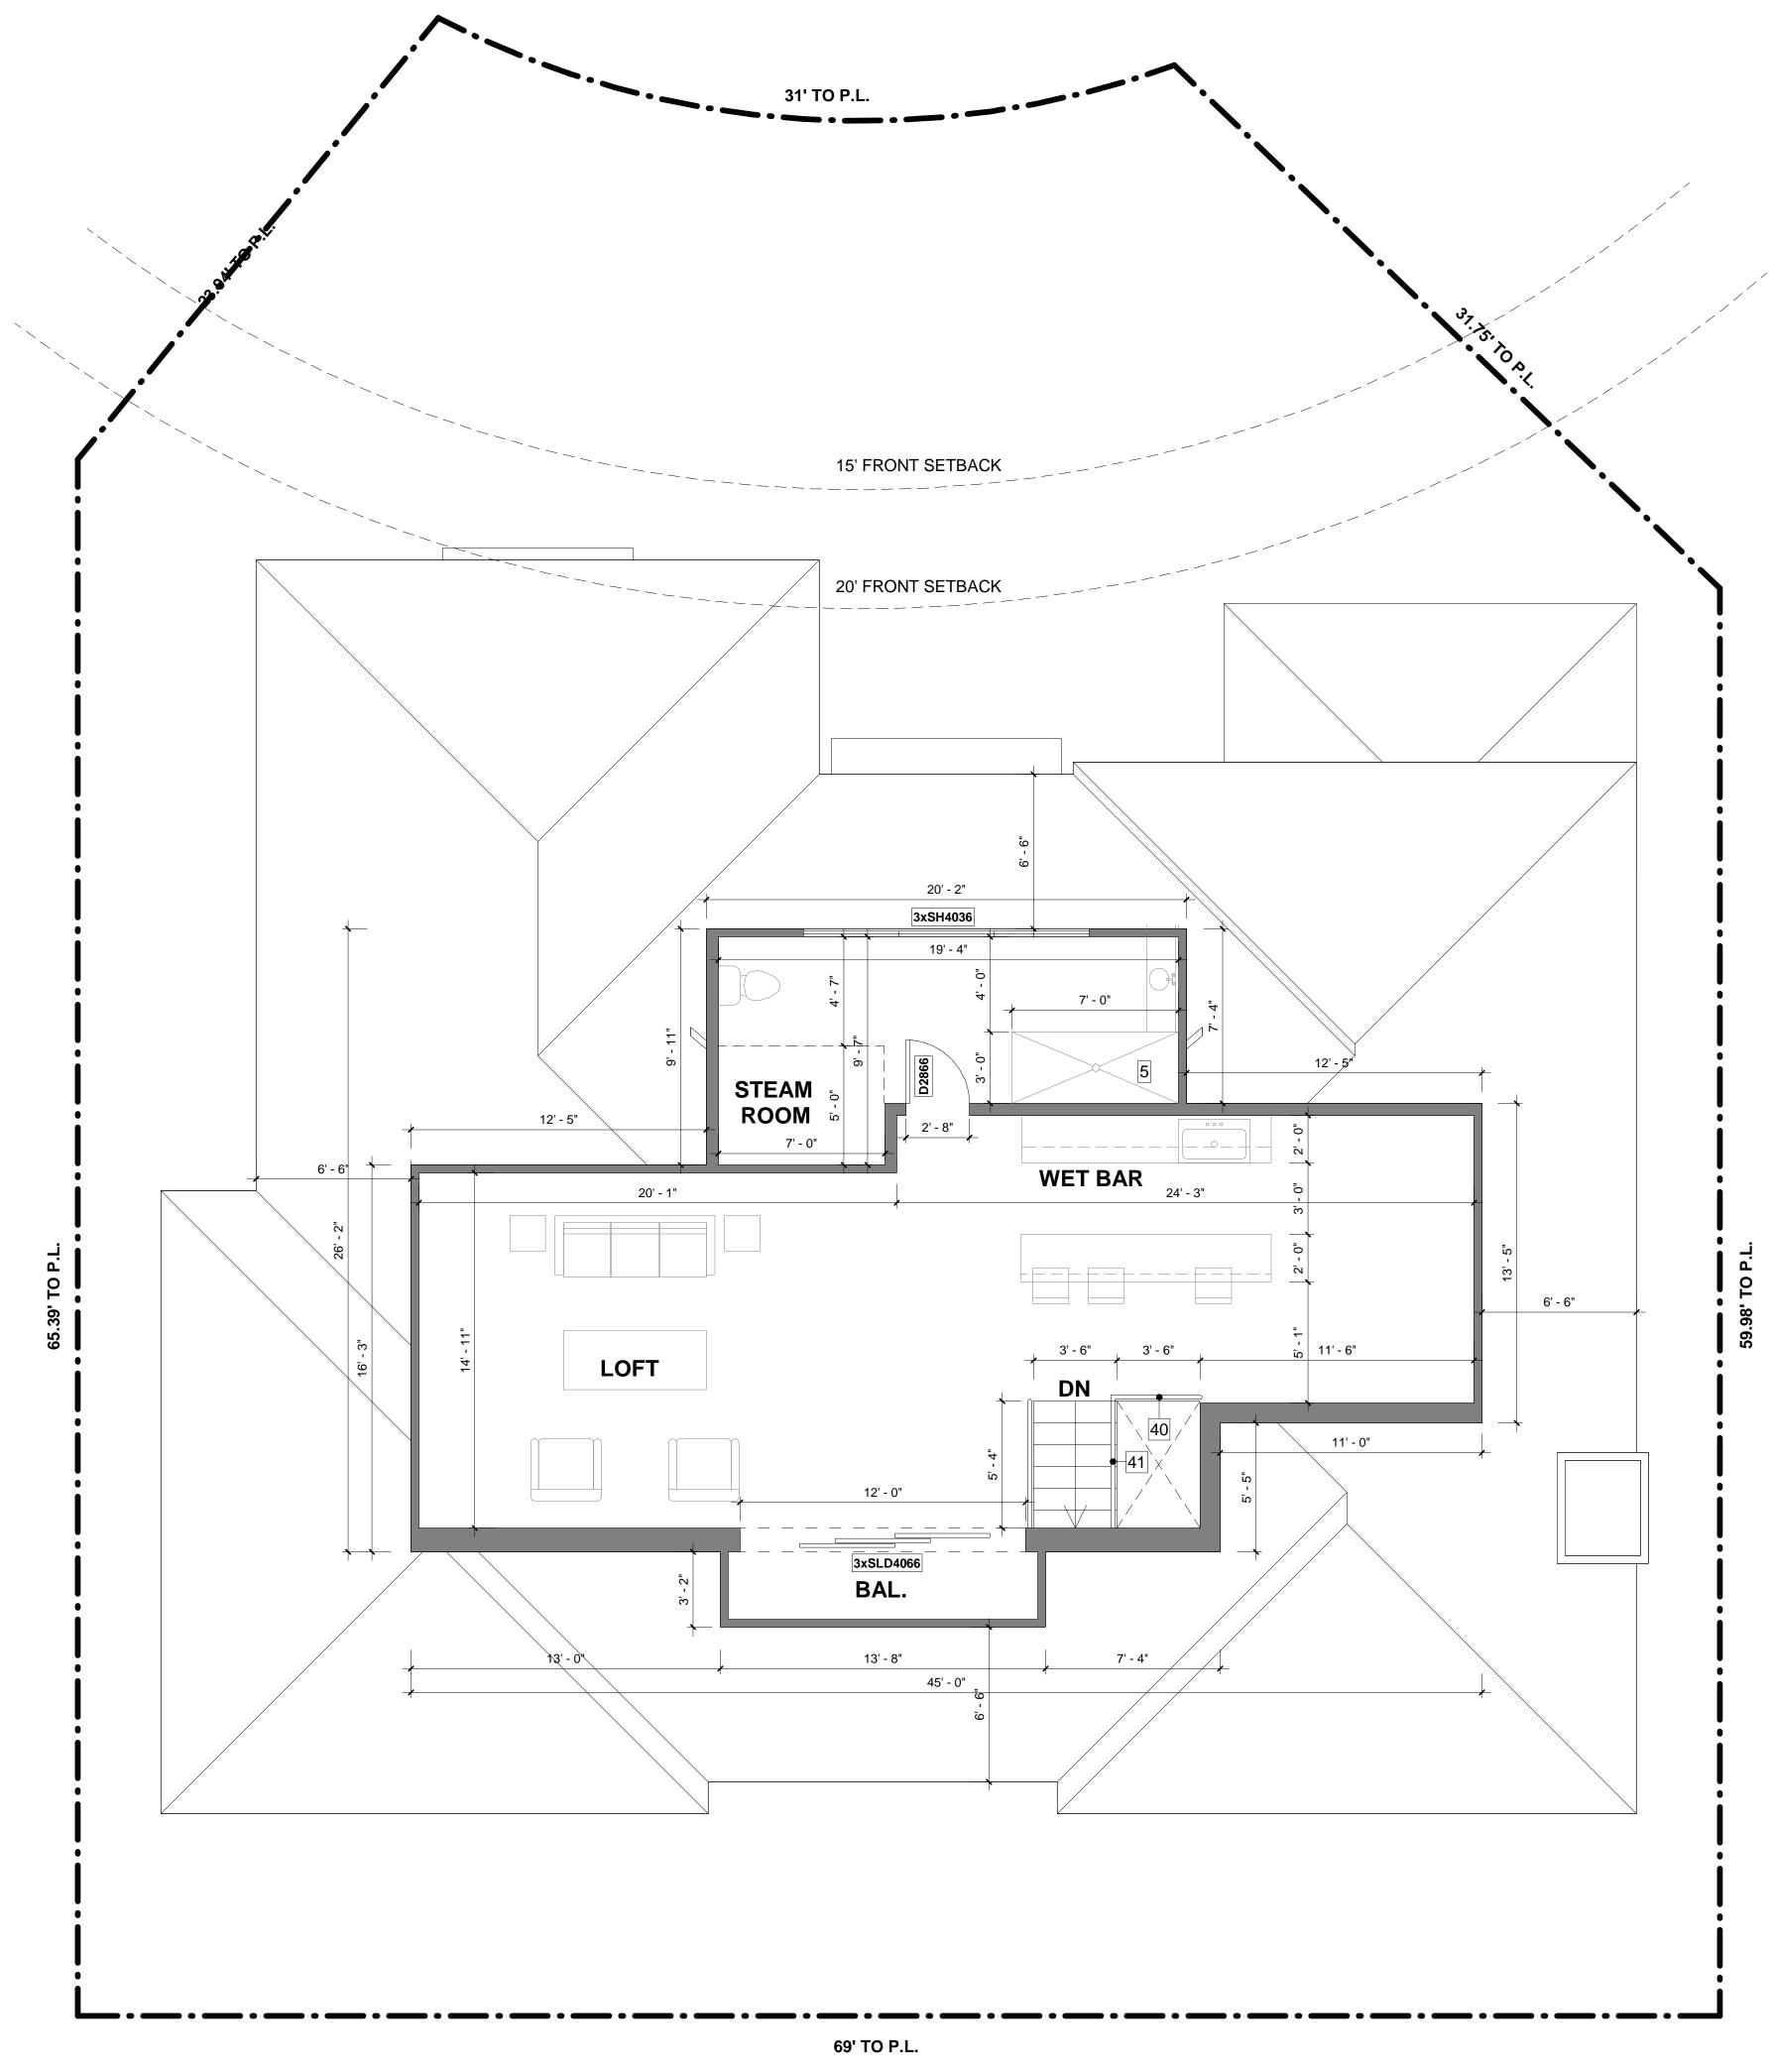
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THIRD FLOOR PLAN

FLOOR PLAN NOTE

- 1. 48" CLEAR REFRIGERATOR SPACE. PLUMB FOR WATER SUPPLY. VERIFY WIDTH AND DEPTH IF BUILT- IN REFRIGERATOR.
- 2. 36" COOKTOP AND METAL EXHAUST HOOD ABV. W/ LIGHT AND FAN. (MIN. 100 C.F.M., MAX.3 SONE, AND VENTED TO OUTSIDE AIR).
- 3. PANTRY.
- 4. 30" BUILT-IN OVEN/ MICROWAVE COMBINATION. 5. 5'-0" PRE-FAB FIBERGLASS TUB/ SHOWER WITH WATER RESISTANT WAINSCOT TO 72" ABOVE DRAIN (UNLESS NOTED OTHERWISE). PROVIDE SHOWER URTAINROD (UNLESS NOTED OTHERWISE)
- 6. HOT-MOP SHOWER W/ TILE. SEE PLAN FOR SIZE. TILE TO 72" ABOVE DRAIN U.N.O. 7. SHATTERPROOF GLASS SHOWER ENCLOSURE. 8. 60" X 42" OVAL DROP-IN TUB WITH TILE WAINSCOT. PROVIDE MOTOR ACCESS
- PANEL AT OPTIONAL SPA / HYDROMASSAGE BATHTUBS. 9. SHOWER SEAT. SEE PLAN FOR HEIGHT.
- 10. LINEN CABINET.
- 11. BUILT-IN SHELVES BY OTHERS. 12. TANKLESS WATER HEATER.
- 13. 14" X 14" SHAMPOO NICHE AT 48" ABV.F.F.
- 14. TEMPERATURE AND PRESSURE RELIEF VALVE. 15. 3" DIAMETER BUMPER PIPE 36" HIGH WITH MINIMUM 12" EMBEDMENT.
- 16. PROVIDE WATER AND WASTE FOR WASHER.
- 17. PROVIDE SMITTY PAN WITH DRAIN BENEATH WASHER.
- 18. DRYER VENT (MAX. 14 FEET LENGTH INCLUDING TWO 90 DEGREE ELBOWS) PER C.M.C. 504.4.2.1. 19. 14"X6" GARAGE EXHAUST VENT. SCREENED AND LOUVERED.
- 20. PLUMBING WASTE DROP FROM ABOVE.
- 21. F.A.U. IN ATTIC. PROVIDE 30" X 30" CLEAR, ATTIC ACCESS PANEL (OR PER C.M.C. 304.4) PROVIDE FUEL GAS, LIGHT AND SWITCH. 22. 22"X30" ROUGH FRAMED ATTIC ACCESS OPENING PER C.R.C R807.1.
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- GUARDS SHALL NOT BE LESS THAN 42" IN HEIGHT. OPEN GUARDS SHALL HAVE INTERMEDIATE RAILS OR AN ORNAMENTAL. PATTERN SUCH THAT A SPHERE 4" IN DIAMETER CANNOT PASS THROUGH PER C.R.C. R312.1.2.
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- 47. SHAMPOO NICHE (12 1/2" X 15 1/2") AT +48". 48. GARAGE BENEATH HABITABLE RÓOM ABOVE SHALL BE SEPARATED BY TYPE 'X' 5/8" GYP. BOARD ON THE GARAGE SIDE.
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- 2. ALL GARAGE SERVICE DOORS TO BE HOLLOW CORE I 3/4" THICK EXTERIOR GRADE. (SEE PLAN FOR SIZE) 3. ALL ENTRY DOORS TO BE SOLID CORE I 3/4" THICK (SEE PLAN FOR SIZE), AT
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SLAB INTERFACE NOTES

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- 2. CONCRETE STOOP, SEE PLAN FOR SIZE AND LOCATION. (SLOPE MIN. 1/4" PER FOOT
- 3. CONCRETE PORCH/ PATIO.(SLOPE MIN. 1/4" PER FOOT)
- 4. 36" WIDE CONCRETE WALK.
- 5. PROVIDE CONDUIT UNDER SLAB FOR ISLAND COUNTER ELECTRICAL. 6. PROVIDE WATER LINE SLEEVE FROM KITCHEN SINK TO REFRIG. FOR ICE MAKER. 7. PROVIDE TOE FTG, FOR MASONRY VENEER TYP.
- 8. RAISED ENTRY, SEE PLAN FOR HEIGHT AND EXTENT.

GENERAL SLAB NOTES



INDICATES DROP IN SLAB (SEE DETAIL)

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- 3. FOR HARDSCAPE INFORMATION REFER TO LANSCAPE PLANS. 4. COURTYARDS PROVIDE POSITIVE DRAINAGE AWAY FROM BUILDING(S) TO SURFACE AREA DRAINS.
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- 6. WHEN REQUIRED BY SOILS ENGINEER OR OTHERS, TIE COURTYARD DRAINS AND ROOF DOWNSPOUTS INTO SITE AREA DRAINS.

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BUILDING DEPARTMENT SUBMITTAL

REVISIONS:

PROJECT DIRECTOR: JOB CAPTAIN: SENIOR ASSOCIATE: ASSOCIATES: **PROJECT NUMBER:** PROJECT CAD FILE:

SHEET TITLE: THIRD FLOOR PLAN

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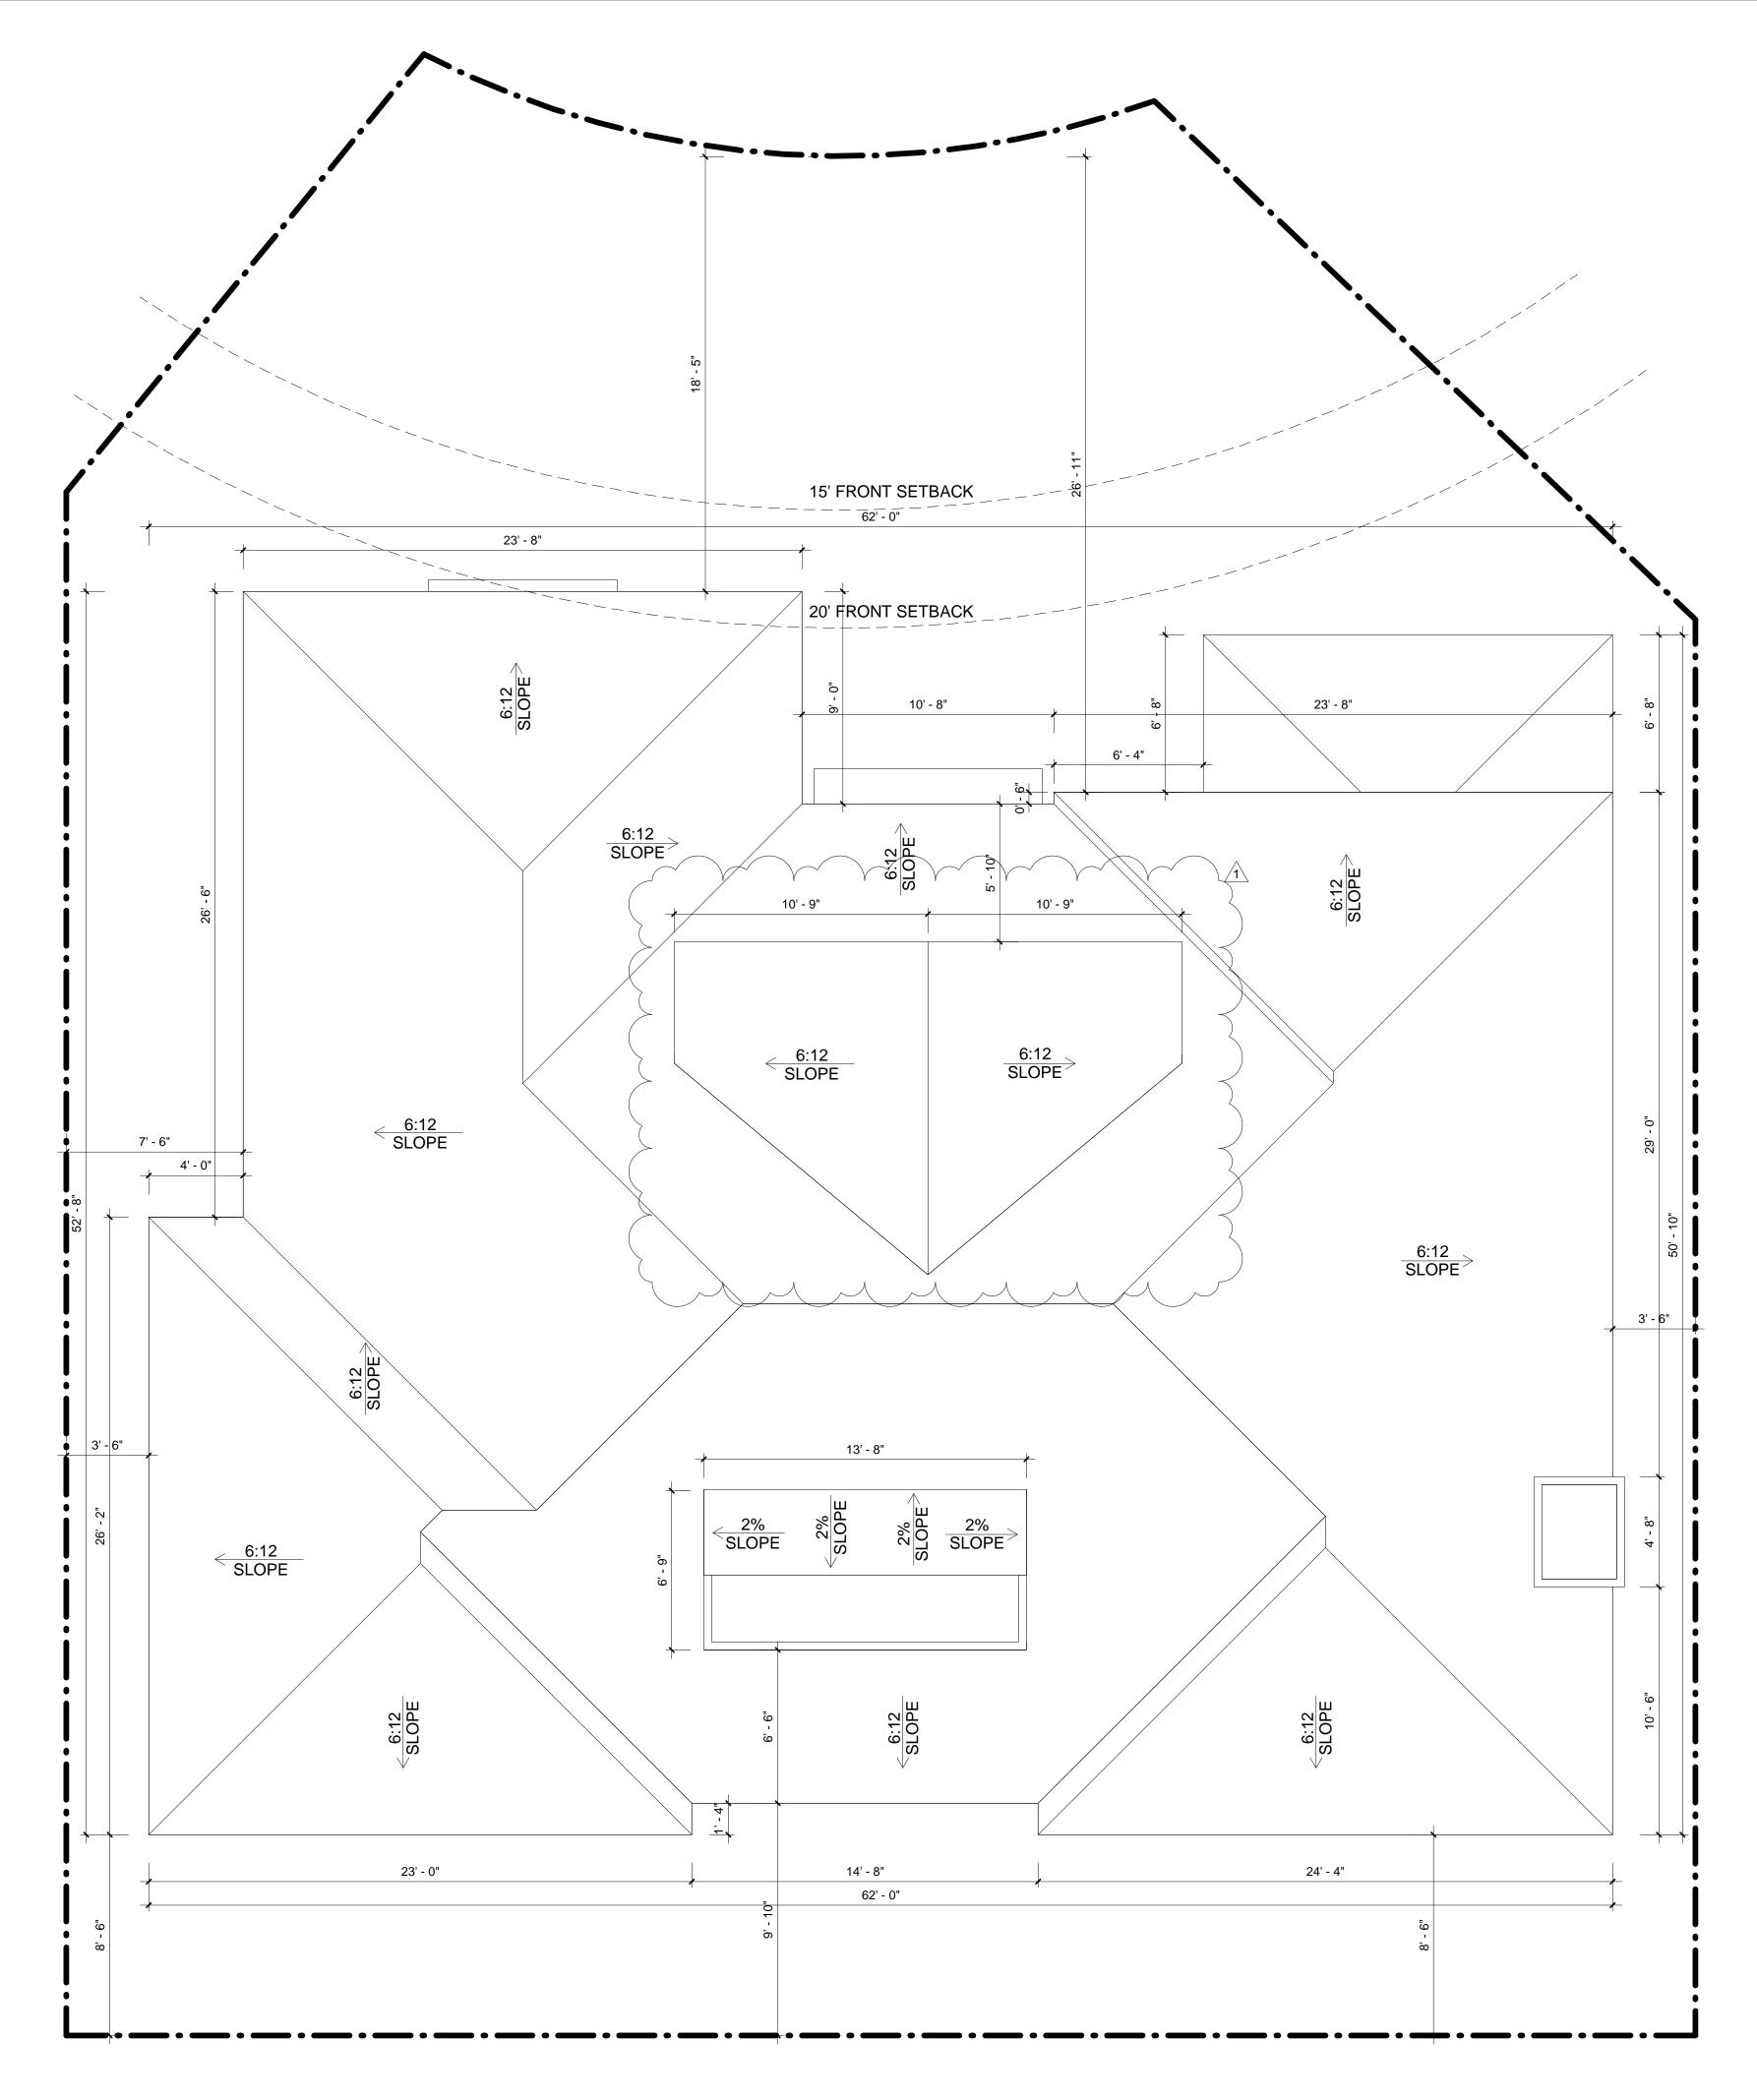
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ROOF PLAN SCALE: 1/4" = 1'-0"

ROOF PLAN NOTES

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- TYPICAL ROOFING TO BE : CONCRETE 'S; TILE (ELE. 'A') CLASS 'A' BY EAGLE ROOFING ESR-1900 OR APPROVED EQUAL. TYPICAL ROOF OVERHANG AT RAKE CONDITION TO BE TIGHT UNLESS
- NOTE OTHERWISE ON ROOF PLAN. TYPICAL ROOF OVERHANG AT EAVE CONDITION TO BE 24" UNLESS NOTED OTHERWISE ON ROOF PLAN. INSTALLATION OF ROOFING SHALL BE IN ACCORDANCE WITH MANUFACTURERS SPECIFICATIONS.



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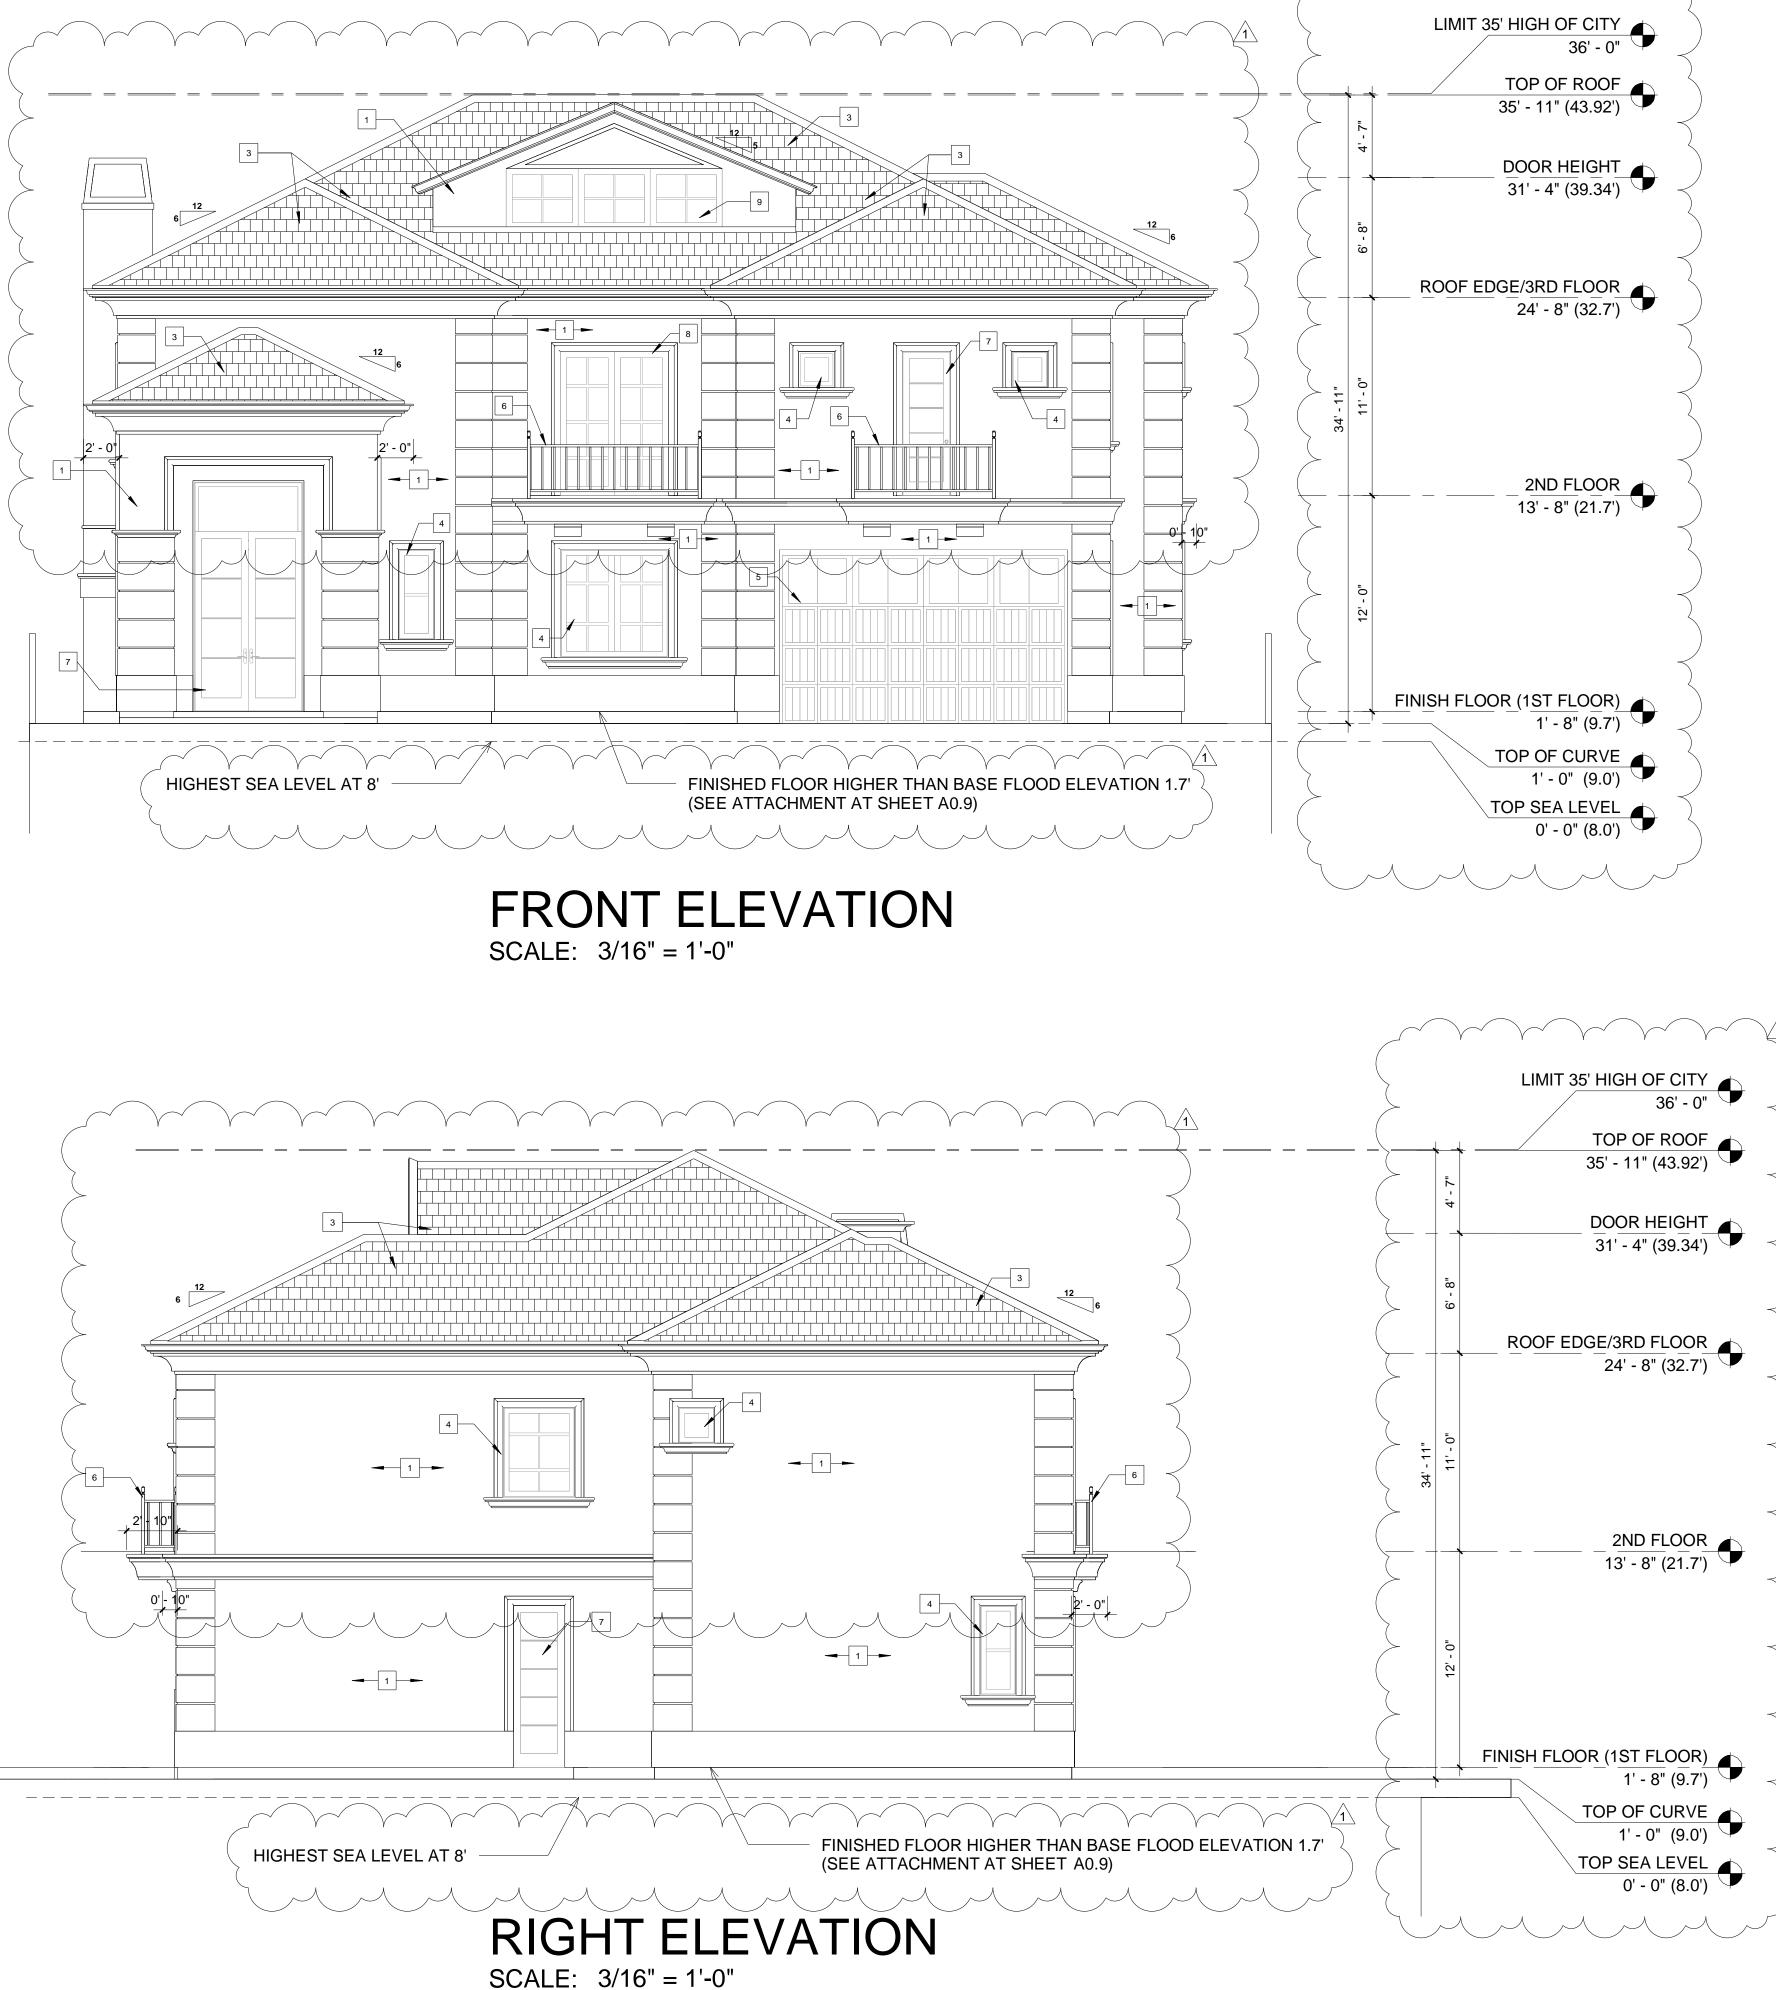
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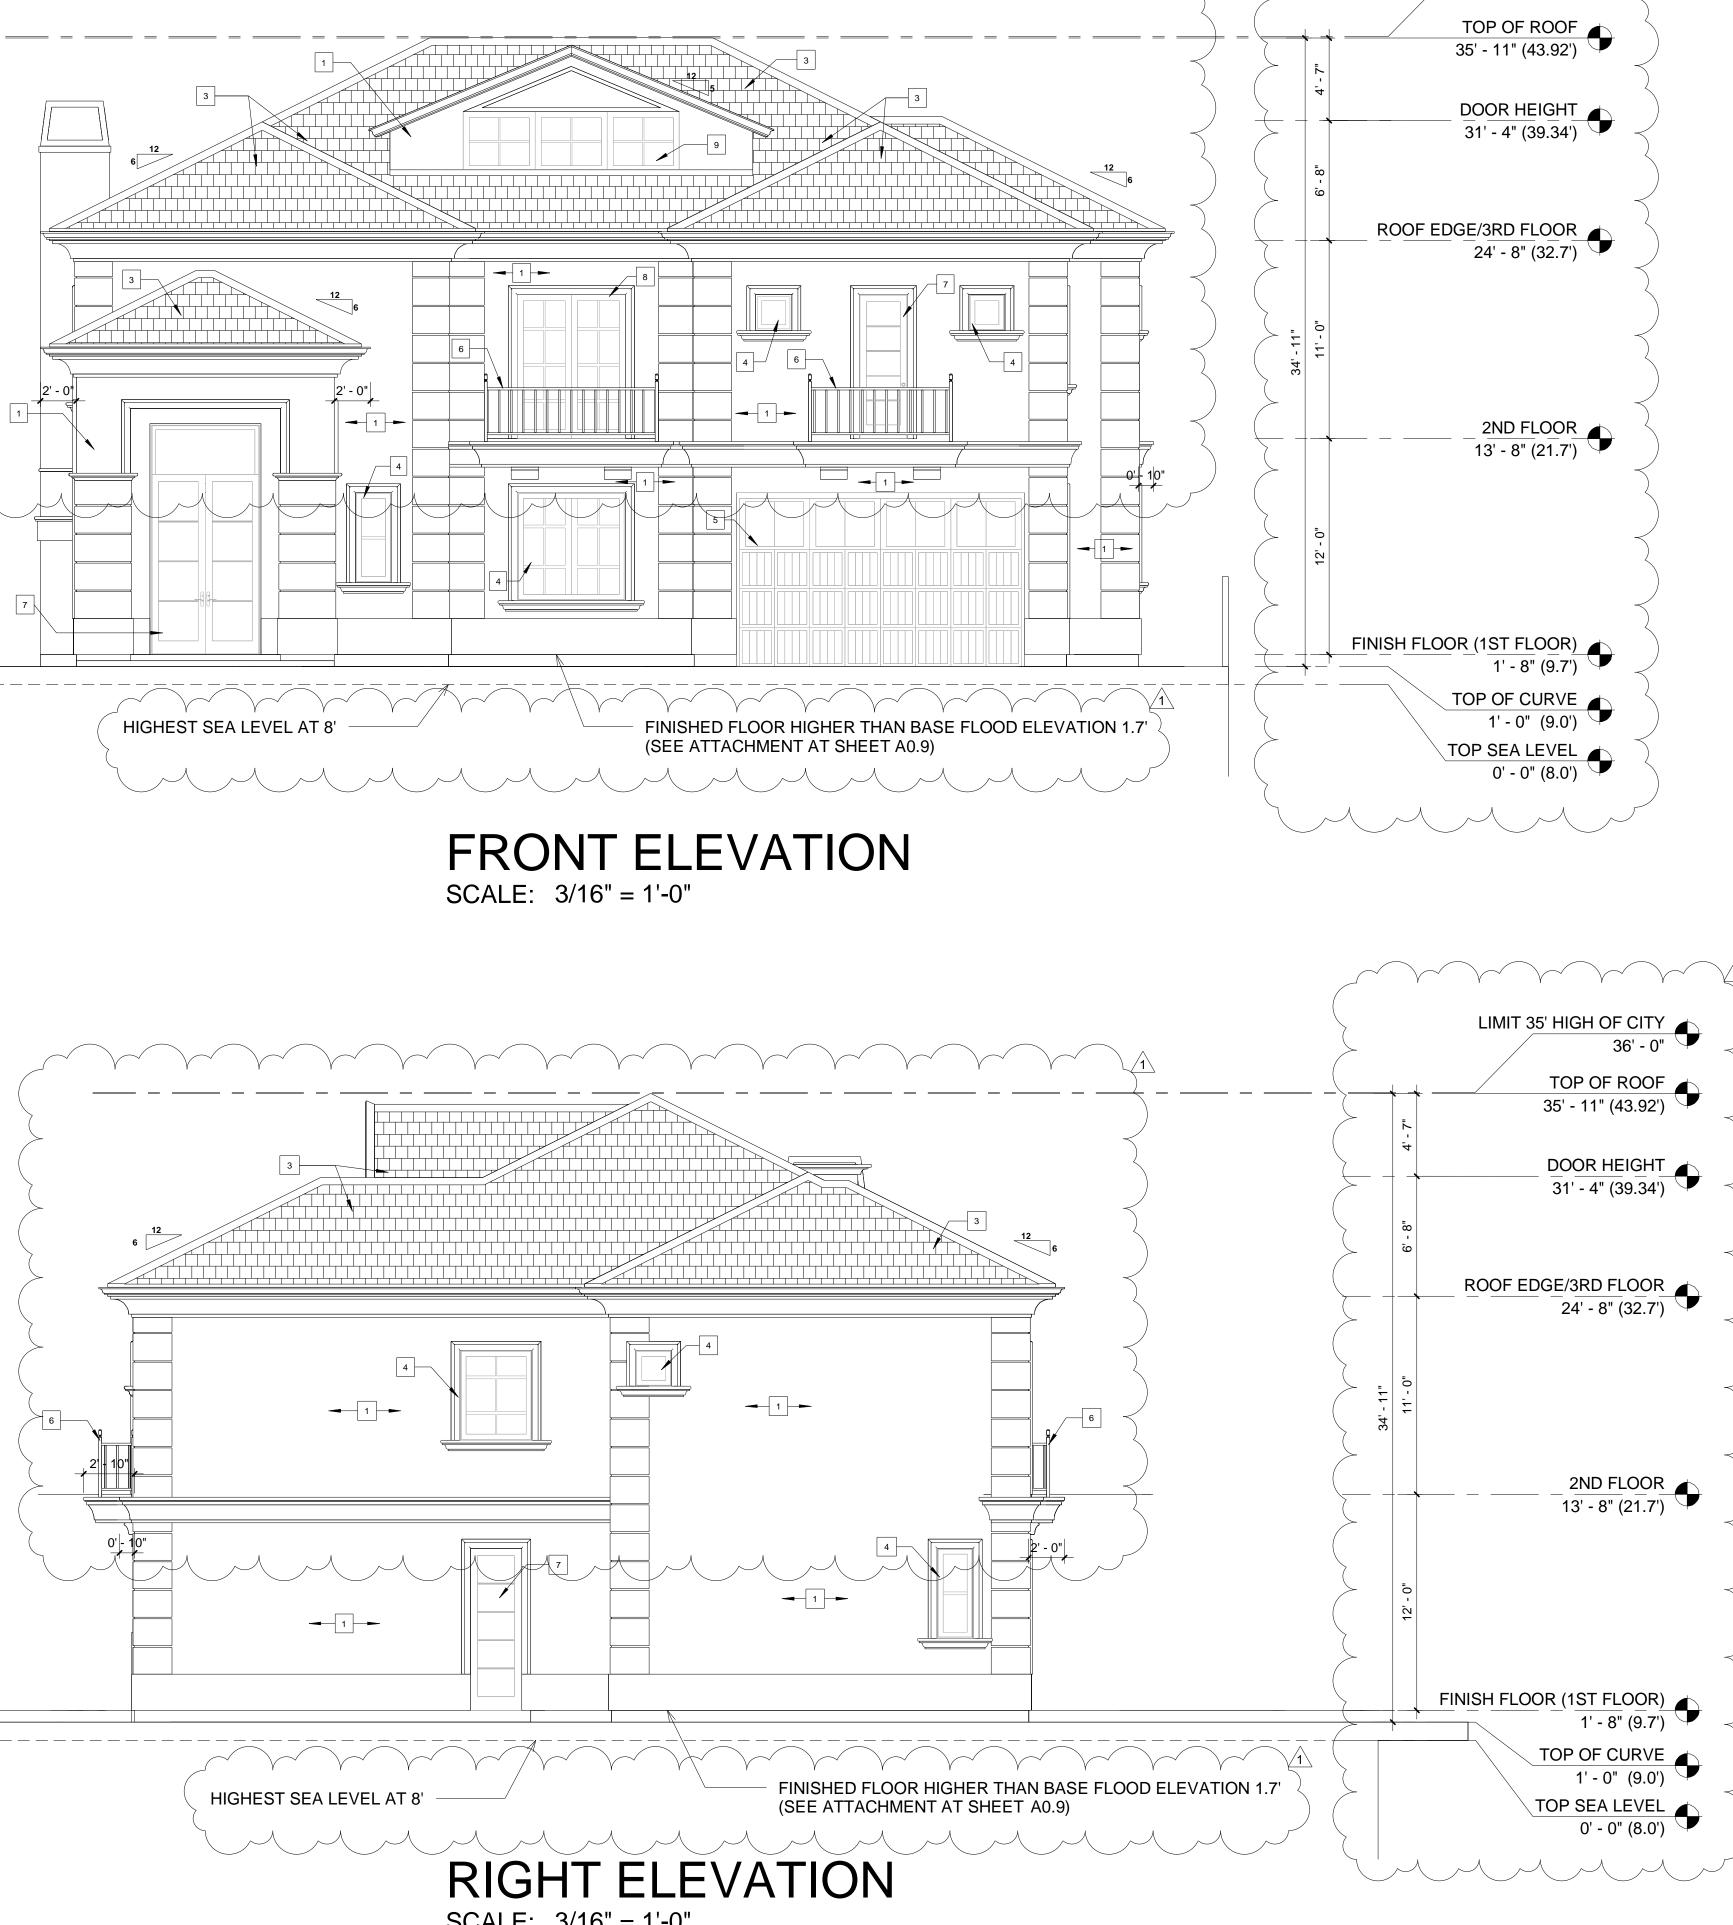
SHEET TITLE: **ROOF PLAN**

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EXTERIOR FINISHES

1. STUCCO, LIGHT SAND FINISH.

- 2. BRICK WALL. 3. STANDING SEAM METAL ROOF.
- 4. VINYL GLAZING WINDOWS.
- 5. CLOPAY CLASSIC STEEL GARAGE DOOR. 6. WOOD RAILING.TEMP.
- 7. EXTERIOR WOOD DOOR.
- 8. SLIDING DOORS.
- 9. SLIDING WINDOW. 10. GLAZING.TEMP. 1/4".

ROOF PLAN NOTES

INDICATES 6:12 SLOPE UNLESS NOTED OTHERWISE ON ROOF PLANS \sim

- TYPICAL ROOFING TO BE : CONCRETE 'S; TILE (ELE. 'A') CLASS 'A' BY
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- NOTE OTHERWISE ON ROOF PLAN. TYPICAL ROOF OVERHANG AT EAVE CONDITION TO BE 24" UNLESS NOTED OTHERWISE ON ROOF PLAN. INSTALLATION OF ROOFING SHALL BE IN ACCORDANCE WITH MANUFACTURERS SPECIFICATIONS.

ELEVATION/ROOF NOTES

- 1. ESTATE EAGLE ROOFING TILE. 2. 2X6 BARGE, SEE DETAIL.
- 3. X EXPOSED RAFTER TAILS WITH SHAPED ENDS, SEE DETAIL ALL RAFTER TAIL TO BE EQUALLY SPACED. FRAMER TO COORDINATE WITH TRUSS ENGINEER.
- 4. EXTERIOR PLASTER OVER PAPER BACKED WITH WIRE MESH.
- 5. EXTERIOR PLASTER SOFFIT OVER EXPANDED METAL LATH.
- 6. I-COAT STUCCO SYSTEM 7. EXTERIOR SIDING, SEE EXTERIOR FINISHES NOTES.
- 8. EXTERIOR GRADE PLYWOOD SOFFIT.
- 9. TONGUE AND GROOVE SOFFIT. 10. SPACED 1 X 3 VERTICAL HARDIE TRIM AT 24" O.C.OVER EXTERIOR
- GRADE PLYWOOD OR M.D.DO. BOARD.
- 11. EXPOSED HARDIE PLYWOOD OR M.D.O. BOARD. 12. EXTERIOR GRADE PLYWOOD GRAIN FINISH.
- 13. HIGH DENSITY FOAM TRIM, SEE ELEV. OR DETAIL FOR ACTUAL SIZE. 14. HIGH DENSITY FOAM WITH, SEE ELEVATION OR DETAIL FOR ACTUAL
- SIZE. 15. EXPOSED HARDIE TRIM, TREE ELEVATION OR DETAIL FOR ACTUAL
- SIZE.
- 16. BIULT-UP 'CURVED' PLYWOOD TRIM OR M.D.O. BOARD. 17. FIXED SHUTTERS, SEE ELEVATION FOR SIZE.
- 18. POTSHELF, SEE DETAIL.
- 19. PROVIDE G.I. PLASHING AT ALL EXPOSED WOOD TRIM. 20. CONTINUOUS G.I. EXTERIOR PLASTER SCREED, SEE DETAIL.
- 21. G.I. FLASHING ROOF TO WALL.
- 22. G.I. FLASHING AND SADDLE / CRICKET. 23. APPROVED TERMINATION CAP WITH SPARK ARRESTER FROM FIRE-
- PPLACE MANUFACTURER.
- 24. LINE OF INTERIOR CEILING OR INTERIOR WALL. 25. THIN-SET MASONRY VENEER.
- 26. LIGHTED ADDRESS SIGN.
- 27. SHAPED FOAM CORBEL, SEE DETAIL.
- 28. SHARPE WOOD CORBEL, SEE DETAIL 29. WOOD POST(S). SEE PLAN FOR SIZE.
- 30 EXPOSED WOOD BEAM
- 31. MANUFACTURED COLUMN.
- 32. PRE-CAST CONCRETE COMPONENT / TRIM. SEE DETAIL. 33. DECORATED.
- 34. NEWEL POST.FALSE TILE VENTS, SEE ELEVATION FOR LOCATION.
- 35. WOOD RAILING, SEE DETAIL.
- 36. DECORATIVE MATERIAL, SEE DETAIL. 37. EXTERIOR PLASTER RECESS, SEE ELEVATION FOR LOCATION. DEPTH AND SIZE OF FINISHED OPENING.
- 38. G.I. SCREENED AND LOUVERED 'GABLE END VENT', SEE ELEVATION FOR VENT SIZE AND LOCATION, SEE REQUIRED ATTIC VENTILATION CHART FOR MORE INFORMATION.
- 39. G.I. SCREENED 'ROOF' AIR VENT. SEE REQUIRED ATTIC VENTILATION CHART FOR MORE INFORMATION. 40. DECORATIVE (FALSE) VENT / LOUVERED BOARD, SEE ELEV. FOR SIZE
- AND LOCATION. 41. G.I. GUTTER AND DOWNSPOUTS, GUTTER LAYOUT AND DOWNSPOUT LOCATIONS TO BE FIELD VERIFIED.
- 42. SYNTHETIC STONE VENEER BY EL DORADO, NER-601/ER-3568. 43. MASONRY VENEER. SEE SLAB INTERFACE PLAN (FOR EXTENT OF TOE FOOTING SEE SLAB INTERFACE PLAN).
- 44. LINE OF +2" WAINSCOT. SEE ELEVATION FOR HEIGHT. 45. LINE OF WAINSCOT FURRING. SEE ELEVATION FOR HEIGHT. SEE SLAB INTERFACE PLAN FOR MORE INFORMATION.
- 46. G.I.REGLET FOR COLOR COAT CHANGE.
- 47. MECHANICAL TUB ACCESS PANEL, CORROSION RESISTANT, VERIFY SIZE AND LOCATION. PAINT TO MATCH STUCCO COLOR. 48. REPEAT DETAIL AT OPPOSITE SIDE OF OPENING.
- 49. DECORATIVE TILE, SEE DETAIL.
- 50. EXPOSE CORBELS WOOD FINISH EXTERIOR.

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Planning Correction

PROJECT DIRECTOR: JOB CAPTAIN: SENIOR ASSOCIATE: ASSOCIATES: PROJECT NUMBER: PROJECT CAD FILE:

SHEET TITLE: **ELEVATIONS**

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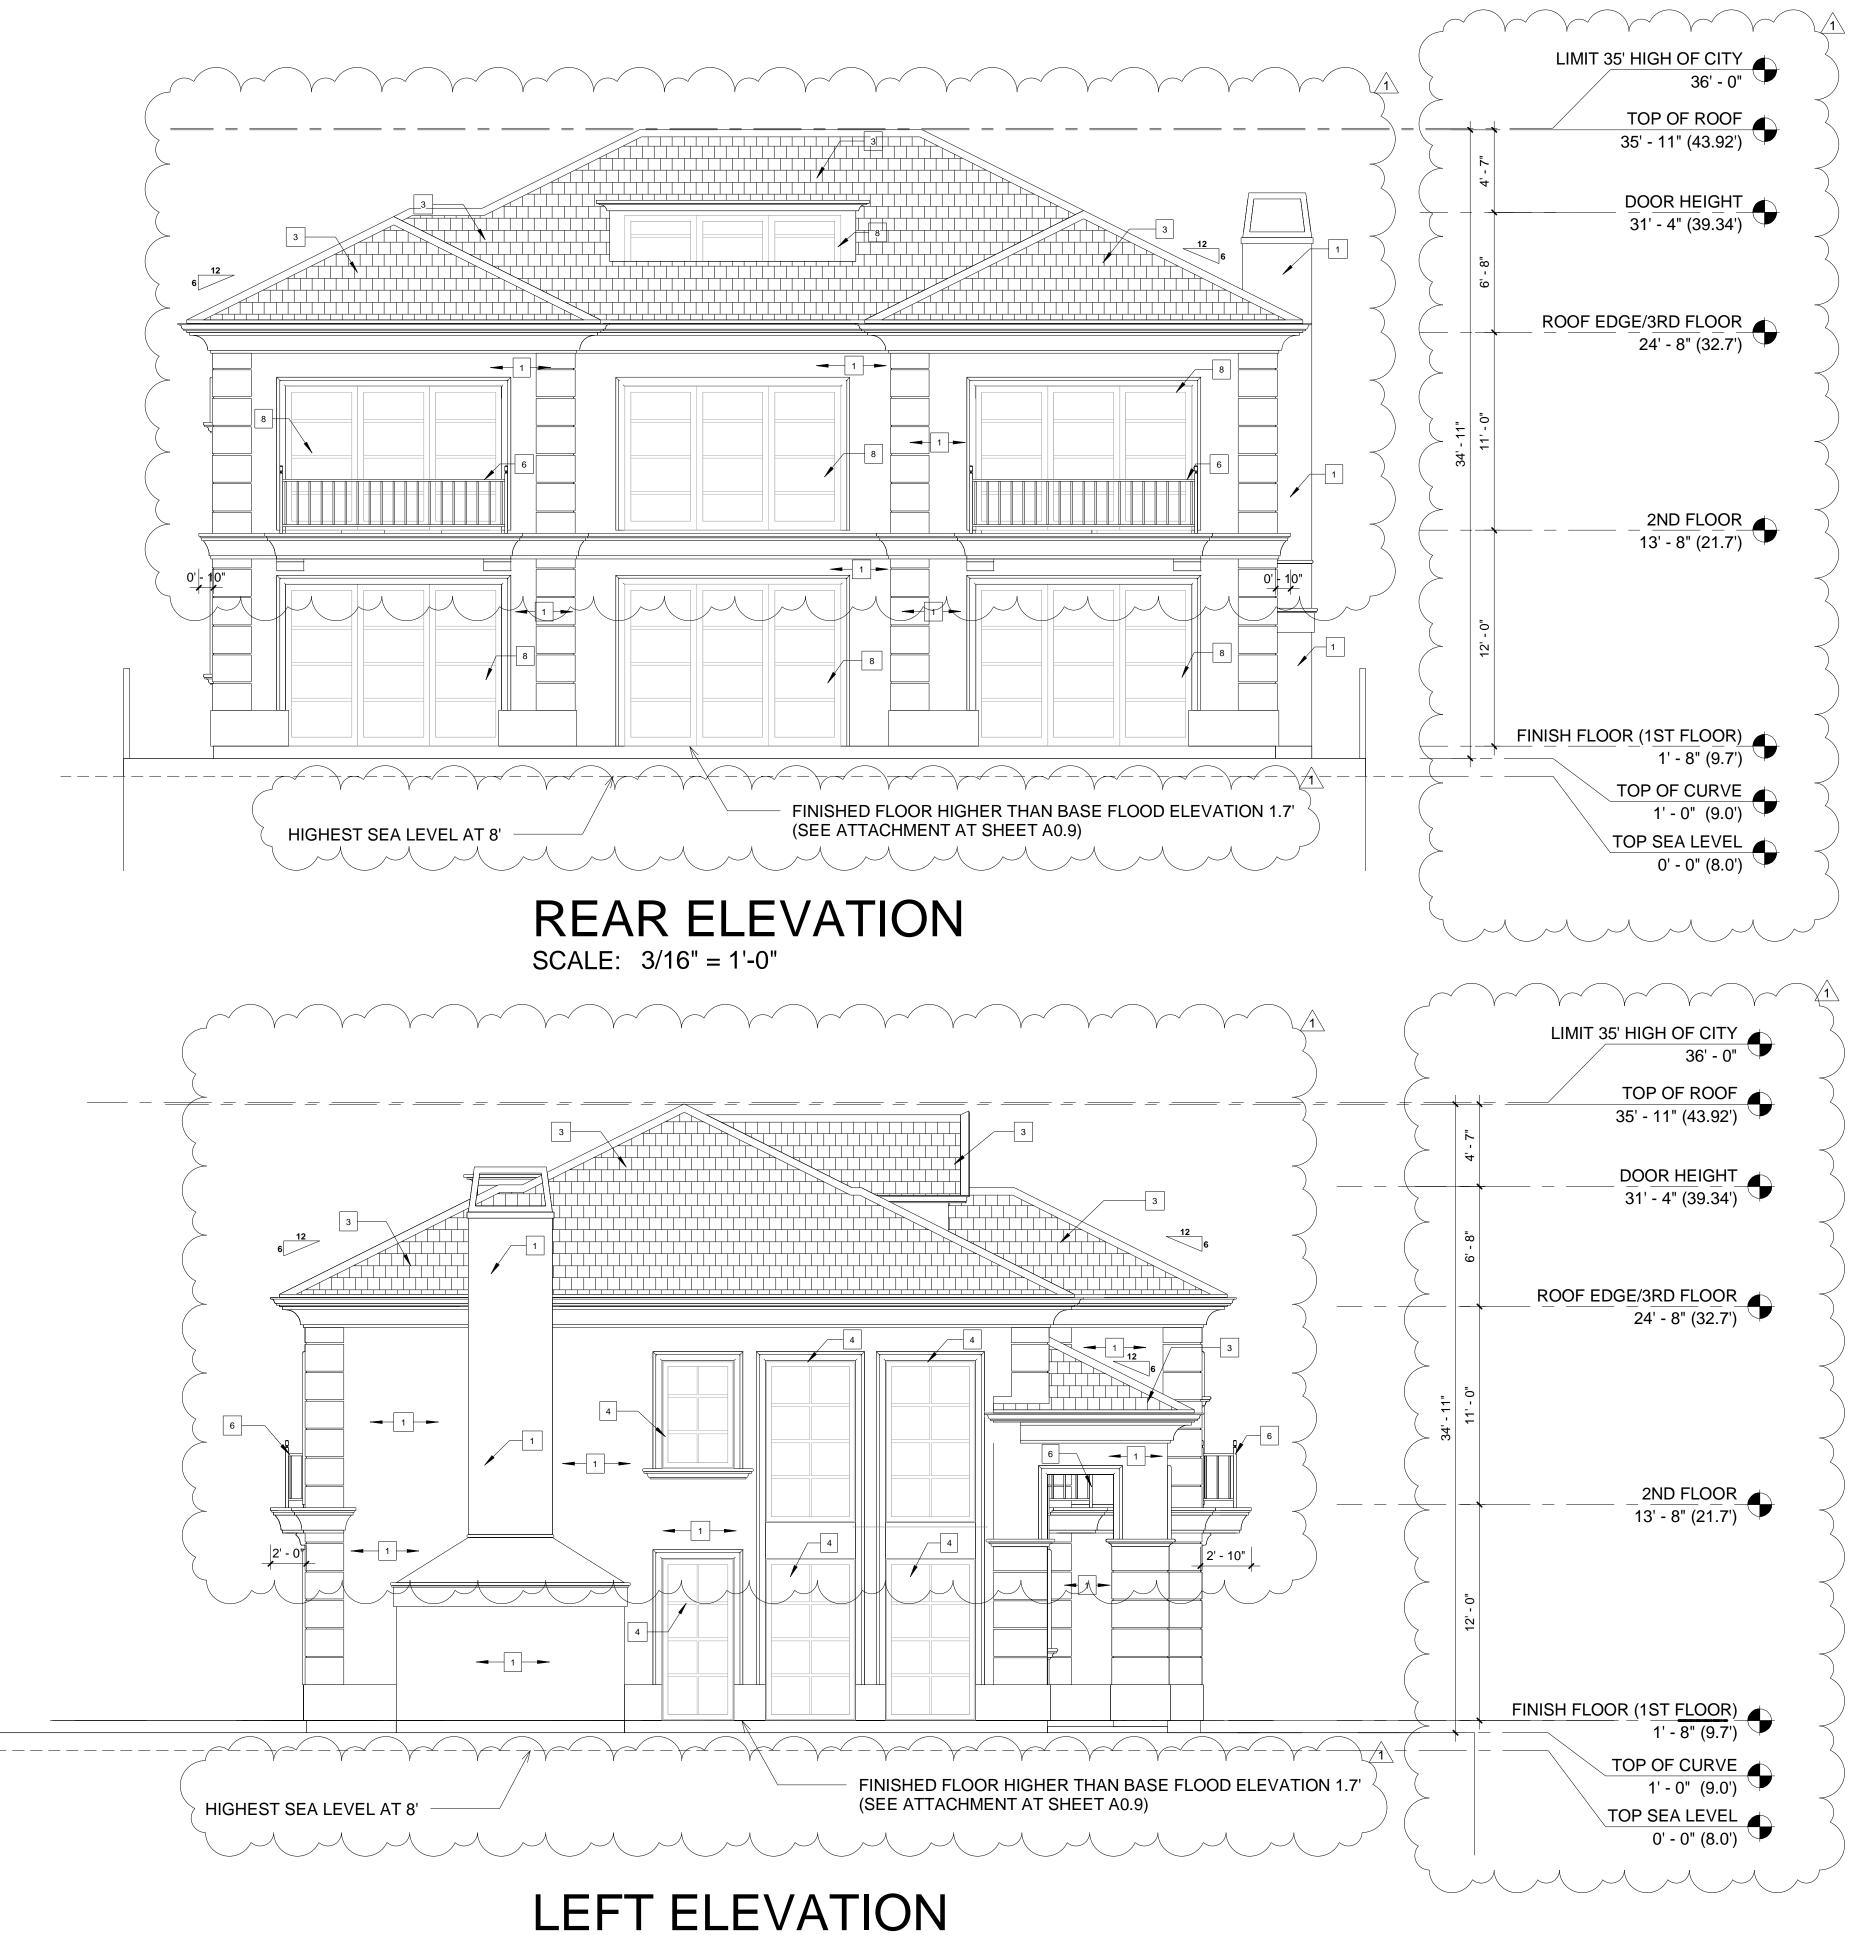


04/14/21

Z PLOT REFERENCE DATE:

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∕1∖ 9/22/2021



SCALE: 3/16" = 1'-0"

EXTERIOR FINISHES

1. STUCCO, LIGHT SAND FINISH.

- 2. BRICK WALL. 3. STANDING SEAM METAL ROOF
- 4. VINYL GLAZING WINDOWS.
- 5. CLOPAY CLASSIC STEEL GARAGE DOOR.
- 6. WOOD RAILING.TEMP. 7. EXTERIOR WOOD DOOR.
- 8. SLIDING DOORS.
- 9. SLIDING WINDOW. 10. GLAZING.TEMP. 1/4".

ROOF PLAN NOTES

INDICATES 6:12 SLOPE UNLESS NOTED OTHERWISE ON ROOF PLANS.

- TYPICAL ROOFING TO BE : CONCRETE 'S; TILE (ELE. 'A') CLASS 'A' BY EAGLE ROOFING ESR-1900 OR APPROVED EQUAL.
- TYPICAL ROOF OVERHANG AT RAKE CONDITION TO BE TIGHT UNLESS NOTE OTHERWISE ON ROOF PLAN.
- TYPICAL ROOF OVERHANG AT EAVE CONDITION TO BE 24" UNLESS NOTED OTHERWISE ON ROOF PLAN. INSTALLATION OF ROOFING SHALL BE IN ACCORDANCE WITH MANUFACTURERS SPECIFICATIONS.

ELEVATION/ROOF NOTES

- 1. ESTATE EAGLE ROOFING TILE.
- 2. 2X6 BARGE, SEE DETAIL. 3. X EXPOSED RAFTER TAILS WITH SHAPED ENDS, SEE DETAIL ALL RAFTER TAIL TO BE EQUALLY SPACED. FRAMER TO COORDINATE WITH TRUSS ENGINEER.
- 4. EXTERIOR PLASTER OVER PAPER BACKED WITH WIRE MESH.
- 5. EXTERIOR PLASTER SOFFIT OVER EXPANDED METAL LATH. 6. I-COAT STUCCO SYSTEM
- 7. EXTERIOR SIDING, SEE EXTERIOR FINISHES NOTES.
- 8. EXTERIOR GRADE PLYWOOD SOFFIT. 9. TONGUE AND GROOVE SOFFIT.
- 10. SPACED 1 X 3 VERTICAL HARDIE TRIM AT 24" O.C.OVER EXTERIOR
- GRADE PLYWOOD OR M.D.DO. BOARD. 11. EXPOSED HARDIE PLYWOOD OR M.D.O. BOARD.
- 12. EXTERIOR GRADE PLYWOOD GRAIN FINISH.
- 13. HIGH DENSITY FOAM TRIM, SEE ELEV. OR DETAIL FOR ACTUAL SIZE. 14. HIGH DENSITY FOAM WITH, SEE ELEVATION OR DETAIL FOR ACTUAL
- SIZE. 15. EXPOSED HARDIE TRIM, TREE ELEVATION OR DETAIL FOR ACTUAL
- SIZE.
- 16. BIULT-UP 'CURVED' PLYWOOD TRIM OR M.D.O. BOARD. 17. FIXED SHUTTERS, SEE ELEVATION FOR SIZE.
- 18. POTSHELF, SEE DETAIL.
- 19. PROVIDE G.I. PLASHING AT ALL EXPOSED WOOD TRIM. 20. CONTINUOUS G.I. EXTERIOR PLASTER SCREED, SEE DETAIL.
- 21. G.I. FLASHING ROOF TO WALL.
- 22. G.I. FLASHING AND SADDLE / CRICKET. 23. APPROVED TERMINATION CAP WITH SPARK ARRESTER FROM FIRE-
- PPLACE MANUFACTURER.
- 24. LINE OF INTERIOR CEILING OR INTERIOR WALL. 25. THIN-SET MASONRY VENEER.
- 26. LIGHTED ADDRESS SIGN.
- 27. SHAPED FOAM CORBEL, SEE DETAIL.
- 28. SHARPE WOOD CORBEL. SEE DETAIL 29. WOOD POST(S). SEE PLAN FOR SIZE.
- 30. EXPOSED WOOD BEAM.
- 31. MANUFACTURED COLUMN.
- 32. PRE-CAST CONCRETE COMPONENT / TRIM. SEE DETAIL. 33. DECORATED.
- 34. NEWEL POST.FALSE TILE VENTS, SEE ELEVATION FOR LOCATION.
- 35. WOOD RAILING, SEE DETAIL.
- 36. DECORATIVE MATERIAL, SEE DETAIL. 37. EXTERIOR PLASTER RECESS, SEE ELEVATION FOR LOCATION. DEPTH AND SIZE OF FINISHED OPENING.
- 38. G.I. SCREENED AND LOUVERED 'GABLE END VENT', SEE ELEVATION FOR VENT SIZE AND LOCATION, SEE REQUIRED ATTIC VENTILATION CHART FOR MORE INFORMATION.
- 39. G.I. SCREENED 'ROOF' AIR VENT. SEE REQUIRED ATTIC VENTILATION CHART FOR MORE INFORMATION. 40. DECORATIVE (FALSE) VENT / LOUVERED BOARD, SEE ELEV. FOR SIZE
- AND LOCATION. 41. G.I. GUTTER AND DOWNSPOUTS, GUTTER LAYOUT AND DOWNSPOUT LOCATIONS TO BE FIELD VERIFIED.
- 42. SYNTHETIC STONE VENEER BY EL DORADO, NER-601/ER-3568. 43. MASONRY VENEER. SEE SLAB INTERFACE PLAN (FOR EXTENT OF TOE FOOTING SEE SLAB INTERFACE PLAN).
- 44. LINE OF +2" WAINSCOT. SEE ELEVATION FOR HEIGHT. 45. LINE OF WAINSCOT FURRING, SEE ELEVATION FOR HEIGHT, SEE SLAB INTERFACE PLAN FOR MORE INFORMATION.
- 46. G.I.REGLET FOR COLOR COAT CHANGE.
- 47. MECHANICAL TUB ACCESS PANEL, CORROSION RESISTANT, VERIFY SIZE AND LOCATION. PAINT TO MATCH STUCCO COLOR.
- 48. REPEAT DETAIL AT OPPOSITE SIDE OF OPENING. 49. DECORATIVE TILE, SEE DETAIL.
- 50. EXPOSE CORBELS WOOD FINISH EXTERIOR.

STAMP:



12862 Joy Street, Suite A Garden Grove CA 92840 Tel: (714) 200 4122 ANHA studio Email: aha@anha-studio.com

SINGLE FAMILY HOUSE

16492 BARNSTABLE CIRCLE HUNTINGTON BEACH, CA 92649

RUBICON INVESTMENT **PROPERTIES LLC** 16492 BARNSTABLE CIRCLE

HUNTINGTON BEACH, CA 92649 Tel: (714) 856 5977

BUILDING DEPARTMENT SUBMITTAL

Planning Correction

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SHEET NUMBER:

gn PLOT REFERENCE DATE:

04/14/21

REVISIONS: ∕1∖ 9/22/2021

J.S. DEPARTMEN ederal Emergency lational Flood Insurar	Manageme						OMB No. 16 Expiration D	60-0008 ate: November 30, 2022
iauonai fiodu insulai	ice Program	ELEVA	TIO	N CER	TIF		Ε	
				the instructior				
ppy all pages of this E	levation Cert	ificate and all attachm	nents for	(1) communit	y offic	ial, (2) insura	ance agent/compar	ıy, and (3) building owne
	SEC	FION A – PROPERTY	(INFOR	MATION			FOR INSUF	RANCE COMPANY USE
A1. Building Owner RUBICON INVEST							Policy Num	ber:
		luding Apt., Unit, Suite	e, and/or	Blda. No.) or	P.O.	Route and		
Box No. 16492 BARN STAE		5 1 .		J ,			Company N	IAIC Number:
City				State			ZIP Code	
HUNTINGTON	BEACH			California	а		92649	
1 5		nd Block Numbers, Ta 3 215, PAGE 11 TO 2		0			a	ORANGE
A4. Building Use (e.g., Residen	tial, Non-Residential,	Addition	, Accessory, e	etc.)	RESIDEN	TIAL	
A5. Latitude/Longi	ude: Lat. 3	3.72258	Long	118.05858		Horizontal	Datum: 🗌 NAD 1	927 🗙 NAD 1983
A6. Attach at least	2 photograph	ns of the building if the	e Certifica	ate is being u	sed to	obtain flood	insurance.	
A7. Building Diagra	m Number 1	В						
A8. For a building v	vith a crawlsp	bace or enclosure(s):						
a) Square foo	age of crawl	space or enclosure(s)				sq ft		
b) Number of p	permanent flo	ood openings in the cr	awlspace	e or enclosure	e(s) wi	— thin 1.0 foot	above adjacent gra	ide
c) Total net an	ea of flood op	penings in A8.b		sq in	I			
d) Engineered	flood openin	igs? 🗌 Yes 🗌 M	No					
-								
A9. For a building v								
a) Square foot	0	0 0		<u>509</u> sq ft				
b) Number of p	permanent flo	ood openings in the at	tached g	arage within	1.0 foc	ot above adja	acent grade 0	
c) Total net are	ea of flood op	enings in A9.b		<u>0</u> sq i	n			
d) Engineered	flood openin	gs? 🗌 Yes 🖂 N	No					
	SE	CTION B – FLOOD	INSURA	NCE RATE	Map	(FIRM) INF	ORMATION	1
	5	community Number		B2. County				B3. State
065034 - HUNTIN	GTON BEAC	Н		COUNTYC	DF OR	ANGE		California
B4. Map/Panel Number	B5. Suffix	B6. FIRM Index Date	Effe	RM Panel ective/ vised Date	B8. F Zone	Flood e(s)	B9. Base Flood E (Zone AO, us	levation(s) e Base Flood Depth)
06059C0231	К		3/21/2	019	AE		8 FEET	
FIS Profile	e 🔀 FIRM ation datum ι	Base Flood Elevation Community Deter Ised for BFE in Item B Coastal Barrier Resc	mined [9: 🗌 N	Other/Sou	rce: _ X NA	VD 1988	Other/Source:	 DPA)? □ Yes ⊠ No
Designation I	Date:		CBRS	ΟΡΑ				
EMA Form 086-0-33	(12/19)	R	eplaces	all previous e	ditions	5.		Form Page 1 of

ELEVATION CERTIFICATE			OMB No. 1660-0008 Expiration Date: November 30, 202
MPORTANT: In these spaces, copy	· · ·		FOR INSURANCE COMPANY US
Building Street Address (including Apt 16492 BARN STABLE CIRCLE			
City HUNTINGTON BEACH	State California	ZIP Code 92649	Company NAIC Number
	SECTION G – COMMUNITY	INFORMATION (OP	TIONAL)
Sections A, B, C (or E), and G of this used in Items G8–G10. In Puerto Ricc G1. The information in Section C	Elevation Certificate. Complete o only, enter meters. C was taken from other docume	e the applicable item(s	odplain management ordinance can complete s) and sign below. Check the measurement n signed and sealed by a licensed surveyor,
engineer, or architect who is data in the Comments area	authorized by law to certify ele	evation information. (I	ndicate the source and date of the elevation
G2. A community official completer or Zone AO.	eted Section E for a building loo	cated in Zone A (with	out a FEMA-issued or community-issued BFE)
G3. The following information (If	tems G4–G10) is provided for o	community floodplain	management purposes.
G4. Permit Number	G5. Date Permit Iss	ued	G6. Date Certificate of Compliance/Occupancy Issued
G7. This permit has been issued for:	New Construction	Substantial Improv	rement
G8. Elevation of as-built lowest floor of the building:	(including basement)		feet meters
G9. BFE or (in Zone AO) depth of flo	oding at the building site:		feet meters Datum
G10. Community's design flood elevat	ion:		feet meters Datum
Local Official's Name		Title	
Community Name		Telephone	
Signature		Date	
Comments (including type of equipme	nt and location, per C2(e), if ap	oplicable)	
			Check here if attachments

		Expiration Date: November 30, 2022
MPORTANT: In these spaces, copy the corresponding information from	Section A.	FOR INSURANCE COMPANY USE
Building Street Address (including Apt., Unit, Suite, and/or Bldg. No.) or P.O. 16492 BARN STABLE CIRCLE	Route and Box No.	Policy Number:
5	ZIP Code 92649	C mpany NAIC Number
SECTION C – BUILDING ELEVATION INFOR	MATION (SURVEY R	EQUIRED)
 C1. Building elevations are based on: □ Construction Drawings* □ *A new Elevation Certificate will be required when construction of the b C2. Elevations – Zones A1–A30, AE, AH, A (with BFE), VE, V1–V30, V (wit Complete Items C2.a–h below according to the building diagram specier Benchmark Utilized: <u>HB-240-75</u> Vertical Datum Indicate elevation datum used for the elevations in items a) through h) □ NGVD 1929 × NAVD 1988 □ Other/Source: Datum used for building elevations must be the same as that used for the same specier based on the same as that used for the same specier based on the same spe	h BFE), AR, AR/A, AR/ fied in Item A7. In Puer n: <u>2005</u> below.	AE, AR/A1–A30, AR/AH, AR/AO. to Rico only, enter meters.
 a) Top of bottom floor (including basement, crawlspace, or enclosure f b) Top of the next higher floor c) Bottom of the lowest horizontal structural member (V Zones only) d) Attached garage (top of slab) e) Lowest elevation of machinery or equipment servicing the building (Describe type of equipment and location in Comments) f) Lowest adjacent (finished) grade next to building (LAG) g) Highest adjacent grade at lowest elevation of deck or stairs, including structural support 		P.7 \times feet meters 19.7 \times feet meters N/A feet meters 9.7 \times feet meters 9.2 \times feet meters 9.2 \times feet meters
SECTION D – SURVEYOR, ENGINEER, OR	ARCHITECT CERTIF	
This certification is to be signed and sealed by a land surveyor, engineer, or I certify that the information on this Certificate represents my best efforts to statement may be punishable by fine or imprisonment under 18 U.S. Code, Were latitude and longitude in Section A provided by a licensed land survey	architect authorized by interpret the data avail Section 1001.	y law to certify elevation information.
Certifier's Name License Number		
HUY NGO L 8765 Title Company Name NHV CIVIL ENGINEERING AND LAND SURVEY INC		THA /
Address 17032 DELIA AVENUE		No. 8765
City State TORRANCE California	ZIP Code 90504	OF CALL
Signature ngotharhung Date	Telephone 310-381-9010	Ext.
Copy all pages of this Elevation Certificate and all attachments for (1) communi	ty official, (2) insurance	agent/company, and (3) building owner
Comments (including type of equipment and location, per C2(e), if applicabl	e)	Form Page 2 of

MPORTANT: In these spaces, copy the	n from Section A.	Expiration Date: November 30, 2022 FOR INSURANCE COMPANY USE	
Building Street Address (including Apt., U 6492 BARN STABLE CIRCLE			Policy Number:
City IUNTINGTON BEACH	State California	ZIP Code 92649	Company NAIC Number
If using the Elevation Certificate to ol instructions for Item A6. Identify all photo "Left Side View." When applicable, pho vents, as indicated in Section A8. If subr	ographs with date taken; "Fro otographs must show the fo	ont View" and "Rear View"; a undation with representative	nd, if required, "Right Side View" and examples of the flood openings or
	1x * 1		
		8	
16492		1	
RONT VIEW			Clear Photo On

		opy the corresponding info
0	reet Address (including RN STABLE CIRCLE	J Apt., Unit, Suite, and/or Bldg
City HUNTING	TON BEACH	State California
	SECTION	N E – BUILDING ELEVATIO FOR ZONE AO AI
	Sections A, B,and C. Fo	E), complete Items E1–E5. If t r Items E1–E4, use natural gr
the hig a) To	e elevation information ghest adjacent grade (H p of bottom floor (includ awlspace, or enclosure)	
b) Toj cra	p of bottom floor (includ awlspace, or enclosure)	ling basement,) is
the ne	ilding Diagrams 6–9 wi xt higher floor (elevatio agrams) of the building	
E3. Attach	ed garage (top of slab)	is
E4. Top of servici	platform of machinery a ing the building is	and/or equipment
E5. Zone A floodp	O only: If no flood dep lain management ordin	th number is available, is the pance?
	SECTION	F – PROPERTY OWNER (OF
The proper community	ty owner or owner's au -issued BFE) or Zone /	thorized representative who c AO must sign here. The stater
Property O	wner or Owner's Autho	rized Representative's Name
Address		
Signature		
Comments		
e en interne		

MPORTANT: In these spaces,	
Building Street Address (includir 16492 BARN STABLE CIRCLE	g Apt., Unit, Suite, and/or Bi
City	State
HUNTINGTON BEACH	Califor
If submitting more photograph with: date taken; "Front View photographs must show the fou	s than will fit on the preced " and "Rear View"; and, ndation with representative
NORTH SIDE VIEW	

SOUTH SIDE VIEW FEMA Form 086-0-33 (12/19)

	OMB No. 1660-0008 Expiration Date: November 30, 2022
nation from Section A.	FOR INSURANCE COMPANY USE
No.) or P.O. Route and Box No.	Policy Number:
ZIP Code 92649	Company NAIC Number
I INFORMATION (SURVEY NOT D ZONE A (WITHOUT BFE)	REQUIRED)
e Certificate is intended to support a de, if available. Check the measure	
appropriate boxes to show whether rade (LAG).	the elevation is above or below
0.1 X feet meter	$rs X$ above or \Box below the HAG.
0.5 🗌 feet 🗌 meter	\sim s \times above or \square below the LAG.
ovided in Section A Items 8 and/or	9 (see pages 1–2 of Instructions),
N/A 🗌 feet 🗌 meter	rs 🔲 above or 🗌 below the HAG.
0.1 [feet] meter	rs \times above or \square below the HAG.
N/A 🗌 feet 🗌 meter	rs 🔲 above or 🗌 below the HAG.
p of the bottom floor elevated in acc Unknown. The local official must c	
OWNER'S REPRESENTATIVE) C	ERTIFICATION
mpletes Sections A, B, and E for Zc ents in Sections A, B, and E are cor	
City St	ate ZIP Code
Date Te	lephone
	Check here if attachments.
Il previous editions.	Form Page 3 of 6

	n Page	OMB No. 1660-0008 Expiration Date: November 30, 2022
nding information		FOR INSURANCE COMPANY USE
and/or Bldg. No.) or	P.O. Route and Box No	o. Policy Number:
State California	ZIP Code 92649	Company NAIC Number
e preceding page, ; and, if required entative examples o	affix the additional phot , "Right Side View" ar of the flood openings or '	ographs below. Identify all photographs Id "Left Side View." When applicable, vents, as indicated in SectionA8.
		Clear Photo Three
		Clear Photo Four

STAMP:



12862 Joy Street, Suite A Garden Grove CA 92840 Tel: (714) 200 4122 ANHA studio Email: aha@anha-studio.com

SINGLE FAMILY HOUSE

16492 BARNSTABLE CIRCLE HUNTINGTON BEACH, CA 92649

RUBICON INVESTMENT **PROPERTIES LLC** 16492 BARNSTABLE CIRCLE HUNTINGTON BEACH, CA 92649

Tel: (714) 856 5977

BUILDING DEPARTMENT SUBMITTAL:

REVISIONS:

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ELEVATION CERTIFICATE

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