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ANCHOR BOLT ASPHALT CONCRETE ACOUS ACOUSTICAL ACT ACOUSTICAL TILE ADJ ADJUSTABLE ADDL ADDITIONAL AFF ABOVE FINISHED FLOOR AGGR AGGREGATE ALT **ALTERNATE** ALUM ALUMINUM ARCH ARCHITECTURAL ASF ABOVE FINISH SURFACE ASPH ASPHALT BD BOARD BITUM BITUMINOUS BLDG BUILDING BLKG BLOCKING BM BEAM BOT BOTTOM BETWEEN BTWN BU BUILT-UP CAB CABINET CBC CALIFORNIA BLDG CODE CB CATCH BASIN CLKG CLG CAULKING CEILING CL CLOSET CHANNEL CJ CONTROL JOINT CLR CLEAR COL COLUMN COMP CMU COMPOSITION CONCRETE MASONRY UNIT CONT CONTINUOUS CONC CONCRETE CERAMIC TILE CTR COUNTER CTSK COUNTERSINK DBL DETAIL DD DOWN DRAIN DRINKING FOUNTAIN DIA DIAMFTFR DIAG DIAGONAL DIM DIMENSION DISPENSER DOWN DN DR DOOR DS DOWNSPOUT DET DETAIL DWG DRAWING DWR DRAWER EXISTING EAST EACH EXHAUST FAN ELECTRICAL HAND DRYER EHD EXPANSION JOINT EXTERIOR INSUL FINISH SYSTEM EIFS ELEVATION HEIGHT ELECTRICAL ELECT ELEVATION NEW ELEV ELEVATOR ELVR EMERGENCY EMER EQUAL EQ EQUIPMENT EQUIP ESCALATOR ESCL ELECTRICAL WATER COOLER EWC EXPANSION EXP EXTERIOR EXT FLOOR DRAIN FOUNDATION FDN FIRE EXTINGUISHER FIRE EXTINGUISHER CABINET FEC FLATHEAD METAL SCREW FHMS FLATHEAD WOOD SCREW FHWS FINISH FIN FLASHING FLASH FLR FLOOR FLUORESCENT FLOUR FACE OF FO FACE OF CMU BLOCK FOB FACE OF CONCRETE FOC FACE OF FINISH FOF FACE OF STUD FOS FACE OF WALL FOW FIREPROOF FPRF FIBER REINFORCED PANEL FRP FOOTING FTG FEET OR FOOT FURRING FURR FREE WAY FWY

GAUGE GALV GALVANIZED GRAB BAR GLASS GLUE LAMINATED MEMBER GLUE LAM BEAM GRADE GYPBD GYPSUM BOARD GYPSUM WALL BOARD GYPSUM SHEATHING BOARD HOSE BIB HANDICAPPED HDWR HARDWOOD HOLLOW CORE HORIZ HORIZONTAL HOUR HIGH STRENGTH BOLT HEIGHT HEAT'G. VENT'G. AIR COND. HIGHWAY INSIDE DIAMETER IDENTITY INTERIOR INSULATION JANITOR JOIST LAMINATE LAVATORY MATERIAL MAXIMUM MACHINE BOLT MECHANICAL MEDIUM METAL MANUFACTURER MKBD MARKER BOARD MINIMUM MIRROR **MISCELLANEOUS** MILLIMETER MASONRY OPENING MOISTURE RESISTANT METAL THRESHOLD MOUNTED MULLION NUMBER NORTH NOT IN CONTRACT NUMBER NOT TO SCALE OVERALL ON CENTER OUTSIDE DIAMETER OPPOSITE HAND OPNG OPENING OVER POURED IN PLACE CONC. PAIR PERFORATED PLATE PLAM PLASTIC LAMINATE PLAS PLASTER PLWD PLYWOOD PRESSED METAL FRAME PRESSURE TREATED PAPER TOWEL DISPENSER PAPER TOWEL DISP/RECP QUARRY TILE QUANTITY RADIUS ROOF DRAIN ROUGH OPENING ROOM REFERENCE REFER REFRIGERATOR REQD REQUIRED RFEC RECESSED FIRE EXT. CAB. RHWS POUND HEAD WD SCREW RIGHT OF WAY

SOUTH SOUND ATTENUATION BATT SAB SC SOLID CORE SCHD SCHEDULE SF SQUARE FEET SHEATHING SHEATH SHT SHEET SIM SIMILAR SM SQUARE METER SQ SQUARE SANITARY NAPKIN DISP. SND SPS STRUC. PLWD. SHEETING SS STAINLESS STEEL STAG STAGGARD STD STANDARD STL STEEL STOR STORAGE SUSP SUSPENDED SYM SYMMETRICAL T&B TOP AND BOTTOM TONGUE AND GROOVE T&G TB TOWEL BAR TDD TELECOM DISP. DEVICE TEMP TEMPORARY TK THICK TS TUBE STEEL TSCD TOILET SEAT COVER DISP. TTD TOILET TISSUE DISP. TYP TYPICAL TEMPERED UNLESS NOTED OTHERWISE UNO UR URINAL VR VAPOR BARRIER VAR VARIES VCT VINYL COMPOSITION TILE VERT VERTICAL VTR VENT THRU ROOF WEST W WITH W/ WITHOUT W/0 WATER CLOSET WC WOOD WD VENT THRU ROOF WDW WATERPROOF WP WSCT WAINSCOT

REVISIONS

DESCRIPTION

PROJECT DATA PROJECT DIRECTORY LEGEND **DEMOLITION SYMBOLS LEGEND:** OWNER: LANDSCAPE ARCHITECT: ZONE: OS-PR ICG, INC. EXISTING PARK SITE AREA: APPROX. 4 AC (E) Concrete to be removed (115 s.f. 4195 CHINO HILLS PARKWAY CHINO HILLS, CA 91709 PH: 909-203-7995 OCCUPANCY CLASS: A-3 (E) Asphalt to be removed (3,196 s.f.) CONTACT: JEFF SCOTI EXISTING CLUBHOUSE BUILDING AREA: APPROX. 2,200 S.F. EMAIL: jscott@icg-inc.org EXISTING MEN'S RESTROOM AREA: 90 S.F. (E) Stone paving to be removed (353 s.f.) EXISTING WOMEN'S RESTROOM AREA: 75 S.F. MECHANICAL/PLUMBING ENG (E) Turf and shrubs to be removed (827 s.f.) DESIGN WEST ENGINEERING 275 W. HOSPITALITY LANE SUITE 100 SAN BERNARDINO, CA 92408 (E) Curb to be removed at 12th Street (25 I.f.) CONTACT: JOSH LUKACS Add. Alt.#1 EMAIL: jlukacs@designwesteng.com (E) Concrete to be removed (1,749 s.f.) (E) Asphalt to be removed (421 s.f.) ELECTRICAL ENGINEER: JCA ENGINEERING 8048 PALM AVENUE (E) Stone paving to be removed (360 s.f.) HIGHLAND, CA 92346 CONTACT: JIM CORNS (E) Turf and shrubs to be removed (616 s.f.) EMAIL: james.corns@jcaeng.com Limit of Work NOTE: Contractor is responsible for all quantities. NEW CONSTRUCTION SYMBOLS LEGEND: 4" Thick natural color concrete w/ med. broom (2,438 s.f.) 4" Thick natural color concrete w/ retardant finish (1,278 s.f.) 6" Thick natural color concrete w/med. broom (715 s.f.) 18" Wide concrete banding w/ Lt. broom finish (340 l.f.) 3" Concrete curb natural color concrete w/ trowel finish (38 l.f. 8" Concrete curb and gutter natural color concrete (25 l.f.) CODE INFORMATION Add Alt #1 4" Thick natural color concrete w/ retardant finish (2,700 s.f.) 18" Wide concrete banding w/ Lt. broom finish (263 l.f.) Limit of Work NOTE: Contractor is responsible for all quantities. 1.) THE 2019 CALIFORNIA BUILDING CODE (CBC) 2.) THE 2019 CALIFORNIA MECHANICAL CODE (CMC) 3.) THE 2019 CALIFORNIA PLUMBING CODE (CPC) 4.) THE 2019 CALIFORNIA ELECTRICAL CODE (CEC) 5.) THE 2019 CALIFORNIA FIRE CODE (CFC) 6.) THE 2019 CALIFORNIA GREEN BUILDING STANDARDS CODE (CALGreen) 7.) APPLICABLE ORDINANCES OF THE CITY OF HUNTINGTON BEACH KEYNOTE SECTION REFERENCE $\langle X \rangle$ WINDOW NUMBER \mathbf{X} ELEVATION CALLOUT DOOR NUMBER X DEMOLITION NOTE APPROVED: INTERIOR ELEVATION X /x\ REVISION NUMBER CALLOUT THOMAS HERBEL, P.E. DATE CITY ENGINEER GRID LINE NUMBER (\mathbf{X}) (OR LETTER) ---- DETAIL CUT APPROVED: ROOM NUM ROOM NAME SEAN CRUMBY, P.E. DATE ROOM NUMBER DIRECTOR OF PUBLIC WORKS DETAIL CUT PREPARED UNDER THE SUPERVISION OF: REFERENCES TERRY EVANS APP'V'D **R.A. NO.:** C33095 **EXP. DATE:** II-30-202 APPROVED BY: DRAWN BY: CITY OF HUNTINGTON BEACH DATE CHRIS TANIO, PRINCIPAL C.E. DESIGNED BY: **R.C.E. No:** <u>C82756</u> **Exp. Date:** <u>09/30/22</u>

CHECKED BY:

CITY OF HUNTINGTON BEACH 2000 MAIN STREET HUNTINGTON BEACH, CA 92648 CONTACT: FARHAD BOLOURCH EMAIL:farhad.bolourchi@surfcity-hb.org CIVIL ENGINEER: PBLA ENGINEERING 1481 FORD STREET SUITE 201 REDLANDS, CA 92373 CONTACT: MARIO MARTINEZ EMAIL: mmartinez@pbla.biz ARCHITECT OF RECORD ICG, INC. 4195 CHINO HILLS PARKWAY CHINO HILLS, CA 91709 PH: 909-203-7995 CONTACT: MATT EVANS EMAIL: mevans@icg-inc.org APPLICABLE CODES: SYMBOLS

TWO WORKING DAYS BEFORE YOU DIG

Call: TOLL FREE


-800-422-4133

Underground Service Alert

LAKE PARK IMPROVEMENT CAPITOL IMPROVEMENT PROJECT COMMUNITY SERVICES PARK DEVELOPMENT CITY OF HUNTINGTON BEACH

1035 IITH STREET

HUNTINGTON BEACH, CA 92648

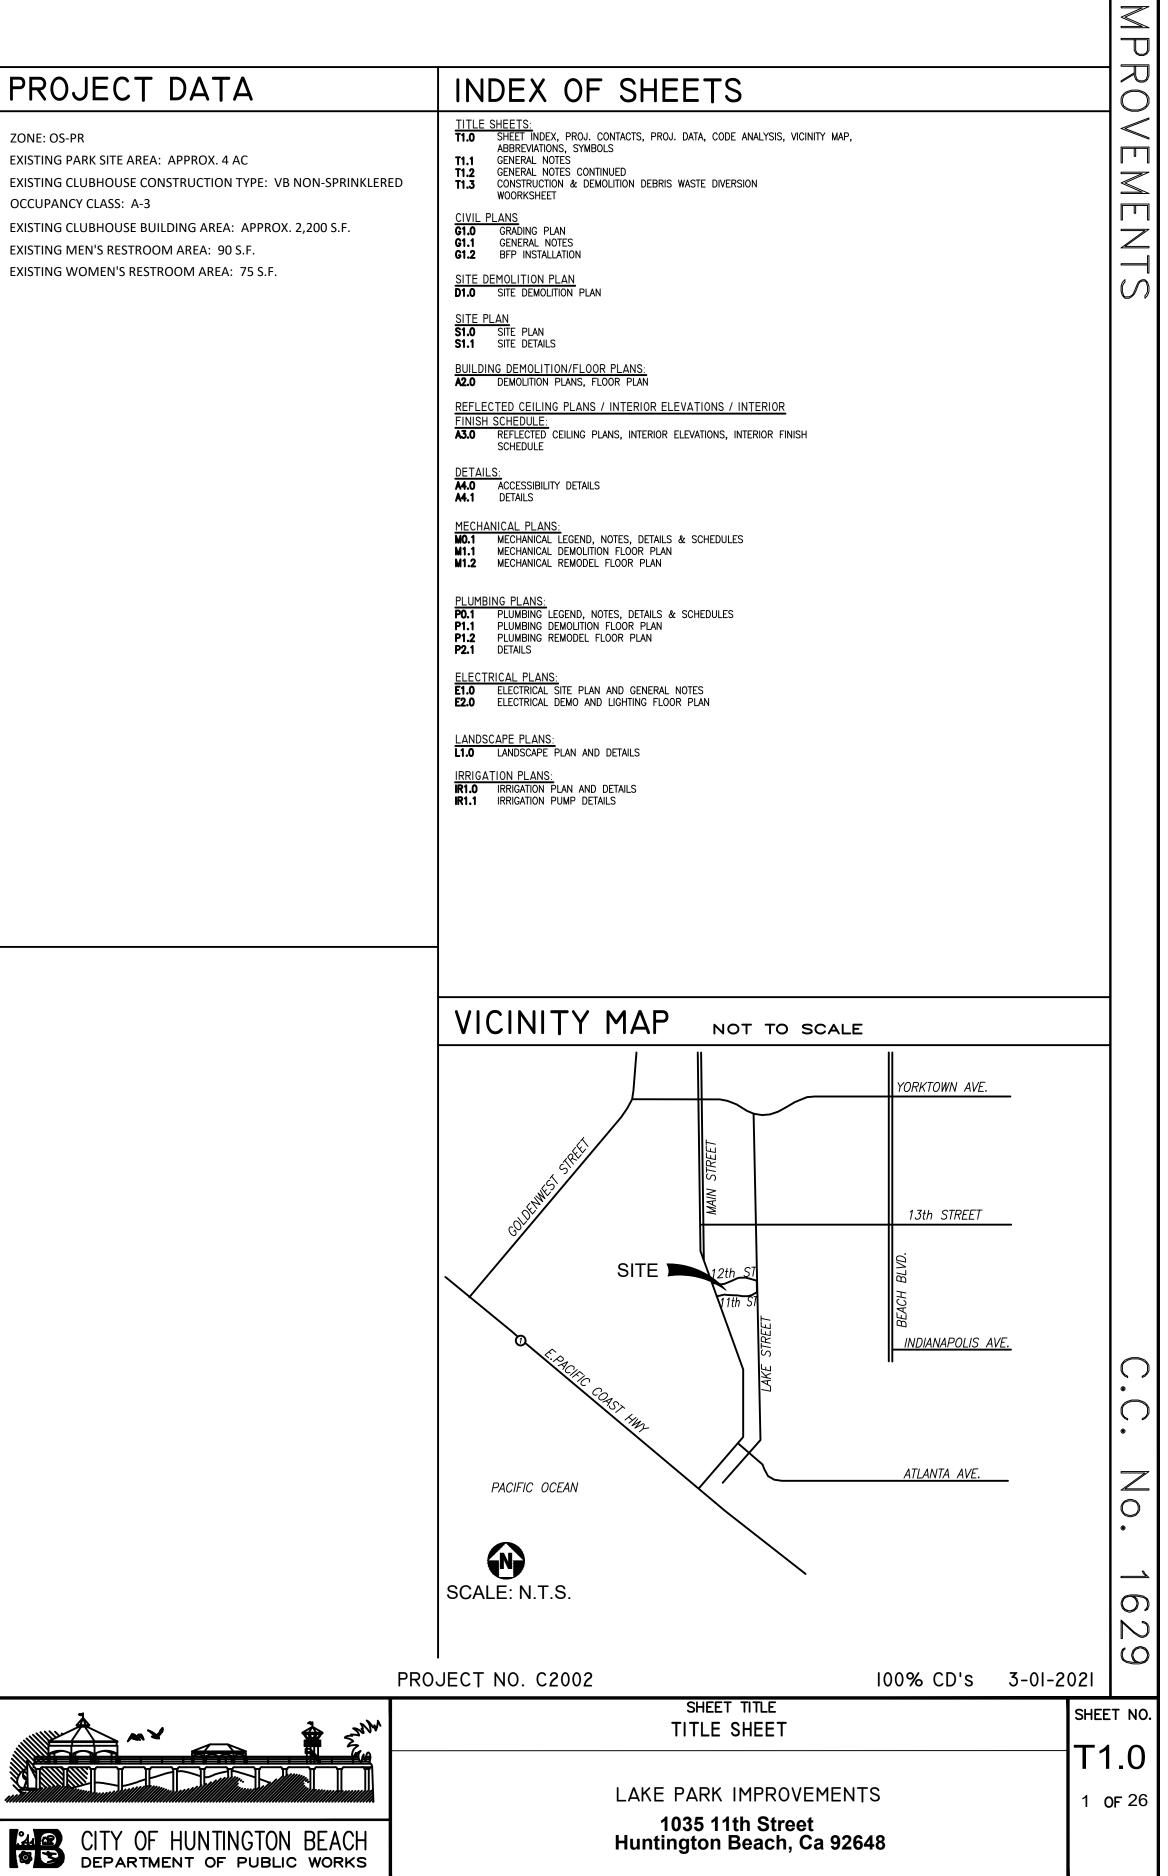

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A.GENERAL NOTES

- 1. PREBID:
- A. ALL WORK CALLED FOR ON THE PLANS SHALL BE IN COMPLIANCE WITH CURRENT STATE, COUNTY, AND/OR CITY STANDARDS & SPECIFICATIONS, ADOPTED BY THE CITY, UNLESS OTHERWISE NOTED ON THE PLANS OR IN THE SPECIAL PROVISIONS FOR THE SUBJECT PROJECT
- B. A TEMPORARY STREET CLOSURE PERMIT IS REQUIRED IN ALL CASES WHERE WORK WILL INTERFERE WITH EITHER VEHICULAR OR PEDESTRIAN TRAFFIC.
- C. INSPECTION BY THE CITY OF THE WORK CALLED FOR ON THE PLANS SHALL NOT. IN ANY WAY, RELIEVE THE CONTRACTOR AND/ OR THE DEVELOPER OF THEIR OBLIGATION TO PERFORM THE WORK IN COMPLIANCE WITH THE PLANS AND SPECIFICATIONS.
- D. ANY ALTERATIONS OR VARIANCES FROM THE PLANS, EXCEPT MINOR ADJUSTMENTS IN THE FIELD TO MEET EXISTING CONDITIONS. SHALL BE REQUESTED IN WRITING AND MAY NOT BE INSTITUTED UNTIL APPROVED BY THE CITY OR ITS REPRESENTATIVES ACTING SPECIFICALLY ON ITS INSTRUCTIONS.
- E. ALL ELEVATIONS SHOWN ON THE PLAN ARE ESTABLISHED BY LOCAL BENCHMARK. SURVEY MONUMENTS SHALL BE PROTECTED IN PLACE.
- F. QUANTITIES, AS SHOWN ON THE PLANS, ARE ESTIMATED, AND THE CONTRACTOR IS ADVISED THAT ALL FINAL QUANTITIES OF MATERIAL AND WORK IN PLACE MAY BE SOMEWHAT GREATER OR LESS THAN INDICATED ON THE PLAN.
- G. THE CONTRACTOR SHALL OPERATE IN A MANNER COMPLIANT WITH ALL APPLICABLE SECTIONS OF THE MUNICIPAL CODE AND COMPLIANT WITH ALL APPLICABLE CITY RESOLUTIONS.
- H. THE LOCATION OF UNDERGROUND UTILITY OR IRRIGATION LINES, AS SHOWN ON THE PLANS. IS APPROXIMATE. AND SINCE THE ACTUAL LOCATION MAY BE SOMEWHAT DIFFERENT FORM THAT SHOWN, THE CONTRACTOR IS REQUIRED TO CONTACT THE INTERESTED UTILITY OR WATER COMPANY BEFORE EXCAVATING IN THE VICINITY OF ANY SUCH LINES. www.digalert.com OR CALL 1-800-422-4133 (DIG ALERT).
- THE CONTRACTOR IN ACCORDANCE WITH THE APPROPRIATE CITY STANDARDS, WILL INSTALL ALL TRAFFIC REGULATORY SIGNS INDICATED ON THE PLANS.(IF APPLICABLE).
- J. AN APPROVED WEED KILLER SHALL BE APPLIED TO THE PREPARED BASE PRIOR TO PAVING IN ALL AREAS WHERE THERE IS ANY EVIDENCE OF HUMUS OR ORGANIC MATERIAL PRESENT IN THE BASE (EITHER NATIVE OR IMPORTED) MATERIAL. ALL WEED KILLERS SHALL BE APPLIED IN STRICT ACCORDANCE WITH THE MANUFACTURER'S SPECIFICATIONS AND INSTRUCTIONS.
- K. THE CONTRACTOR SHALL MAKE PROVISIONS FOR CONTRIBUTORY DRAINAGE AT ALL TIMES.
- REMOVE DIRT, DEBRIS, OR OTHER CONSTRUCTION MATERIAL DEPOSITED ON ANY PUBLIC STREET NO LATER THAN THE END OF EACH WORKING DAY.
- M. CONSTRUCTION OPERATIONS INCLUDING BUILDING RELATED ACTIVITIES AND DELIVERIES SHALL BE RESTRICTED TO MONDAY THROUGH FRIDAY DURING HOURS REQUIRED BY THE CITY, EXCLUDING HOLIDAYS, AND HOURS REQUIRED BY THE CITY ON WEEKENDS AND HOLIDAYS. IN ACCORDANCE WITH CITY MUNICIPAL CODE, UNLESS OTHERWISE EXTENDED OR SHORTENED BY THE BUILDING OFFICIAL. CONTRACTOR TO VERIFY APPROVED WORKING HOURS WITH CITY OFFICIAL.
- 2. CONSTRUCTION
- A. ALL WORK SHALL BE CARRIED OUT IN STRICT CONFORMANCE WITH THE CURRENT EDITION OF;
- 1. CALIFORNIA BUILDING CODE 2019, 2019 CPC AND 2019 CEC. REFERENCE SHEET T1.0.
- 2. CURRENT LOCAL CODES, ORDINANCES, POLICIES AND STANDARDS AS ADOPTED BY THE CITY AND REGULATING AGENCIES.
- B. THE GENERAL CONTRACTOR SHALL VERIFY THE LOCATION OF KNOWN UTILITY LINES AT THE JOB SITE AND TAKE EXTREME PRECAUTIONS TO AVOID DAMAGE. THE CONTRACTOR WILL BE HELD RESPONSIBLE FOR REPAIR OF ANY SUCH LINES THAT ARE DAMAGED.
- C. ANY DISCREPANCIES, ERRORS OR OMISSIONS IDENTIFIED IN THE CONSTRUCTION DOCUMENTS SHALL BE REFERRED TO THE ARCHITECT IMMEDIATELY BY THE GENERAL CONTRACTOR FOR CLARIFICATION BEFORE RELATED CONSTRUCTION; FABRICATION OR INSTALLATION TAKES PLACE.
- 3. ACCESSIBILITY
- EXISTING PARKING, PAVING AND PATHS OF TRAVEL SHALL BE MAINTAINED FOR HANDICAP ACCESSIBILITY IN ACCORDANCE WITH CBC 11B - 201&20 11B 206.
- B. SIGNAGE IDENTIFYING HANDICAP ACCESSIBILITY SHALL BE IN ACCORDANCE WITH CBC 11B-703.

B. GENERAL CONTRACTOR

- 1. QUALITY ASSURANCE/ CONTROL OF INSTALLATION: THE CONTRACTOR SHALL:
- A. MONITOR QUALITY CONTROL OVER SUPPLIERS, MANUFACTURERS, PRODUCTS, SERVICES, SUBCONTRACTORS, SITE CONDITIONS, AND WORKMANSHIP TO PRODUCE WORK OF HIGH QUALITY.
- B. COMPLY FULLY WITH MANUFACTURERS' INSTRUCTIONS, INCLUDING STORAGE OF MATERIALS AND EACH STEP IN INSTALLATION SEQUENCE. MATERIALS SHALL BE STORED IN MANUFACTURERS WRAPPING/ PACKAGING/ SEALED CONTAINER UNTIL USED. (SEE ALSO MATERIALS AND EQUIPMENT)

- C. SHOULD MANUFACTURERS INSTRUCTIONS CONFLICT WITH CONTRACT DOCUMENTS, REQUEST CLARIFICATION FROM THE ARCHITECT/ OWNER BEFORE PROCEEDING WITH INSTALLATION / APPLICATION.
- D. COMPLY WITH SPECIFIED STANDARDS AS A MINIMUM QUALITY FOR THE WORK EXCEPT WHEN MORE STRINGENT TOLERANCES, CODED, OR SPECIFIED REQUIREMENTS INDICATE HIGHER STANDARDS OR MORE PRECISE WORKMANSHIP.
- E. WORK SHALL BE PERFORMED ONLY BY PERSONS QUALIFIED OR AUTHORIZED BY PRODUCT MANUFACTURES TO PRODUCE WORKMANSHIP OF HIGH QUALITY.
- F. SECURE PRODUCTS IN PLACE WITH POSITIVE ANCHORAGE DEVICES RECOMMENDED BY MANUFACTURER, DESIGNED AND SIZED TO WITHSTAND STRESSES, VIBRATION, PHYSICAL DISTORTION OR DISFIGUREMENT.
- G. BE FAMILIAR WITH ALL CITY ORDINANCES AND AGENCY REQUIREMENTS.
- 1. REFERENCES: THE CONTRACTOR SHALL:
- A. CONFORM TO REFERENCE STANDARD BY DATE OF ISSUE CURRENT ON DATE OF CONTRACT DOCUMENTS.
- B. OBTAIN COPIES OF STANDARDS WHEN REQUIRED BY CONTRACT DOCUMENTS.
- C. SHOULD SPECIFIED REFERENCE STANDARDS CONFLICT WITH CONTRACT DOCUMENTS, REQUEST CLARIFICATION FROM ARCHITECT/OWNER BEFORE PROCEEDING.
- D. THE CONTRACTUAL RELATIONSHIP OF THE PARTIES TO THE CONTRACT SHALL NOT BE ALTERED FROM THE CONTRACT DOCUMENTS BY MENTION OR INFERENCE OTHERWISE IN ANY DOCUMENT REFERENCE.

C. CONSTRUCTION FACILITIES AND TEMPORARY CONTROLS

1. TEMPORARY ELECTRICITY

- A. PROVIDE POWER OUTLETS FOR CONSTRUCTION OPERATIONS, WITH BRANCH WIRING AND DISTRIBUTION BOXES LOCATED AS NEEDED. PROVIDE FLEXIBLE POWER CORDS AS REQUIRED.
- B. PROVIDE MAIN SERVICES DISCONNECT AND OVER CURRENT PROTECTION AT CONVENIENT LOCATION FEEDER SWITCH AT SOURCE DISTRIBUTION EQUIPMENT METER.
- C. PROVIDE ADEQUATE DISTRIBUTION EQUIPMENT, WIRING AN OUTLETS TO PROVIDE SINGLE-PHASE BRANCH CIRCUITS FOR POWER AND LIGHTING.
- 2. TEMPORARY LIGHTING
- A. PROVIDE AND MAINTAIN FLORESCENT & LED LIGHTING FOR CONSTRUCTION OPERATIONS.
- B. PROVIDE BRANCH WIRING FROM POWER SOURCE TO DISTRIBUTION BOXES WITH LIGHTING CONDUCTORS, PIGTAILS AND LAMPS AS REQUIRED. C. MAINTAIN LIGHTING AND PROVIDE ROUTINE REPAIRS.
- 3. TEMPORARY SANITARY FACILITIES
- A. GENERAL CONTRACTOR TO PROVIDE PORTABLE TOILET(S) & HAND WASHING FOR DURATION OF CONSTRUCTION OPERATIONS
- 4. PROTECTION OF INSTALLED WORK
- A. PROTECT INSTALLED WORK AND PROVIDE SPECIAL PROTECTION WHERE REQUIRED WHETHER SPECIFIED OR NOT.
- B. PROVIDE TEMPORARY AND REMOVABLE PROTECTION FOR INSTALLED PRODUCTS. LIMIT AND CONTROL ACTIVITY IN IMMEDIATE WORK AREA TO MINIMIZE DAMAGE.
- C. PROTECT FINISHED FLOOR SURFACES FROM TRAFFIC, DIRT, WEAR, DAMAGE OR
- D. PROHIBIT TRAFFIC FROM LANDSCAPED AREAS.
- 5. ACCESS ROADS
- A. CONSTRUCTION ACCESS SHALL BE FROM LOCATION TO BE DETERMINED BY OWNER.
- B. MAINTAIN ACCESS AT PUBLIC THOROUGHFARES TO SERVE CONSTRUCTION AREA.
- C. PROVIDE TRAFFIC CONTROL AS WORK PROGRESS REQUIRES, PROVIDING DETOURS NECESSARY FOR UNIMPEDED TRAFFIC AND PEDESTRIAN FLOW, DURING OFF-SITE WORK.
- D. PROVIDE AND MAINTAIN ASPHALT ACCESS TO FIRE HYDRANTS. FREE OF ANY
- OBSTRUCTIONS.
- F. PUBLIC AND CONSTRUCTION PARKING SHALL BE LIMITED TO DESIGNATED PARKING
- AREAS ONLY. 6. PROGRESS CLEANING
- A. MAINTAIN AREAS FREE OF WASTE MATERIALS, DEBRIS, AND RUBBISH. MAINTAIN SITE IN A CLEAN AND ORDERLY CONDITION, PLACING ALL WASTE MATERIALS IN BINS AT THE END OF EACH DAY.
- B. REMOVE WASTE MATERIALS, DEBRIS, AND RUBBISH FROM SITE ON A FREQUENT, REGULAR, BASIS AND DISPOSE OFFSITE.

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TWO WORKING DAYS BEFORE YOU DIG					DRAWN BY: DESIGNED BY: CHECKED BY:	CHRIS TANIO, PRINCIPAL C.E. DATE R.C.E. No: C82756 Exp. Date: 09/30/22	CITY OF HUNTING

- MOVEMENT OF HEAVY OBJECTS BY PROTECTING WITH DURABLE SHEET MATERIALS.
- E. PROVIDE MEANS OF REMOVING MUD FROM VEHICLE WHEEL BEFORE ENTERING STREETS.

- 7. DUST CONTROL
- A. THROUGHOUT THE ENTIRE CONSTRUCTION PERIOD THE CONTRACTOR SHALL EFFECTIVELY DUST PALLIATE THE WORKING AREA, ACCESS AND OTHER AREAS AFFECTED BY THE WORK, IN ACCORDANCE WITH COUNTY REQUIREMENTS.
- 8. LAYOUT OF WORK
- A. THE CONTRACTOR SHALL BE RESPONSIBLE FOR THE LAYOUT OF ALL THE WORK INVOLVED IN THE PROJECT. ANY CONFLICTS ARISING IN THE CONTRACT DOCUMENTS AND BETWEEN CONTRACT DOCUMENTS AND SITE CONDITIONS SHALL BE IMMEDIATELY REPORTED TO THE OWNER AND CONFIRMED IN WRITING WITHIN 24 HOURS.
- 9. COORDINATION
- A. THE CONTRACTOR SHALL BE RESPONSIBLE FOR THE TIMELY COORDINATION OF DELIVERY OF ALL MATERIALS AND WORK OF ALL TRADES TO ENSURE CONTINUITY OF CONSTRUCTION. FAILURE TO DO SO WILL NOT BE ACCEPTED AS A LEGITIMATE REASON FOR EXTENDING THE CONTRACT PERIOD.
- 10. SUBMITTALS AND SHOP DRAWINGS
- A. THE CONTRACTOR SHALL REVIEW EACH SUBMITTAL AND SHOP DRAWING IN DETAIL, PROVIDE A SIGNED STATEMENT WITH EACH THAT THE DOCUMENT/ITEM IS IN CONFORMANCE WITH CONSTRUCTION DOCUMENTS, BEFORE SUBMITTAL TO THE ARCHITECT.
- B. SUBMITTALS AND SHOP DRAWINGS REQUIRED BY THE CONTRACT DOCUMENTS SHALL BE REVIEWED AND APPROVED BY THE CONTRACTOR BEFORE BEING DELIVERED TO THE ARCHITECT ALL IN A TIMELY MANNER.
- C. SUBMITTALS RECEIVED BY THE ARCHITECT THAT DO NOT PROVIDE RECORD OF THE CONTRACTORS REVIEW OF THE ITEMS WILL BE RETURNED TO THE CONTRACTOR WITHOUT REVIEW BY THE ARCHITECT.

D. MATERIAL AND EQUIPMENT

- 1. MATERIALS
- A. ONLY NEW MATERIALS SHALL BE USED IN THE CONSTRUCTION OF THE WORK INSTALLATION AND RELATED WORK SHALL BE IN STRICT ACCORDANCE WITH MANUFACTURER INSTRUCTIONS.
- 2. PRODUCTS
- A. PRODUCTS: MEANS NEW MATERIAL, MACHINERY, COMPONENTS, EQUIPMENT, FIXTURES, AND SYSTEMS FORMING THE WORK, BUT DOES NOT INCLUDE MACHINERY AND EQUIPMENT USED FOR PREPARATION, FABRICATION, CONVEYING AND ERECTION OF THE WORK.
- B. DO NOT USE MATERIALS AND EQUIPMENT REMOVED FROM OTHER PREMISES.
- C. PROVIDE INTERCHANGEABLE COMPONENTS OF THE SAME MANUFACTURER, FOR SIMILAR COMPONENTS.
- D. ALL PRODUCTS SHALL BEAR THE MANUFACTURERS LABEL AND BATCH/COLOR REFERENCE.
- 3. TRANSPORTATION AND HANDLING
- A. TRANSPORT AND HANDLE PRODUCTS IN ACCORDANCE WITH MANUFACTURER'S INSTRUCTION.
- B. PROMPTLY INSPECT SHIPMENTS TO ASSURE THAT PRODUCTS COMPLY WITH REQUIREMENTS, QUANTITIES ARE CORRECT, AND PRODUCTS FROM SAME BATHES ARE UNDAMAGED, AND FACTORY SEALED. ANY PRODUCT OR MATERIALS NOT MEETING THIS REQUIREMENT SHALL BE REPLACED AT NO EXPENSE TO THE OWNER.
- C. PROVIDE EQUIPMENT AND PERSONNEL TO HANDLE PRODUCTS USING METHODS THAT WILL PREVENT SOILING, DISFIGUREMENT OR DAMAGE.
- 4. STORAGE AND PROTECTION A. STORE AND PROTECT PRODUCTS IN ACCORDANCE WITH MANUFACTURE'S INSTRUCTIONS, WITH SEALS AND LABELS INTACT AND LEGIBLE. STORE SENSITIVE PRODUCTS IN WEATHER TIGHT, CLIMATE CONTROLLED ENCLOSURES.
- B. ALL PRODUCTS SHALL BE STORED ABOVE GRADE ON PALLETS OR SUPPORTS TO ALLOW AIRFLOW BENEATH.

STARTING OF SYSTEMS

- 1. DEMONSTRATION AND INSTRUCTIONS
- 1. FINAL CLEANING
- FOREIGN SUBSTANCES, POLISH TRANSPARENT AND GLOSSY SURFACES.
- A. EXECUTE FINAL CLEANING PRIOR TO FINAL INSPECTION. B. CLEAN INTERIOR AND EXTERIOR SURFACES: REMOVE TEMPORARY LABELS, STAINS AND C. CLEAN SITE: SWEEP PAVED AREAS, RAKE AND CLEAN LANDSCAPED SURFACES.
- D. REMOVE WASTE AND SURPLUS MATERIALS, RUBBISH AND CONSTRUCTION FACILITIES FROM THE SITE.
- 2. ADJUSTING
- A. ADJUST OPERATING PRODUCTS AND EQUIPMENT TO ENSURE SMOOTH AND UN-HINDERED OPERATION.
- 1. PROJECT RECORD DOCUMENTS (SEE "RECORD DRAWINGS")
- A. MAINTAINING ON SITE, ONE SET OF THE FOLLOWING RECORD DOCUMENTS; RECORD ACTUAL REVISIONS TO THE WORK:
- 1. CONTRACT DRAWINGS APPROVED BY THE CITY OF HUNTINGTON BEACH.
- 2. SPECIFICATIONS (INCLUDED WITH THE CONTRACT DRAWINGS).
- 3. CHANGE ORDERS AND OTHER MODIFICATIONS TO THE CONTRACT SIGNED BY THE OWNER.
- 4. ADDENDA (ISSUED DURING THE BID PHASE). 5. REVIEWED AND APPROVED SHOP DRAWINGS, PRODUCT DATA AND SAMPLES.
- B. STORE RECORD DOCUMENTS SEPARATE FROM DOCUMENTS USED FOR CONSTRUCTION.
- C. RECORD INFORMATION CONCURRENT WITH CONSTRUCTION PROGRESS.
- D. SPECIFICATIONS: LEGIBLY MARK AND RECORD AT EACH PRODUCT SECTION DESCRIPTION
- OF ACTUAL PRODUCTS INSTALLED, INCLUDING THE FOLLOWING: 1. MANUFACTURER'S NAME AND PRODUCT MODEL AND NUMBER.
- 2. PRODUCT SUBSTITUTIONS OR ALTERNATES UTILIZED.
- 3. CHANGES MADE BY ADDENDA AND MODIFICATIONS.
- ACTUAL CONSTRUCTION INCLUDING:
- 1. FIELD CHANGES OF DIMENSION AND DETAIL.

A. VERIFY THAT TESTS, METER READING, AND SPECIFIED ELECTRICAL CHARACTERISTICS AGREE WITH THOSE REQUIRED BY THE EQUIPMENT OR SYSTEM MANUFACTURER.

CONTRACT CLOSE-OUT

- E. RECORD DOCUMENTS AND SHOP DRAWINGS: LEGIBLY MARK EACH ITEM TO RECORD
- 2. DETAILS NOT ON ORIGINAL CONTRACT DRAWINGS.

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		LAKE PARK IMPROVEMENT					.1 0F 26
NTINGTON BEACH of public works		1035 11th Street Huntington Beach, Ca 926	48				

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REFERENCES		PREPARED UNDER THE SUPERVISION OF: TERRY EVANS R.A. NO.: C33095 EXP. DATE: 11-30-2021 APPROVED BY:	
	DRAWN BY:		CITY OF HUNT
	DESIGNED BY:	CHRIS TANIO, PRINCIPAL C.E. DATE	
	CHECKED BY:	R.C.E. No: <u>C82756</u> Exp. Date: <u>09/30/22</u>	DEPARTMENT OF

ADDITIONAL GENERAL NOTES:

1. TACTILE (RAISED CHARACTERS AND BRAILLE) EXIT SIGNS ARE REQUIRED ON THE WALL ADJACENT TO THE LATCH SIDE AT 60" ABOVE THE FINISH FLOOR TO THE CENTERLINE OF THE SIGN AT EACH GRADE-LEVEL EXTERIOR EXIT DOOR. \triangleright

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- ALL DOOR THRESHOLDS AND FLOOR TRANSITIONS TO BE ACCESSIBLE. (CBC) 11B-303.1 TO 11B-303.3, 11B-404.2.5.
- 3. PENETRATIONS OF FIRE RESISTIVE WALLS, FLOOR-CEILINGS AND ROOF CEILINGS SHALL BE PROTECTED AS REQUIRED IN CBC CHAPTER 7..
- 4. WALL AND CEILING MATERIALS SHALL NOT EXCEED THE FLAME SPREAD CLASSIFICATIONS IN CBC CHAPTER 8.
- 5. EVERY PRIMARY PUBLIC ENTRANCE, AND AT EVERY MAJOR FUNCTION AREA ALONG, OR LEADING TO, AN ACCESSIBLE ROUTE OF TRAVEL, THERE IS TO BE A SIGN DISPLAYING THE INTERNATIONAL SYMBOL OF ACCESSIBILITY. SIGNS ARE REQUIRED TO INDICATE THE DIRECTION TO ACCESSIBLE BUILDING ENTRANCES AND FACILITIES, PER CBC CHAPTER 11B.
- 6. INSTALL TACTILE EXIT SIGNS AT THE FOLLOWING LOCATIONS: a) WHEREVER BASIC CBC PROVISIONS REQUIRE EXIT SIGNS FROM A ROOM OR AREA TO A CORRIDOR OR HALLWAY. THE TACTILE EXIT SIGN SHALL HAVE THE WORDS "EXIT ROUTE" b) EACH GRADE-LEVEL EXIT DOOR. THE TACTILE EXIT SIGN SHALL HAVE THE WORD "EXIT". c) EACH EXIT DOOR THAT LEADS DIRECTLY TO A GRADE-LEVEL EXTERIOR EXIT BY MEANS OF A STAIRWAY OR RAMP. THE TACTILE EXIT SIGN SHALL HAVE THE FOLLOWING WORDS AS APPROPRIATE: "EXIT STAIR DOWN" / "EXIT RAMP DOWN".
- 7. THE GENERAL CONTRACTOR SHALL VERIFY ALL FIELD CONDITIONS AND DIMENSIONS ACCORDING WITH CONSTRUCTION. IF DISCREPANCIES ARE FOUND THE ARCHITECT SHALL BE NOTIFIED FOR THE CLARIFICATION BEFORE COMMENCING WITH THE WORK.
- 8. ALL WORK SHALL CONFORM TO THE REQUIREMENTS ABOVE, BY THE CITY OF HUNTINGTON BEACH AND ALL OTHER GOVERNING AUTHORITIES HAVING JURISDICTION.
- 9. BUILDING PERMITS ARE THE RESPONSIBILITY OF THE GENERAL CONTRACTOR.
- 10. DO NOT SCALE DRAWINGS. USE WRITTEN DIMENSIONS ONLY. ELEVATIONS, SECTIONS AND DETAILS TAKE PRECEDENCE OVER DIMENSIONS ON FLOOR PLANS, LARGE SCALE DETAILS GOVERN OVER SMALL.
- 11. ALL EXTERIOR WALLS AND INTERIOR PARTITION DIMENSIONS ARE FROM FACE OF STUD AND/OR CMU UNLESS OTHERWISE NOTED. CEILING HEIGHTS ARE TO BE FINISHED SURFACES UNLESS OTHERWISE NOTED.
- 12. CONFLICTS BETWEEN THE WORK SET FORTH ON THE DRAWINGS AND ANY SITE CONDITIONS, BUILDING REGULATIONS, OR QUESTIONS REGARDING CLARITY OF THE INFORMATION PROVIDED IN THE CONSTRUCTION DOCUMENTS DRAWINGS SHALL BE BROUGHT TO THE ATTENTION OF THE ARCHITECT FOR CLARIFICATION PRIOR TO PROCEEDING.
- 13. ALL SYMBOLS AND ABBREVIATIONS USED ON THE DRAWINGS ARE CONSIDERED TO BE CONSTRUCTION STANDARDS. IF THE GENERAL CONTRACTOR HAS QUESTIONS REGARDING THESE ITEMS OR THEIR EXACT MEANING, THE ARCHITECT SHOULD BE NOTIFIED FOR CLARIFICATION.
- 14. FIRE EXTINGUISHERS WILL BE REQUIRED DURING CONSTRUCTION, OR DEMOLITION AND UPON BUILDING OCCUPANCY. THE FIRE DEPARTMENT SHALL BE NOTIFIED BY THE GENERAL CONTRACTOR PRIOR TO OCCUPANCY OF THE SPACE FOR APPROVAL OF SIZES, TYPES AND LOCATIONS.
- 15. THE PULL OR PUSH EFFORT APPLIED AT RIGHT ANGLES TO HINGED DOORS AND AT THE CENTER PLANE OF SLIDING OR FOLDING DOORS SHALL NOT EXCEED 5 LBS. FOR THE EXTERIOR DOORS AND 5 LBS. AT INTERIOR DOORS. WHEN FIRE DOORS ARE REQUIRED, THE MAXIMUM EFFORT TO OPERATE THE DOOR MAY BE INCREASED NOT TO EXCEED 15 LBS.
- 16. ALL EXIT DOORS SHALL BE OPERABLE FROM THE INSIDE WITHOUT THE USE OF A KEY OR ANY SPECIAL KNOWLEDGE OR EFFORT AND SHALL HAVE SIGNS POSTED READING 'THIS DOOR TO REMAIN UNLOCKED DURING BUSINESS HOURS'.
- 17. REQUIRED EXIT SIGNS SHALL HAVE MINIMUM 3/4" X 6" LETTERS ON A CONTRASTING BACKGROUND IN ACCORDANCE WITH 2015 NFPA 101, LIFE SAFETY CODE, SECT. 7.10 & CBC SECT. 1013.
- 18. DOORS IN RATED WALLS SHALL CONSIST OF SELF-CLOSING, SELF-LATCHING ASSEMBLIES WITH SMOKE AND DRAFT SEALS AT HEAD AND JAMBS. DOOR ASSEMBLY RATINGS SHALL BE AS INDICATED ON DOOR FINISH SCHEDULE. HOLD OPEN DEVICES ON RATED ASSEMBLIES SHALL BE MAGNETICALLY OPERATED AND ACTIVATED BY SMOKE DETECTORS. ALL HOLLOW METAL FRAMES SHALL BE STEEL FRAMES. GLAZING MUST BE 1/4" THICK FIRE RATED INSTALLED IN STEEL FRAMES AND CANNOT EXCEED 100 SQ. INCHES IN AREA AND COMPLY WITH CBC SECT. 716.5.
- 19. FIRE DAMPERS OR DOORS SHALL BE PROVIDED WHERE DUCTS OR DOORS PENETRATE FIRE RATED WALLS OR CEILINGS.
- 20. THE IDENTIFICATION SYMBOLS ON DOORWAYS LEADING TO HANDICAPPED RESTROOMS SHALL BE 1/4" THICK BY 12" LONG EQUILATERAL TRIANGLE FOR MEN AND A 1/4" THICK BY 12" DIAMETER CIRCLE FOR WOMEN. SIGNS TO BE CENTERED AT 60" ABOVE FLOOR IN CONTRASTING COLOR OF THE DOOR.
- 21. APPLY PAINT TO WALLS AND CEILINGS IN ACCORDANCE TO MANUFACTURERS INSTRUCTIONS. WALLS REQUIRE MINIMUM 1 COAT SEALER AND SUFFICIENT COAT(S) OF PAINT TO PROVIDE UNIFORM COVER SEE SPECIFICATIONS.
- 22. GENERAL CONTRACTOR SHALL PROVIDE AND INSTALL ALL STIFFENERS, BRACING, BACK-UP PLATES AND SUPPORTING BRACKETS REQUIRED FOR THE INSTALLATION OF ALL CASE WORK, TOILET ROOM ACCESSORIES AND PARTITIONS AND ALL WALL MOUNTED OR SUSPENDED MECHANICAL, ELECTRICAL OR MISCELLANEOUS EQUIPMENT.
- 23. AT ALL POINTS WHERE PARTITIONS INTERSECT WINDOW MULLIONS, SOUND DEADENING MATERIAL IS TO BE INSTALLED WITHIN CONVECTOR PLENUM.
- 24. ALL RUBBISH AND DEBRIS RESULTING FROM DEMOLITION AND/OR NEW WORK SHALL BE DISPOSED OF OFF-SITE AND SHALL NOT BE ALLOWED TO ACCUMULATE.
- 25. LEAD BASED PAINT WITHIN AREA OF CONSTRUCTION SHALL BE ABATED PER CALIFORNIA CODE OF REGULATIONS TITLE 8 SECTION 1532.1.LEAD. PRIOR TO START OF CONSTRUCTION WORK.

100% CD's 3-01-2021

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SHEET NO.

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TINGTON BEACH of public works	

PROJECT NO. C2002

LAKE PARK IMPROVEMENTS 1035 11th Street Huntington Beach, Ca 92648

SHEET TITLE

GENERAL NOTES CONTINUED



City of Huntington Beach Department of Community Development 2000 Main Street, Huntington Beach, CA 92648 Office: (714) 536 - 5241 Fax: (714) 374 - 1647 CONSTRUCTION & DEMOLITION DEBRIS **RE-USE & RECYLING PROGRAM**



Construction and Demolition	(C & D) Debris V	Vaste Reduction	and I	Recycling	Plan	(WRRP
<u>construction and Demonton</u>					NCCYCHINS .		

This form must be complete for the following types of projects:

- Newly constructed building and demolition projects shall divert from landfills at least 65% of the construction materials generated during project.
- All locally permitted additions and alterations to non-residential buildings or structures shall divert from landfills
- at least 65% of nonhazardous construction and demolition materials. • Additions and alterations to residential buildings that increase the structure's conditioned area, volume or size are also required to meet the 65% minimum diversion requirement

WRRP must be submitted and APPROVED prior to issuance of building permits. Incomplete forms will be returned to applicant and may delay issuance of permit(s). Each building requires a separate WRRP. Deliver WRRP with permit application to the Building Division permit counter, 2000 Main St, 3rd Floor, Huntington Beach, CA 92648. Allow 5-10 business days for WRRP processing. You may call (714) 536 – 5241 with inquiries regarding this form.

DO NOT ATTACH ADDITIONAL ITEMS

Permit#:				How to recycle
Contact Name:		Email Address:		Who can haul debris
		City:		Where debris may g
Phone Number:		_ Fax Number:		Processing fee
For lines 1. 2 and 3. plea	use check only 1 item for each	:		Security Deposit
	New Construction			Fines
	Non-residential			
3) Tenant Improvement				Decumentation
	sq. ft.	Project Valuation: \$		Documentation
5) Estimated Start Date	/ /	Estimated Completion Date	/ /	
6) Compliance method (Check one and provide requi	red information)		How to comply
 remodel office, etc.) 8) How will scrap or was ensure salvage, re-us 	ste material be handled to e or recycling?			
9) How will employees a of recycling proposed	and sub-contractors be notifie I plan and goals?	ed		
			Page 2 of 5	
				Cit ^v Departı

HUNTINGTON BEACH *CAL*Green

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CONSTRUCTION & DEMOLI

- The categories of recyclable materials are as follows:
 - Construction and Demolition Materials: Brick, concrete, dirt, granite, gravel, pavement/asphalt and sand.
- Green Wastes: Compost, grass clippings, leaves, pruning, and Christmas trees.
- Glass: Beverage containers, crushed glass, and window panes.
- Wood: Bark, boards, planks, chips, pallets, plywood, sawdust and shavings.

Note: Although a company may designate the acceptance of materials in one or more categories, please call to verify the materials and quantities produced on your project are accepted. You may also visit Cal Recycle at http://www.calrecycle.ca.gov/condemo/recyclers/RecyclerSearch.aspx for other local dealers and facilities.

				1
Franchised Waste Hauler	C&D	Metals	Green Waste	
Rainbow Disposal 17121 Nichols Ln, Huntington Beach, CA 92647 (714) 847-3581				Same a
Recycling Facilities	C&D	Metals	Green	
			Waste	
Dan Copp Crushing Corp. 1120 N. Richfield Rd, Anaheim, CA 92807 (714)777-6400				
Aguinaga Company 16355 Construction Cir #W, Irvine, CA 92606 (949) 786-9558				
Ewles Materials (concrete, concrete blocks, asphalt only) 8200 Katella Ave Stanton, CA 90680 (714) 894-1988				
All Variety Metals, Inc 1016 Santiago St, Santa Ana, CA 92701 (714)835-9235				
NS.				

Underground Service Alert				REVISIONS		
BEFORE	REV.	DATE	BY	DESCRIPTION	APP'V'D	
Call: TOLL FREE						
1-800-422-4133						
1-600-422-4133						
TWO WORKING DAYS BEFORE YOU DIG						



City of Huntington Beach Department of Community Development 2000 Main Street, Huntington Beach, CA 92648 Office: (714) 536 - 5241 Fax: (714) 374 - 1647 **CONSTRUCTION & DEMOLITION DEBRIS**

RE-USE & RECYLING PROGRAM

Construction and Demolition (C & D) Debris Re-Use and Recycling Program

When a project is covered by the updated Huntington Beach C & D Ordinance Section 8.21, it must recycle 65% of the debris it generates. Please review the table below for our current requirements.

Planned Start Date	January 1 st , 2017
Covered projects	 Effective January 1st, 2017 Newly constructed building and demolition projects shall divert from landfills at least 65% of the construction materials generated during project. All locally permitted additions and alterations to non-residential buildings or structures shall divert from landfills at least 65% of nonhazardous construction and demolition materials. Additions and alterations to residential buildings that increase the structure's conditioned area, volume or size are also required to meet the 65% minimum diversion requirement
Materials required to be recycled	65% of all generated waste must be diverted / recycled per 2016 California Green Building Standards Code, Chapter 4, section 4.408 for all new residential and Chapter 5, section 5.408.1 – 5.408.3 and 5.713.8 – 5.713.8.3 for all non-residential new construction, additions and/or alterations. Please complete attached for C & D Debris Waste Log.
How to recycle	Mixed C & D: All debris (no wet garbage) into one bin. Source-Separated: Separate by type.
Who can haul debris	Mixed C & D: Permit-holder, self-haul or truck-haul, waste generator or franchised hauler. Source-Separated: Anyone Franchised Hauler: Republic Services (714) 847-3581
Where debris may go	Mixed C & D: City of Huntington Beach approved Mixed C & D facility such as Rainbow Disposal or see attached for other approved local processing facilities. Source-Separated: any facility that accepts the material.
Processing fee	Processing fee is currently being evaluated. Please continue to check with the Building Division counter staff for further updates.
Security Deposit	Required security deposit is currently being evaluated. Please continue to check with the Building Division counter staff for further updates.
Fines	Fines are currently being evaluated. Please continue to check with the Building Division counter staff for further updates.
Documentation	Permit-holder must keep a waste log of all materials hauled away from project site, as well as all weight tickets of disposed and recycled material. The waste log must be submitted at permit issuance, framing inspection and prior to building final approval.
How to comply	 Register your project either online using <u>Green Halo Systems</u> or by completing the Waste Reduction Recycling Plan (WRRP) form attached. Make sure to enter the Green Halo project tracking number on the WRRP form. The Green Halo System is a FREE web based system that will help you create your waste management plan, upload your recycling date throughout your construction process and generate your final report for project compliance. Create waste diversion plan in Green Halo and print out Project Information page. Submit (3) copies of the <u>Waste Diversion Form</u> and (3) copy of the waste diversion plan print-out from Green Halo with your Building Permit Application. Divert debris as specified on the plan and collect required documentation. Be sure to ask for construction debris receipts from transfer stations in order to qualify for diversion requirements. Upload recycling and disposal receipts to Green Halo. Pre-Building Final: show the Building Inspector final Green Halo report demonstrating diversion rate compliance. Note, the final report is not required for single family renovations. NOTE: If you are unable to use Green Halo, complete the <u>C & D Debris Waste Diversion Worksheet</u> instead. Fill- out the Waste Diversion Plan (non-shaded) portion of the document prior to starting your project and the Waste Diversion Report (shaded) portion of the document prior to final inspections. Assistance: For assistance with the Diversion Plan Worksheet, contact the Building Division at (714) 536 – 5241. For Green Halo Systems, please visit <u>www.greenhalosystems.com</u> or call (888) 525 – 1301 (M-F 8am to 5pm).

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ty of Huntington Beach	PROJECT ADDRESS
tment of Community Development	
ain Street, Huntington Beach, CA 92648	PERMIT NUMBER
(714) 536 - 5241 Fax: (714) 374 – 1647	
ITION DEBRIS WASTE DIVERSION WORKSHEET	DATE

LOCAL RECYCLING DEALERS / FACILITIES

Glass	Wood	Recycling Facilities	C&D	Metals	Green Waste	Glass	Wood
		Huntington Beach Recycling 7632 Slater Ave, Huntington Beach, CA 92647 (714) 841-4885					
		Rainbow Disposal 17121 Nichols Ln, Huntington Beach, CA 92647 (714) 847-3581					
Glass	Wood	Recycling Facilities	C&D	Metals	Green Waste	Glass	Wood
		Madison Materials 1035 East 4 th St, Santa Ana, CA 92701 (714) 664-0159					
		R.J. Noble 15505 E. Lincoln Ave, Orange, CA 92865 (714) 637-1550	3				
		TVI Gold Coast Recycling 7973 Irvine Blvd, Irvine, CA 92618 (949) 551-0363					
		Sunset Environmental 16122 Construction Cir #E, Irvine, CA 92606 (949) 654-1562	3				
	REF	FERENCES					
					DRAWN BY		
					DESIGNED	BY:	

CHECKED BY:



City of Huntington Beach **Department of Community Development** 2000 Main Street, Huntington Beach, CA 92648 Office: (714) 536 - 5241 Fax: (714) 374 – 1647 CONSTRUCTION & DEMOLITION DEBRIS WASTE DIVERSION WORKSHEET

Pre-Project Waste Diversion Plan (non-shaded portion). Indicate diversion method with an 'X' in appropriate column along with the name of vendor/facility. Calculate anticipated diversion and landfill percentage of each material type. If you are sending mixed construction debris to a transfer station for sorting, enter the same destination for all materials in the mix. List deconstructed items for reuse on-site (donated / sold), on the next page. Include the approximate weight in the column for reusable items.

Post-Project Waste Diversion Report (shaded portion). Enter actual weight in pounds for each category. Calculate weight column total and diversion rate. Keep all receipts for final report.

If applicant is using Green Halo online tracking system, this worksheet (including Waste Diversion Plan & Waste Diversion Report) is NOT REQUIRED! Green Halo offers a free web-based Waste Management Plan and Project Tracking System which can be found by visiting https://www.greenhalosystems.com.

WASTE DIVERSION PLAN (FOR PLAN CH	ECK ONLY)							WAS	TE DIVERSION REPORT (FOR FINAL	NSPECTION	ONLY)		
MATERIAL		ANTICIPATED						ACTU	JAL (See weight conversion factors n	ext page)	DIV	DIVERSION RATE	
				DIVERSION			WASTE	DIVERTED MATERIALS ALL METHODS WAST			WASTE		
	REUSE	RECYCLE	COMPOST	Estimate % of each material	VENDOR/FACILITY	LANDFILLED	ESTIMATED % OF LAND DFILL MATERIAL	DIVERTED (lbs)	VENDOR/FACILITY	LANDFILLED (Ibs)	TOTAL DIVERTED + LANDFILLED		
ASPHALT			N/A	100%						-		100% REQUIRED	
CONCRETE			N/A	100%						1	-	100% REQUIRED	
DIRT & ROCK (From previously undeveloped lots)			N/A	100%								100% REQUIRED	
AT LEAST 65% DIVERSION OF THE FOLL OF MATERIALS BELOW.	DWING MA	FERIALS.	DIVERSI	ON BASED OI	N AMOUNT OF THE CO	MBINED	TOTAL WEIGHT	Α		В			
CARDBOARD													
CARPET, PADDING/FOAM													
BRICK, MASONRY, TILE									-				
METALS													
PLANT DEBRIS													
SHEETROCK (Not painted)													
CLEAN WOOD													
CEILING TILE									-				
PAINTED WOOD,													
PAINTED.DRYWALL PLYWOOD										-	-		
REUSABLE ITEMS								-	(COMPLETE REUSE LIST NEXT	-		TOTAL	
ROOFING								-		-	TOTAL	TOTAL %	
OTHER DEBRIS								-			TOTAL	DIVERTED	
OTHER DEBRIS								-		-	(lbs)	A/(A+B) X 100	
							TOTAL						



Reusable items such as cabinets, built-ins, framing lumber, siding, etc. are encouraged to be reused on-site. Please list accordingly.

ITEM	USE LOC	CATION	OFF-SITE BENEFACTOR OR DECONSTRUCTION COMPANY
	□ ON-SITE	□ OFF-SITE	
	□ ON-SITE	□ OFF-SITE	
	□ ON-SITE	□ OFF-SITE	

Use the following conversion factors as well as receipts from previous jobs to help you with your estimated diversion for the Waste Diversion Plan. The Waste Diversion Report is a record of your actual diversion and disposal. The Waste Diversion Report and receipts from landfills, transfer stations and recyclers must be available for review at your final building inspection.

Asphalt paving, crushed = 1,380 lbs / cubic yard	Concrete, scraps, loose = 1,855 lbs / cubic yard
Asphalt/shingles comp, loose = 418.5 lbs / cubic yard	Earth, loose = 2,052 lbs / cubic yard
Brick, laid flat = 20 lbs / square foot flat	Fiberglass insulation, loose = 17 lbs / cubic yard
Brick, loose = 120 lbs / cubic foot, 3,200 lbs / cubic yard	Sheetrock scrap, loose = 393.5 lbs / cubic yard
Ceramic tile, scrap, loose = 1,214 lbs / cubic yard	Rock, crushed = 2,570 lbs / cubic yard

Please submit three (3) copies of this worksheet with your building permit application and this worksheet shall be electronically placed / made a part of plans.

For instructions on how to fill out this form, see "Waste Diversion Worksheet Instructions" located online at the Building Division website under Frequently **Requested Forms.**

For more information, visit <u>http://www.huntingtonbeachca.gov/government/departments/planning-building</u> or contact the Building Division at (714) 536 – 5241.

PREPARED UNDER THE SUPERVISION OF:	2
TERRY EVANS	
R.A. NO.: <u>C33095</u> EXP. DATE: <u>II-30-2021</u>	
APPROVED BY:	
CHRIS TANIO, PRINCIPAL C.E.DATER.C.E. No:C82756Exp. Date:09/30/22	CITY C
	TERRY EVANS R.A. NO.: C33095 EXP. DATE: 11-30-2021 APPROVED BY:

PROJECT ADDRESS

PERMIT NUMBER

DATE

Page 3 of 5

PROJECT ADDRESS

PERMIT NUMBER

DATE

City of Huntington Beach **Department of Community Development** 2000 Main Street, Huntington Beach, CA 92648 Office: (714) 536 - 5241 Fax: (714) 374 - 1647 CONSTRUCTION & DEMOLITION DEBRIS WASTE DIVERSION WORKSHEET

WEIGHT CONVERSION FACTORS

PROJECT NO. C2002)F HUNTINGTON BEACH TMENT OF PUBLIC WORKS

SHEET TITLE CONSTRUCTION & DEMOLITION DEBRIS DIVERSION WORKSHEE LAKE PARK IMPROVEMENTS **1035 11th Street** Huntington Beach, Ca 92648

No.C33095


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	R.A. NO.: C33095 EXP. DATE: II-30-
	R.A. NO.: <u>C33093</u> EXP. DATE: <u>II-30-</u>
	APPROVED BY:
DRAWN BY:	
DESIGNED BY:	CHRIS TANIO, PRINCIPAL C.E. DA
	BCE No. 092756 Eve Deta: 00 /20 /20

COLOR AND FINISH PER ARCH PLA	WITH 18" WIDE BANDING PER ARCH PLANS
(4)— CONST. 6" THICK CONCRETE PAD PE	
 (5)— NOT USED (6)— CONST. 0" TO 8" CURB TRANSITION STD PLAN NO. 201 AS MODIFIED P 	
(7)— CONST. AC SLOT PATCH PER DETAIL (P)— PROTECT IN PLACE	



<u>GRADING GENERAL NOTES</u>	EROSION CONTROL GENERAL NOTES
1. ALL GRADING SHALL BE DONE IN ACCORDANCE WITH THE CITY OF HUNTINGTON BEACH REQUIREMENTS.	1. EROSION CONTROL IS REQUIRED FOR GRADING OPERATIONS DURING "DRY SEASON" REQUIREMENTS (MAY 1 30) AND FOR "WET SEASON" REQUIREMENTS (OCTOBER 1 THROUGH APRIL 30). APPROVED PLANS ARE RE
2. CITY OF HUNTINGTON BEACH GRADING INSPECTOR IS TO BE NOTIFIED 48 HOURS PRIOR TO ANY GRADING AT THE DEPARTMENT OF PUBLIC WORKS, (714) 536–5431.	GRADING OPERATIONS.
3. DUST SHALL BE CONTROLLED BY WATERING.	2. IN CASE OF EMERGENCY CALL:
4. REMOVE ALL VEGETATION AND DEBRIS PRIOR TO ANY GRADING, INSPECTION IS REQUIRED.	JEFF SCOTT ICG, INC. (RESPONSIBLE PERSON) (FIRM)
5. ALL WORK WITHIN THE PUBLIC RIGHT-OF-WAY REQUIRES A SEPARATE ENCROACHMENT PERMIT.	AT 909-322-5590
	(24 HOUR PHONE NO.)
6. IMPORT SOIL SHALL BE A GRANULAR MATERIAL WITH LOW EXPANSION POTENTIAL AND SHALL BE COMPACTED TO AT LEAST 90%.	3. THE DESIGN CIVIL ENGINEER WILL SUPERVISE EROSION CONTROL WORK AND ENSURE THAT WORK IS IN ACCU THE APPROVED PLANS (IF REQUIRED).
7. THE SUBGRADE OF THE DRIVEWAY AND PARKING AREAS SHALL BE SCARIFIED, BROUGHT TO OPTIMUM MOISTURE CONTENT, AND COMPACTED TO AT LEAST 90%. CALL FOR CITY INSPECTION PRIOR TO PLACING CLASS 2 AGGREGATE BASE AND CASTING OF CONCRETE GUTTERS.	4. THERE SHALL BE A "WEATHER TRIGGERED" ACTION PLAN AND THE ABILITY TO DEPLOY STANDBY SEDIMENT AS NEEDED TO PROTECT ALL EXPOSED PORTIONS OF THE SITE WITHIN 48 HOURS OF A PREDICTED STORM
8. A SOIL COMPACTION REPORT SHALL CERTIFY COMPACTION WITHIN BUILDING AND PAVING AREAS.	(A PREDICTED STORM EVENT IS DEFINED AS A NATIONAL WEATHER SERVICE FORECASTED, 50% CHANCE OF
9. A LICENSED ENGINEER, OR A LICENSED LAND SURVEYOR, SHALL CERTIFY LINE AND GRADE OF FINISH FLOOR FORMS.	5. EROSION CONTROL DEVICES SHALL NOT BE MOVED OR MODIFIED WITHOUT THE APPROVAL OF THE CITY ENG
10. THE SOILS ENGINEER SHALL CERTIFY THAT ALL GRADING HAS BEEN COMPLETED PER THE SOILS REPORT PRIOR TO FINAL	6. ALL REMOVABLE PROTECTIVE EROSION CONTROL DEVICES SHOWN SHALL BE IN PLACE AT THE END OF EAC
RELEASE.	7. AFTER A RAINSTORM, ALL SILT AND DEBRIS SHALL BE REMOVED FROM CHECK BERMS, SILT FENCES, AND L
11. THE ENGINEER OR ARCHITECT OF RECORD SHALL CERTIFY THAT GRADES FOR ALL HARDSCAPE AND DRAINAGE DEVICES HAVE BEEN CONSTRUCTED PER APPROVED GRADING PLAN PRIOR TO FINAL RELEASE.	8. GRADED AREAS AROUND THE TRACT PERIMETER MUST DRAIN AWAY FROM THE FACE OF SLOPE AT THE CO WORKING DAY.
12. ALL GRADING SHALL BE DONE IN ACCORDANCE WITH APPROVED SOILS REPORT NOTED HEREIN.	9. THE CONTRACTOR SHALL BE RESPONSIBLE AND SHALL TAKE NECESSARY PRECAUTIONS TO PREVENT PUBLIC AREAS WHERE IMPOUNDED WATER CREATES A HAZARDOUS CONDITION.
13. STANDARD PLAN 100, SHEETS 1, 2, 3 AND 4 ARE INCORPORATED BY REFERENCE.	10. THE CITY ENGINEER RESERVES THE RIGHT TO MAKE CHANGES OR MODIFICATIONS TO THIS PLAN AS DEEMEL
14. THE SOILS ENGINEER AND CIVIL ENGINEER SHALL NOT BE SUBSTITUTED WITHOUT PRIOR WRITTEN APPROVAL FROM THE DIRECTOR OF PUBLIC WORKS.	11. INFORMATION ON THIS PLAN IS FOR EROSION CONTROL ONLY. ALL OTHER INFORMATION IS SUBJECT TO CI
15. USE THE AMERICAN PUBLIC WORKS ASSOCIATION SOUTHERN CALIFORNIA CHAPTER (APWA) WORK AREA TRAFFIC CONTROL HANDBOOK (WATCH MANUAL) TENTH EDITION, 2006 WHEN WORKING IN THE STREETS OR ALLEYS. THE CITY INSPECTOR SHALL APPROVE BARRICADING PRIOR TO ANY WORK.	12. AREAS SHALL BE MAINTAINED IN SUCH A STATE THAT FIRE ACCESS SHALL BE MAINTAINED AT ALL TIMES NEIGHBORING PROPERTIES).
16. STANDARD PLAN 600 GENERAL NOTES ARE INCORPORATED BY REFERENCE.	13. NO OBSTRUCTION OR DISTURBANCE OF NATURAL DRAINAGE COURSES OR EXISTING STORM DRAIN INLETS SH "WET SEASON", UNLESS ADEQUATE TEMPORARY/ PERMANENT DRAINAGE FACILITIES HAVE BEEN APPROVED CARRY SURFACE WATER TO THE NEAREST PRACTICAL STREET, STORM DRAIN OR NATURAL WATER COURSE.
17. ANY DAMAGE TO THE STREET LIGHT SYSTEM AND/OR TRAFFIC SIGNAL SYSTEM SHALL BE REPAIRED AND CONDUIT AND CONDUCTORS SHALL BE REPLACED PER CURRENT HUNTINGTON BEACH STANDARD PLANS AND STANDARD SPECIAL PROVISIONS FOR THE CONSTRUCTION OF TRAFFIC SIGNALS AND LIGHTING SYSTEMS IN THE CITY OF HUNTINGTON BEACH 2001 EDITION.	14. THE CONTRACTOR SHALL CONDUCT HIS OPERATIONS IN SUCH A MANNER THAT STORM RUNOFF WILL BE CO PROJECT OR CHANNELED INTO THE STORM DRAIN SYSTEM WHICH SERVES THE RUNOFF AREA. STORM RUN SHALL NOT BE ALLOWED TO DIVERT TO ANOTHER RUNOFF AREA.
18. REFER TO LANDSCAPE ARCHITECT PLANS FOR ADDITIONAL INFORMATION AND SLEEVING THAT MAY BE REQUIRED.	15. CONFORMANCE WITH THE REQUIREMENTS OF THESE PLANS SHALL IN NO WAY RELIEVE THE CONTRACTOR FR RESPONSIBILITIES TO THIS SITE AND ADJACENT PROPERTIES. TEMPORARY EROSION CONTROL SHALL CO LIMITED TO, CONSTRUCTING SUCH FACILITIES AND TAKING SUCH MEASURES AS ARE NECESSARY TO PREVEN WATER, MUD AND EROSION DAMAGE TO PUBLIC AND PRIVATE PROPERTY AS A RESULT OF THE CONSTRUCT PROJECT.
	16. CLEARING AND GRUBBING SHOULD BE LIMITED TO AREAS THAT WILL RECEIVE IMMEDIATE GRADING. EROSION WILL BE REQUIRED TO PROTECT AREAS THAT HAVE BEEN CLEARED AND GRUBBED PRIOR TO GRADING OPEF SUBJECT TO RUNOFF DURING THE PERIOD FROM THE BEGINNING OF THE "WET SEASON". THESE MEASURES SHALL NOT BE LIMITED TO: GRADED DITCHES; BRUSH BARRIERS AND SILT FENCES. CARE SHALL BE EXEN VEGETATION BEYOND THE LIMITS OF GRADING.
	17. CITY APPROVAL OF PLANS DOES NOT RELIEVE THE DEVELOPER FROM RESPONSIBILITY FOR THE CORRECTION

Underground Service Alert		REVISIONS		REFERENCES		PREPARED UNDER THE SUPERVISION OF:	
Cal: TOLL FREE 1-800-422-4133	REV. DATE BY	DESCRIPTION	APP'V'D			TERRY EVANS R.A. NO.: C33095 EXP. DATE: 11-30-2021 APPROVED BY:	
TWO WORKING DAYS BEFORE YOU DIG					DRAWN BY: DESIGNED BY: CHECKED BY:	CHRIS TANIO, PRINCIPAL C.E. DATE R.C.E. No: <u>C82756</u> Exp. Date: <u>09/30/22</u>	CITY OF HUN DEPARTMENT

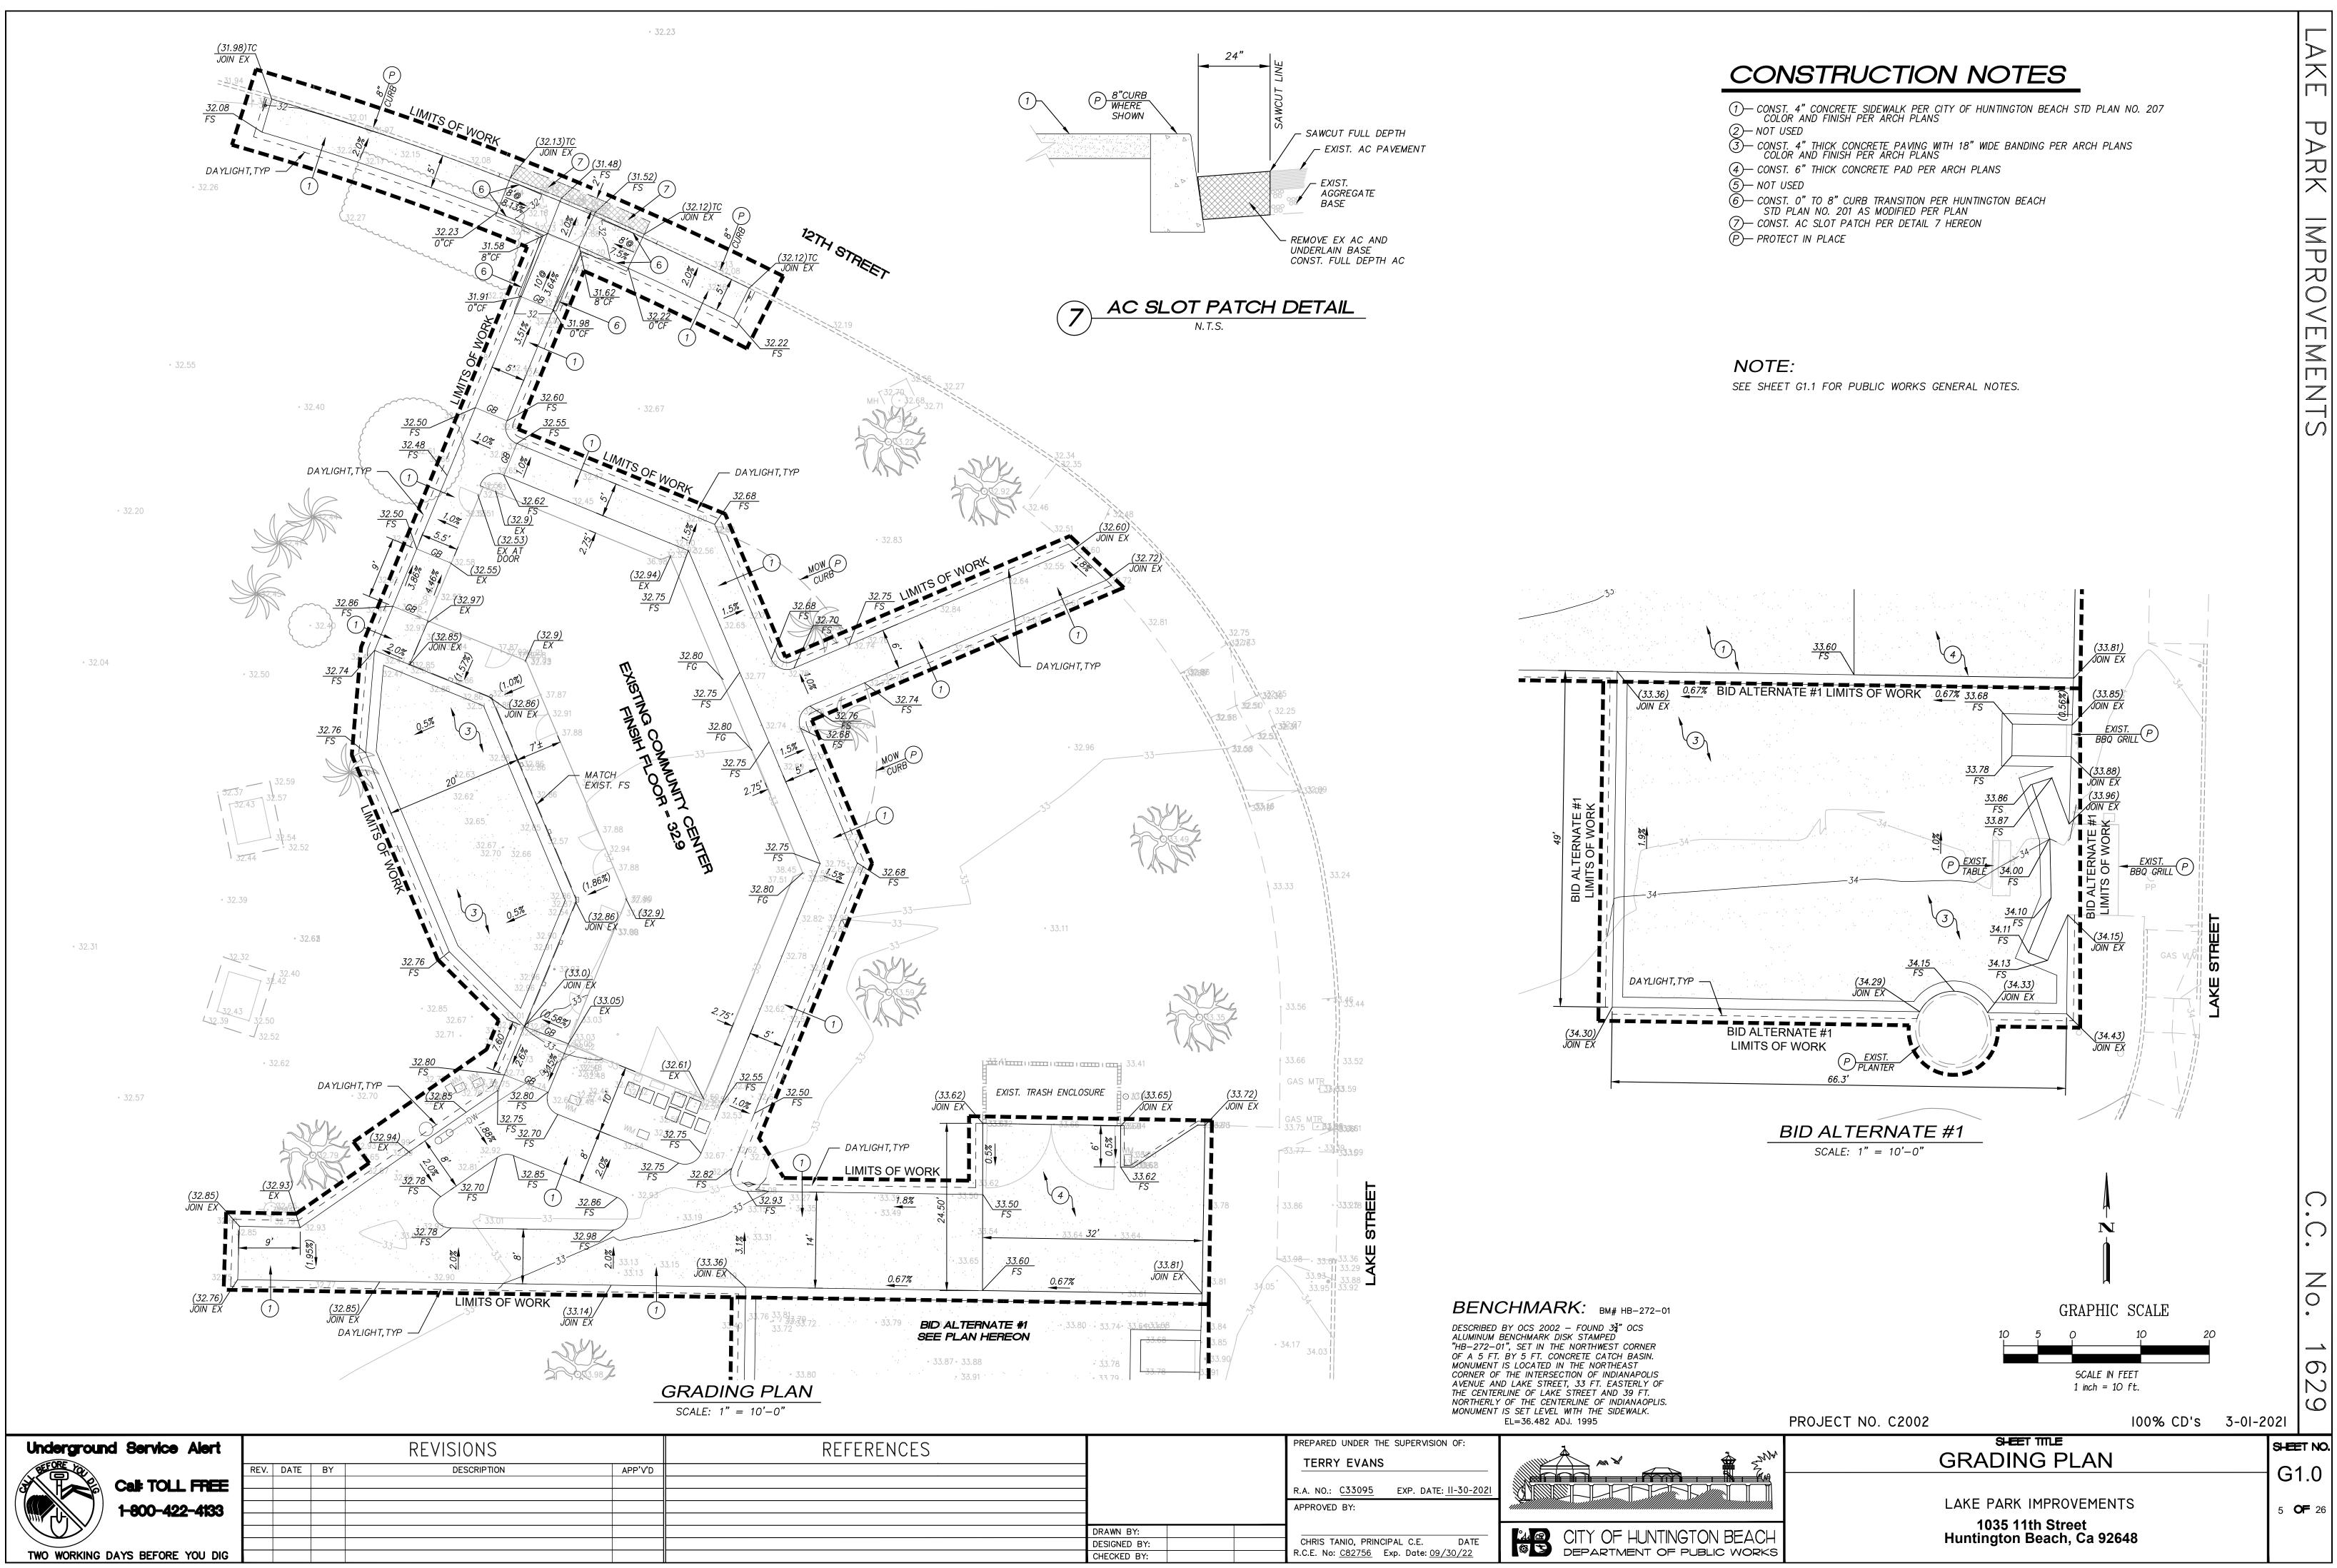SION CONTROL GENERAL NOTES

ON CONTROL IS REQUIRED FOR GRADING OPERATIONS DURING "DRY SEASON" REQUIREMENTS (MAY 1 THROUGH SEPTEMBER ND FOR "WET SEASON" REQUIREMENTS (OCTOBER 1 THROUGH APRIL 30). APPROVED PLANS ARE REQUIRED FOR ALL ROUGH NG OPERATIONS.

SIGN CIVIL ENGINEER WILL SUPERVISE EROSION CONTROL WORK AND ENSURE THAT WORK IS IN ACCORDANCE WITH PPROVED PLANS (IF REQUIRED).

SHALL BE A "WEATHER TRIGGERED" ACTION PLAN AND THE ABILITY TO DEPLOY STANDBY SEDIMENT CONTROL BMP'S EDED TO PROTECT ALL EXPOSED PORTIONS OF THE SITE WITHIN 48 HOURS OF A PREDICTED STORM EVENT EDICTED STORM EVENT IS DEFINED AS A NATIONAL WEATHER SERVICE FORECASTED, 50% CHANCE OF RAIN).

ON CONTROL DEVICES SHALL NOT BE MOVED OR MODIFIED WITHOUT THE APPROVAL OF THE CITY ENGINEER.

EMOVABLE PROTECTIVE EROSION CONTROL DEVICES SHOWN SHALL BE IN PLACE AT THE END OF EACH WORKING DAY.

A RAINSTORM, ALL SILT AND DEBRIS SHALL BE REMOVED FROM CHECK BERMS, SILT FENCES, AND DESILTING BASINS, ETC.

ED AREAS AROUND THE TRACT PERIMETER MUST DRAIN AWAY FROM THE FACE OF SLOPE AT THE CONCLUSION OF EACH ING DAY.

ONTRACTOR SHALL BE RESPONSIBLE AND SHALL TAKE NECESSARY PRECAUTIONS TO PREVENT PUBLIC TRESPASS ONTO WHERE IMPOUNDED WATER CREATES A HAZARDOUS CONDITION.

ITY ENGINEER RESERVES THE RIGHT TO MAKE CHANGES OR MODIFICATIONS TO THIS PLAN AS DEEMED NECESSARY.

MATION ON THIS PLAN IS FOR EROSION CONTROL ONLY. ALL OTHER INFORMATION IS SUBJECT TO CHANGE. SHALL BE MAINTAINED IN SUCH A STATE THAT FIRE ACCESS SHALL BE MAINTAINED AT ALL TIMES (INCLUDING ACCESS TO

BORING PROPERTIES). STRUCTION OR DISTURBANCE OF NATURAL DRAINAGE COURSES OR EXISTING STORM DRAIN INLETS SHALL OCCUR DURING THE SEASON", UNLESS ADEQUATE TEMPORARY/ PERMANENT DRAINAGE FACILITIES HAVE BEEN APPROVED AND INSTALLED TO

ONTRACTOR SHALL CONDUCT HIS OPERATIONS IN SUCH A MANNER THAT STORM RUNOFF WILL BE CONTAINED WITHIN THE CT OR CHANNELED INTO THE STORM DRAIN SYSTEM WHICH SERVES THE RUNOFF AREA. STORM RUNOFF FROM ONE AREA NOT BE ALLOWED TO DIVERT TO ANOTHER RUNOFF AREA.

RMANCE WITH THE REQUIREMENTS OF THESE PLANS SHALL IN NO WAY RELIEVE THE CONTRACTOR FROM HIS NSIBILITIES TO THIS SITE AND ADJACENT PROPERTIES. TEMPORARY EROSION CONTROL SHALL CONSIST OF, BUT NOT BE TO, CONSTRUCTING SUCH FACILITIES AND TAKING SUCH MEASURES AS ARE NECESSARY TO PREVENT, CONTROL AND ABATE MUD AND EROSION DAMAGE TO PUBLIC AND PRIVATE PROPERTY AS A RESULT OF THE CONSTRUCTION OF THIS ECT.

NG AND GRUBBING SHOULD BE LIMITED TO AREAS THAT WILL RECEIVE IMMEDIATE GRADING. EROSION CONTROL MEASURES E REQUIRED TO PROTECT AREAS THAT HAVE BEEN CLEARED AND GRUBBED PRIOR TO GRADING OPERATION, AND THAT ARE CT TO RUNOFF DURING THE PERIOD FROM THE BEGINNING OF THE "WET SEASON". THESE MEASURES MAY INCLUDE BUT NOT BE LIMITED TO: GRADED DITCHES; BRUSH BARRIERS AND SILT FENCES. CARE SHALL BE EXERCISED TO PRESERVE TION BEYOND THE LIMITS OF GRADING.


PPROVAL OF PLANS DOES NOT RELIEVE THE DEVELOPER FROM RESPONSIBILITY FOR THE CORRECTION OF ERRORS AND OMISSIONS DISCOVERED DURING CONSTRUCTION. UPON REQUEST, THE REQUIRED PLAN REVISIONS SHALL BE PROMPTLY SUBMITTED TO THE CITY ENGINEER FOR APPROVAL.

NPDES GENERAL NOTES


- 1. SEDIMENT FROM AREAS DISTURBED BY CONSTRUCTION SHALL BE RETAINED ON SITE USING INDUSTRY ACCEPTED BEST MANAGEMENT PRACTICES (BMPS). THESE BMPS SHALL BE INSTALLED PRIOR TO ANY CONSTRUCTION ACTIVITY SUCH AS GRADING THAT MAY CAUSE SOIL DISTURBANCE. THESE BMPS ARE TO BE MAINTAINED YEAR-ROUND OR UNTIL ALL LOOSE SEDIMENT HAS BEEN STABILIZED.
- 2. STOCKPILES OF SOIL SHALL BE PROPERLY CONTAINED TO MINIMIZE SEDIMENT TRANSPORT FROM THE SITE TO STREETS, DRAINAGE FACILITIES AND ADJACENT PROPERTIES VIA RUNOFF, VEHICLE TRACKING, OR WIND. STOCKPILED MATERIAL SHALL BE NO MORE THAN 8 FEET IN HEIGHT AND SHALL BE COMPLETELY COVERED WITH A SECURE IMPERMEABLE COVER AT THE END OF EACH WORK DAY. ALL STOCKPILES SHALL BE LOCATED AWAY FROM ANY STORM DRAIN INLETS AND AWAY FROM ANY STORM WATER CONVEYANCE STRUCTURES. AT NO TIME SHALL ANY RAW MATERIAL BE STAGED OR STOCKPILED ON CITY STREETS, SIDEWALKS, AND/OR GUTTERS WITHOUT A VALID OBSTRUCTION PERMIT.
- 3. APPROPRIATE BMPS FOR CONSTRUCTION-RELATED MATERIALS, WASTES, SPILLS OR RESIDUES SHALL BE IMPLEMENTED TO MINIMIZE TRANSPORT FROM THE SITE TO STREETS, DRAINAGE FACILITIES, AND ADJOINING PROPERTY BY WIND OR RUNOFF.
- 4. RUNOFF FROM EQUIPMENT AND VEHICLE WASHING SHALL BE CONTAINED ON THE CONSTRUCTION SITE AND SHALL NOT BE DISCHARGED TO RECEIVING WATERS OR TO THE STORM DRAIN SYSTEM.
- 5. CONCRETE WASH OUT WATER SHALL BE CONTAINED IN A WATER-TIGHT DEVICE TO PREVENT CEMENT DEPOSITION ONTO THE
- GROUND AND RUNOFF INTO STREETS, DRAINAGE FACILITIES, AND RECEIVING WATERS.
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- 7. AT THE END DISPOSED IN
- 8. CONSTRUCTIO OFF THE SITE AS AUTHORIZ
- 9. ALL UNPAVED CONTROL BMI INSPECTED D
- 10. ALL TEMPOR ANY STORM
- 11. POLLUTANTS RESOURCE. I PAINTS, STAII ASBESTOS FIL FLUIDS; CON CLEANING OR FLUSHINGS A
- 12. DURING CON DESIGNATED ULTIMATE DIS
- 13. DISCHARGING CONSTRUCTIO DISCHARGING DISCHARGE
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	ALL CONSTRUCTION CONTRACTOR AND SUBCONTRACTOR PERSONNEL ARE TO BE MADE AWARE OF THE REQUIRED BMPS AND GOOD HOUSEKEEPING MEASURES FOR THE PROJECT SITE AND ANY ASSOCIATED CONSTRUCTION STAGING AREAS.	
	AT THE END OF EACH WORK DAY, ALL CONSTRUCTION DEBRIS AND WASTE MATERIALS SHALL BE COLLECTED AND PROPERLY DISPOSED IN COVERED TRASH OR RECYCLE BINS.	
	CONSTRUCTION SITES SHALL BE MAINTAINED IN SUCH A CONDITION THAT STORMWATER DOES NOT CARRY WASTES OR POLLUTANTS OFF THE SITE. DISCHARGES OF MATERIALS OTHER THAN STORMWATER (NON—STORMWATER DISCHARGES) ARE PROHIBITED EXCEPT AS AUTHORIZED BY AN INDIVIDUAL NPDES PERMIT OR THE STATEWIDE GENERAL CONSTRUCTION STORMWATER PERMIT.	
	ALL UNPAVED CONSTRUCTION ENTRANCES AND EXITS SHALL BE PROTECTED USING AN EFFECTIVE COMBINATION OF TRACKING CONTROL BMPS TO MINIMIZE AND/OR ELIMINATE OFF—SITE TRACKING OF SEDIMENT. THESE BMPS SHALL BE MAINTAINED AND INSPECTED DAILY.	
	D. ALL TEMPORARY PORTABLE RESTROOMS MUST HAVE A CATCHMENT PAN AND MUST BE LOCATED AT LEAST 50 FEET AWAY FROM ANY STORM DRAIN INLETS.	
	. POLLUTANTS ARE ANY SUBSTANCES INTRODUCED INTO THE ENVIRONMENT THAT ADVERSELY AFFECTS THE USEFULNESS OF A RESOURCE. POTENTIAL POLLUTANTS INCLUDE, BUT ARE NOT LIMITED TO: SEDIMENT; SOLID OR LIQUID CHEMICALS SUCH AS: PAINTS, STAINS, SEALANTS, SOLVENTS, DETERGENTS, GLUES, LIME, PESTICIDE, HERBICIDE, FERTILIZERS, WOOD PRESERVATIVES AND ASBESTOS FIBERS, PAINT FLAKES OR STUCCO FRAGMENTS; FUELS, OILS, LUBRICANTS, AND HYDRAULIC, RADIATOR OR BATTERY FLUIDS; CONCRETE, AND RELATED CUTTING OR CURING RESIDUES; FLOATABLE WASTES; WASTES FROM ENGINE / EQUIPMENT STEAM CLEANING OR CHEMICAL DEGREASING; WASTES FROM STREET CLEANING; AND SUPER-CHLORINATED POTABLE WATER FROM LINE FLUSHINGS AND TESTING.	
	2. DURING CONSTRUCTION, DISPOSAL OF SUCH MATERIALS SHOULD OCCUR IN A SPECIFIED AND CONTROLLED MANNER. A DESIGNATED TEMPORARY AREA ON—SITE SHALL BE PHYSICALLY SEPARATED FROM POTENTIAL STORMWATER RUNOFF, WITH ULTIMATE DISPOSAL IN ACCORDANCE WITH LOCAL, STATE AND FEDERAL REQUIREMENTS.	
	5. DISCHARGING CONTAMINATED GROUNDWATER, PRODUCED BY DEWATERING GROUNDWATER THAT HAS INFILTRATED INTO THE CONSTRUCTION SITE IS PROHIBITED. DISCHARGING OF CONTAMINATED SOILS VIA SURFACE EROSION IS ALSO PROHIBITED. DISCHARGING NON—CONTAMINATED GROUNDWATER PRODUCED BY DEWATERING ACTIVITIES REQUIRES A NATIONAL POLLUTANTS DISCHARGE ELIMINATION SYSTEM (NPDES) PERMIT FROM THE RESPECTIVE STATE REGIONAL WATER QUALITY CONTROL BOARD.	
	. DISCHARGES OF STORM WATER FROM CONSTRUCTION SITES SHALL NOT BE LADEN WITH SEDIMENT. ALL STORM WATER DISCHARGES MUST BE RELATIVELY FREE OF SEDIMENT.	
15.	5. ALL CONTRACTORS AND CONSTRUCTION PERSONNEL SHALL MEET THE REGULATORY CONSTRUCTION REQUIREMENTS ON THE PROJECT SITE IN COMPLIANCE WITH THE CITY'S MUNICIPAL CODE 14.25, STORMWATER AND URBAN RUNOFF MANAGEMENT AND MUNICIPAL CODE 17.05, GRADING AND EXCAVATION CODE.	
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REFERENCES		PREPARED UNDER THE SUPERVISION OF: TERRY EVANS		
		R.A. NO.: <u>C33095</u> EXP. DATE: <u>II-30-2021</u>		
	DRAWN BY:	APPROVED BY:		
	DRAWN BY: DESIGNED BY: CHECKED BY:	CHRIS TANIO, PRINCIPAL C.E. DATE R.C.E. No: <u>C82756</u> Exp. Date: <u>09/30/22</u>	CITY OF HUNTINGTO	IN BEACH





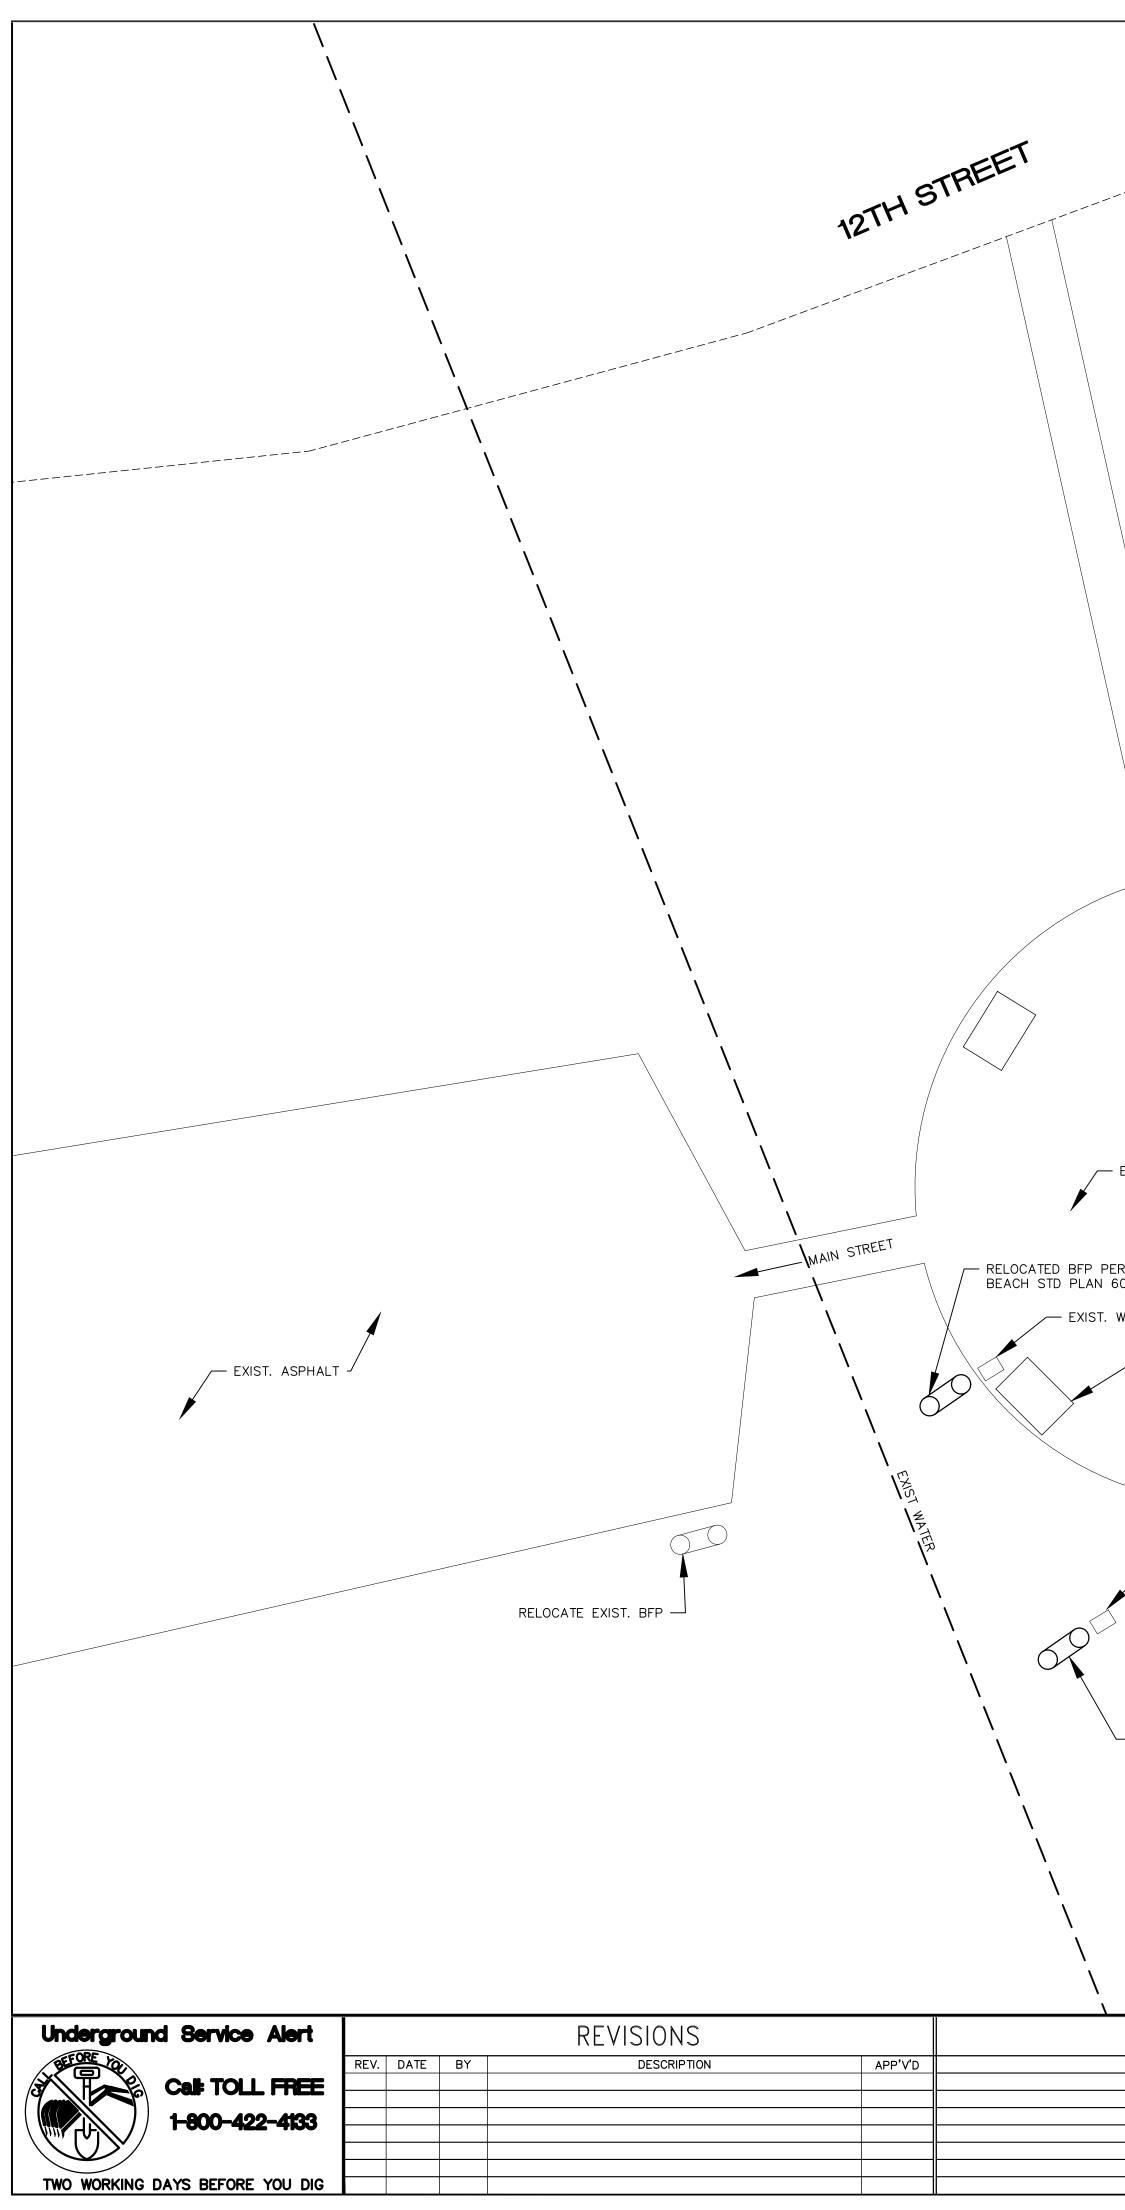

Site Image #1

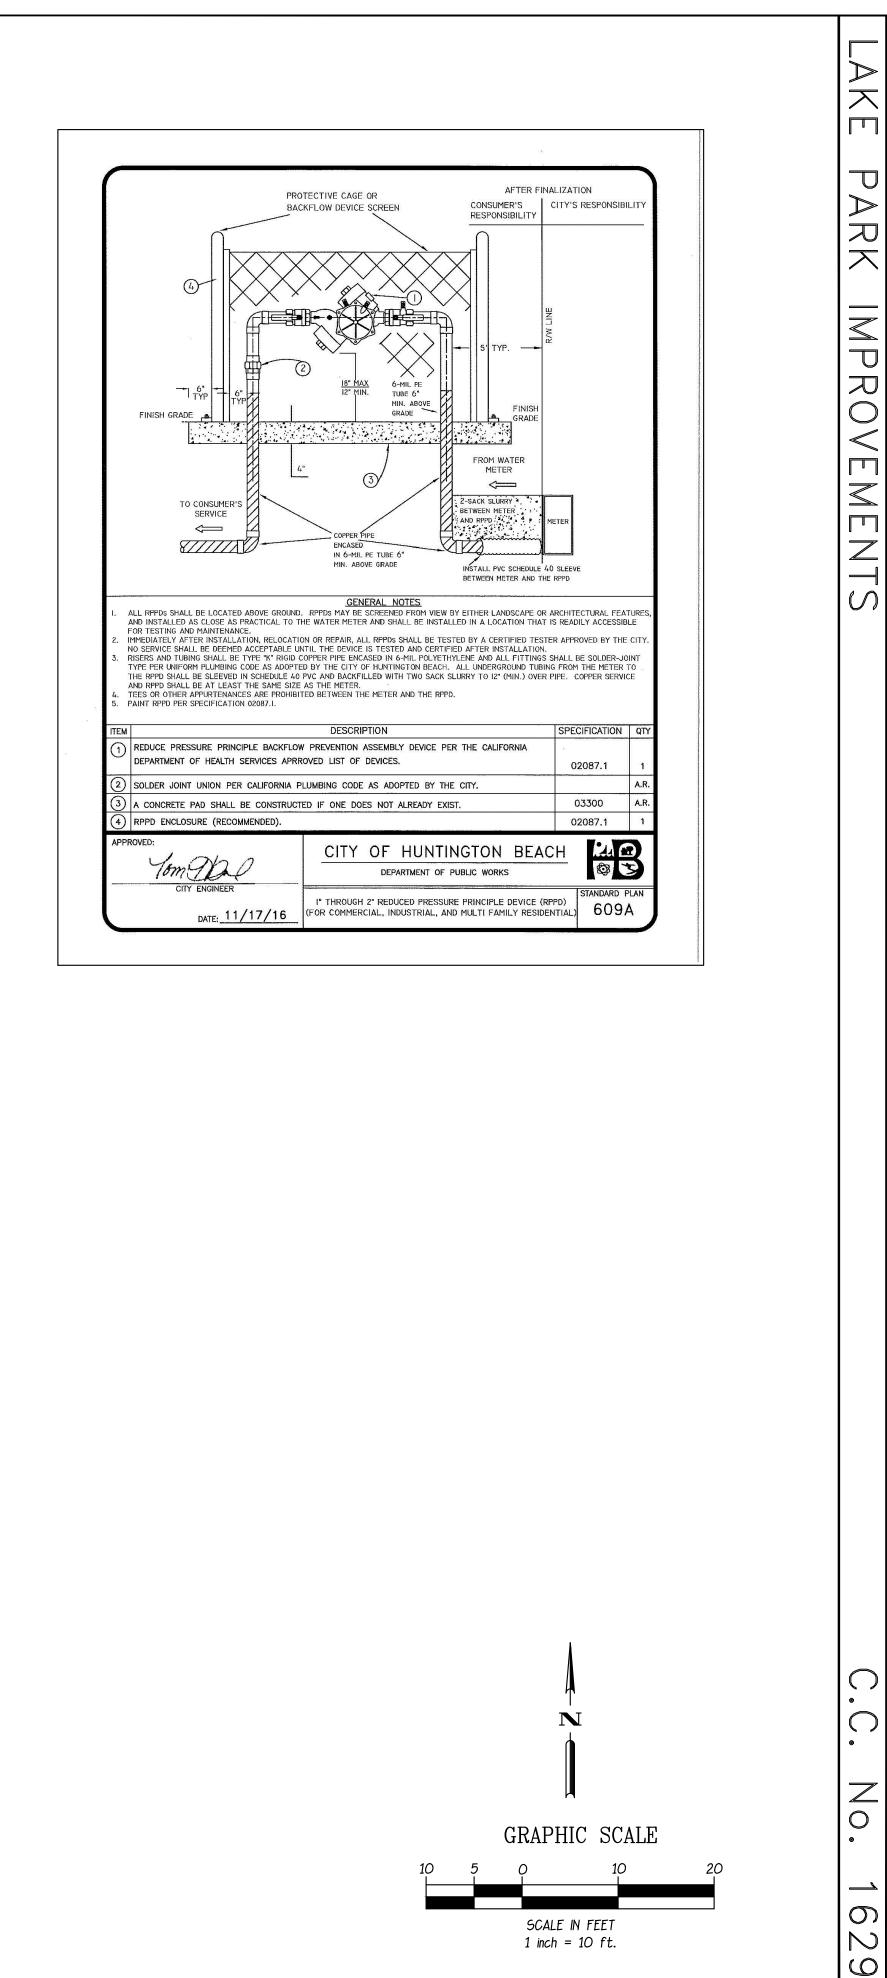

Site Image #4





Site Image #10



Site Image #13





Site Image #5





Site Image #17

Site Image #14







Site Image #6






Site Image #12



Site Image #15



Site Image #18

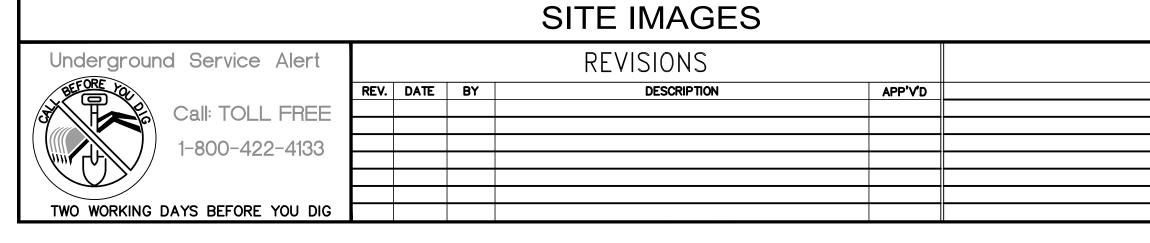













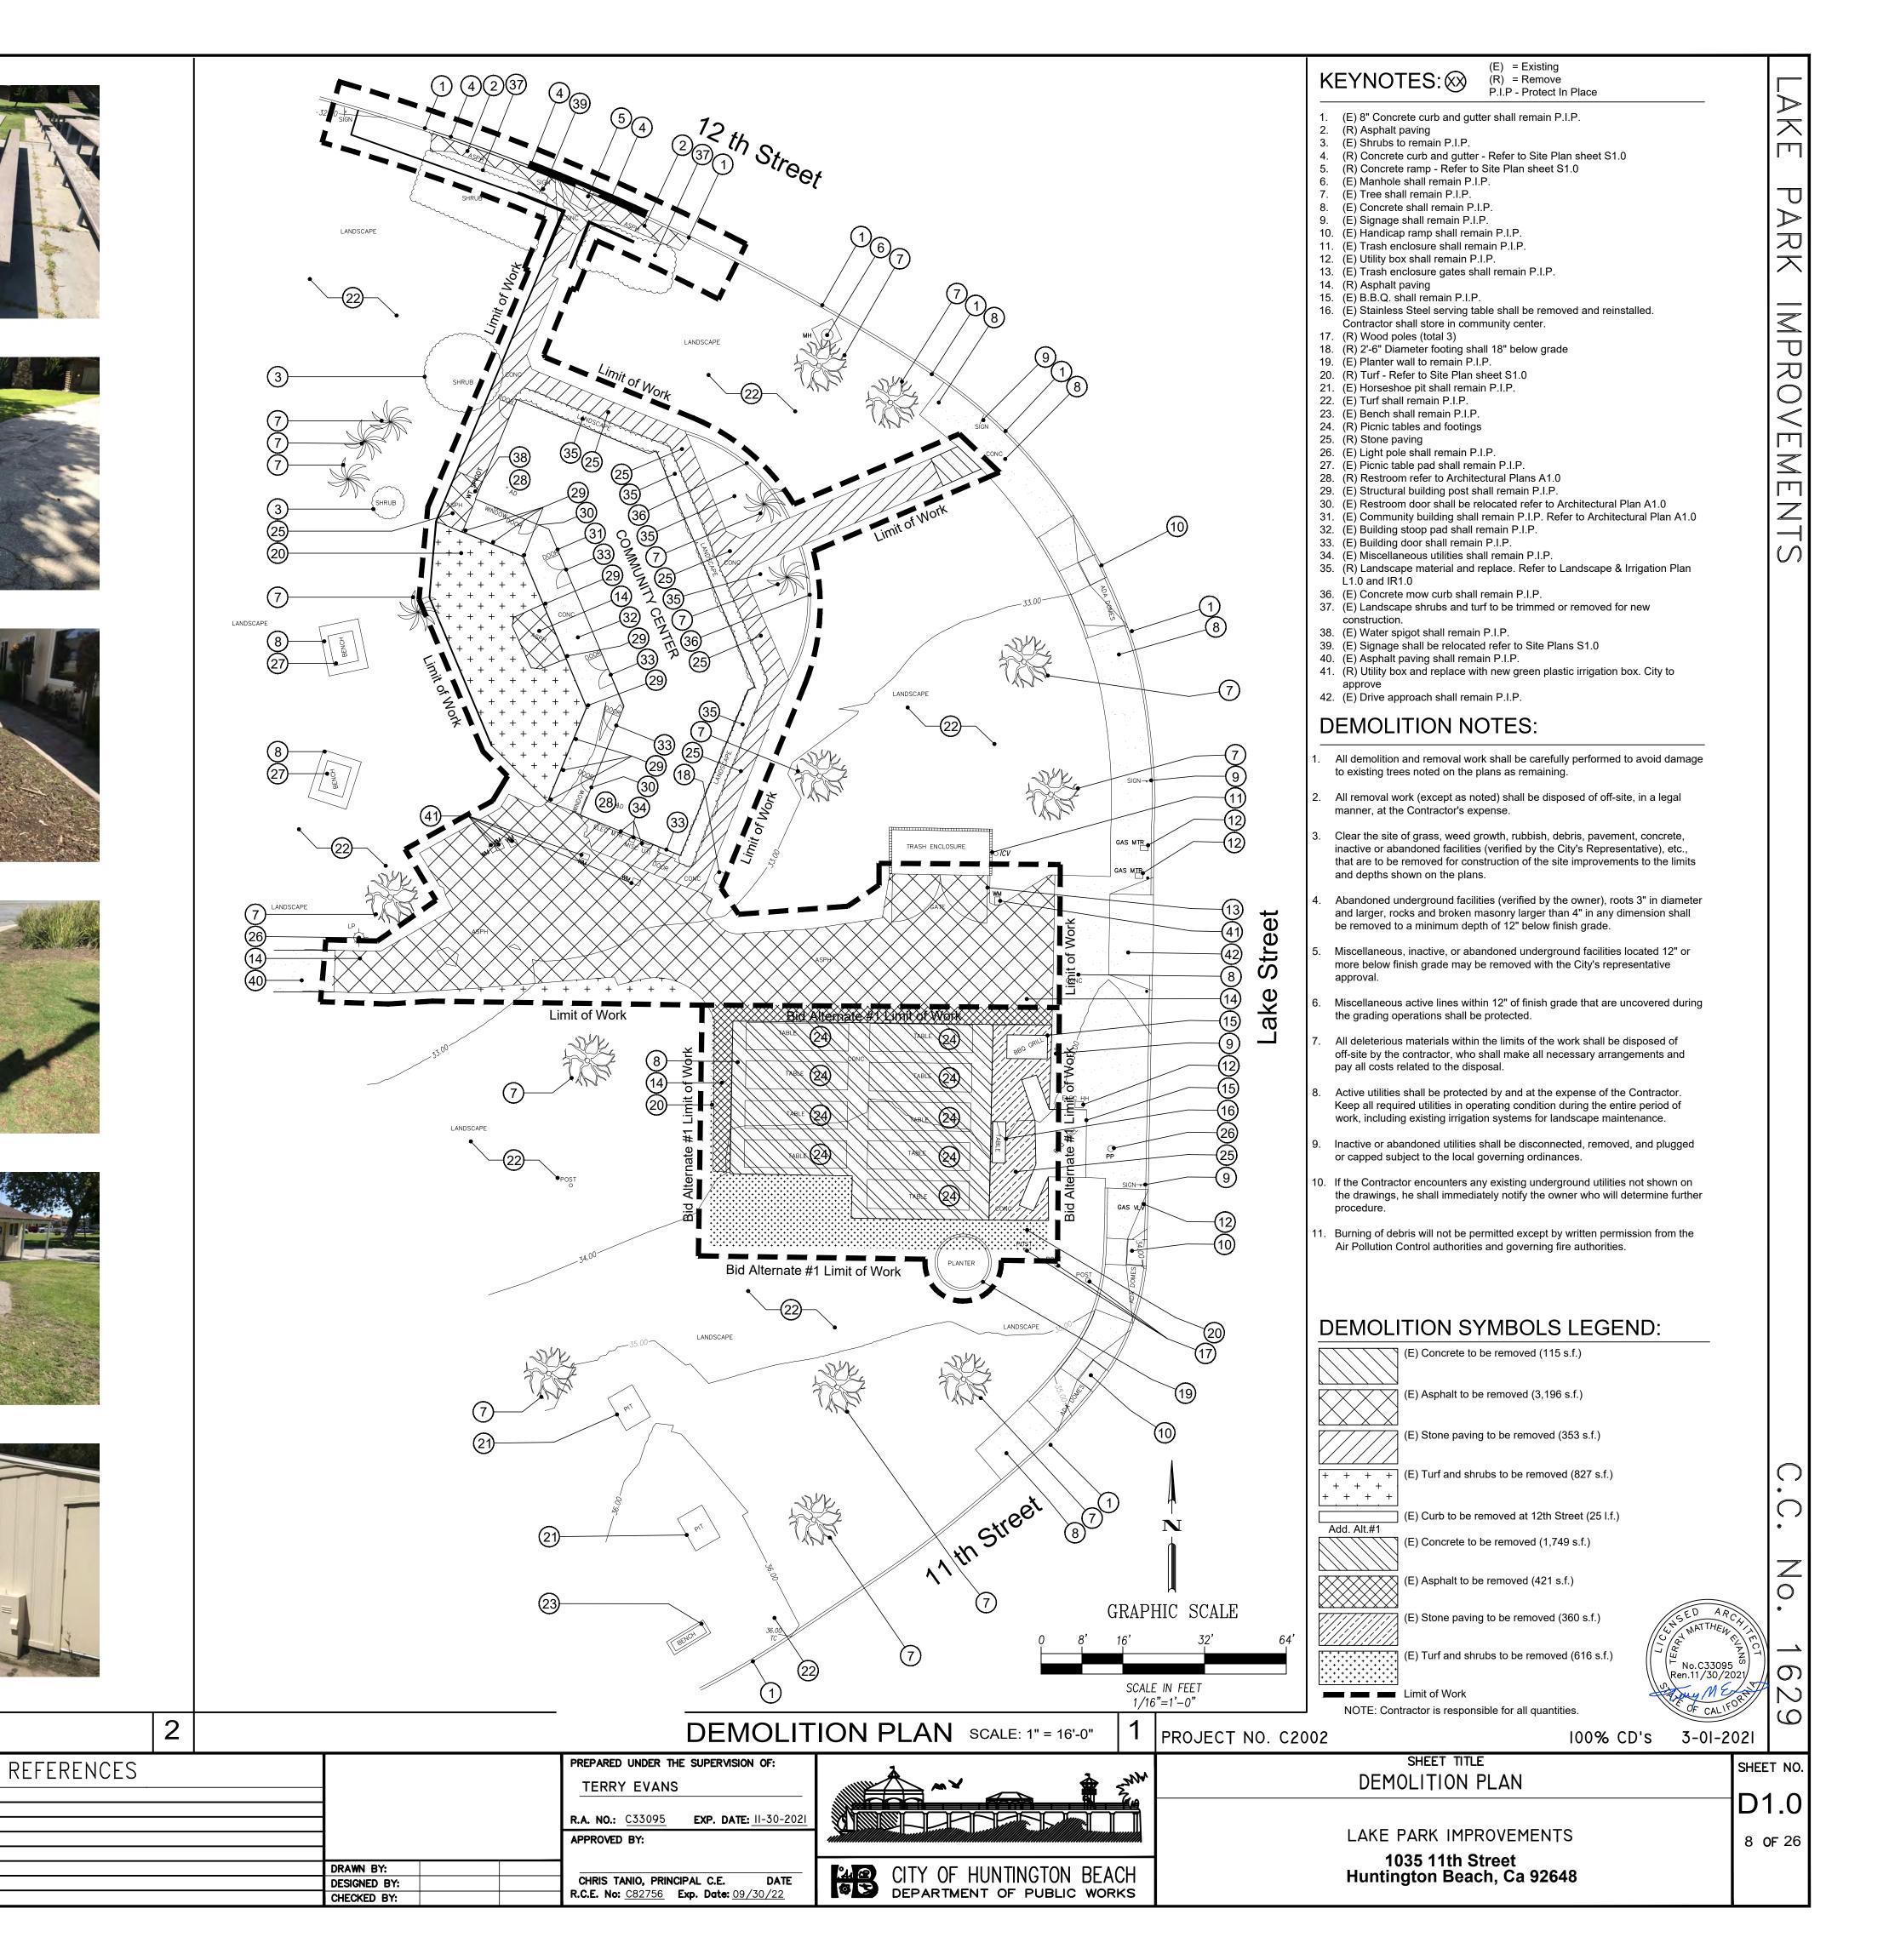


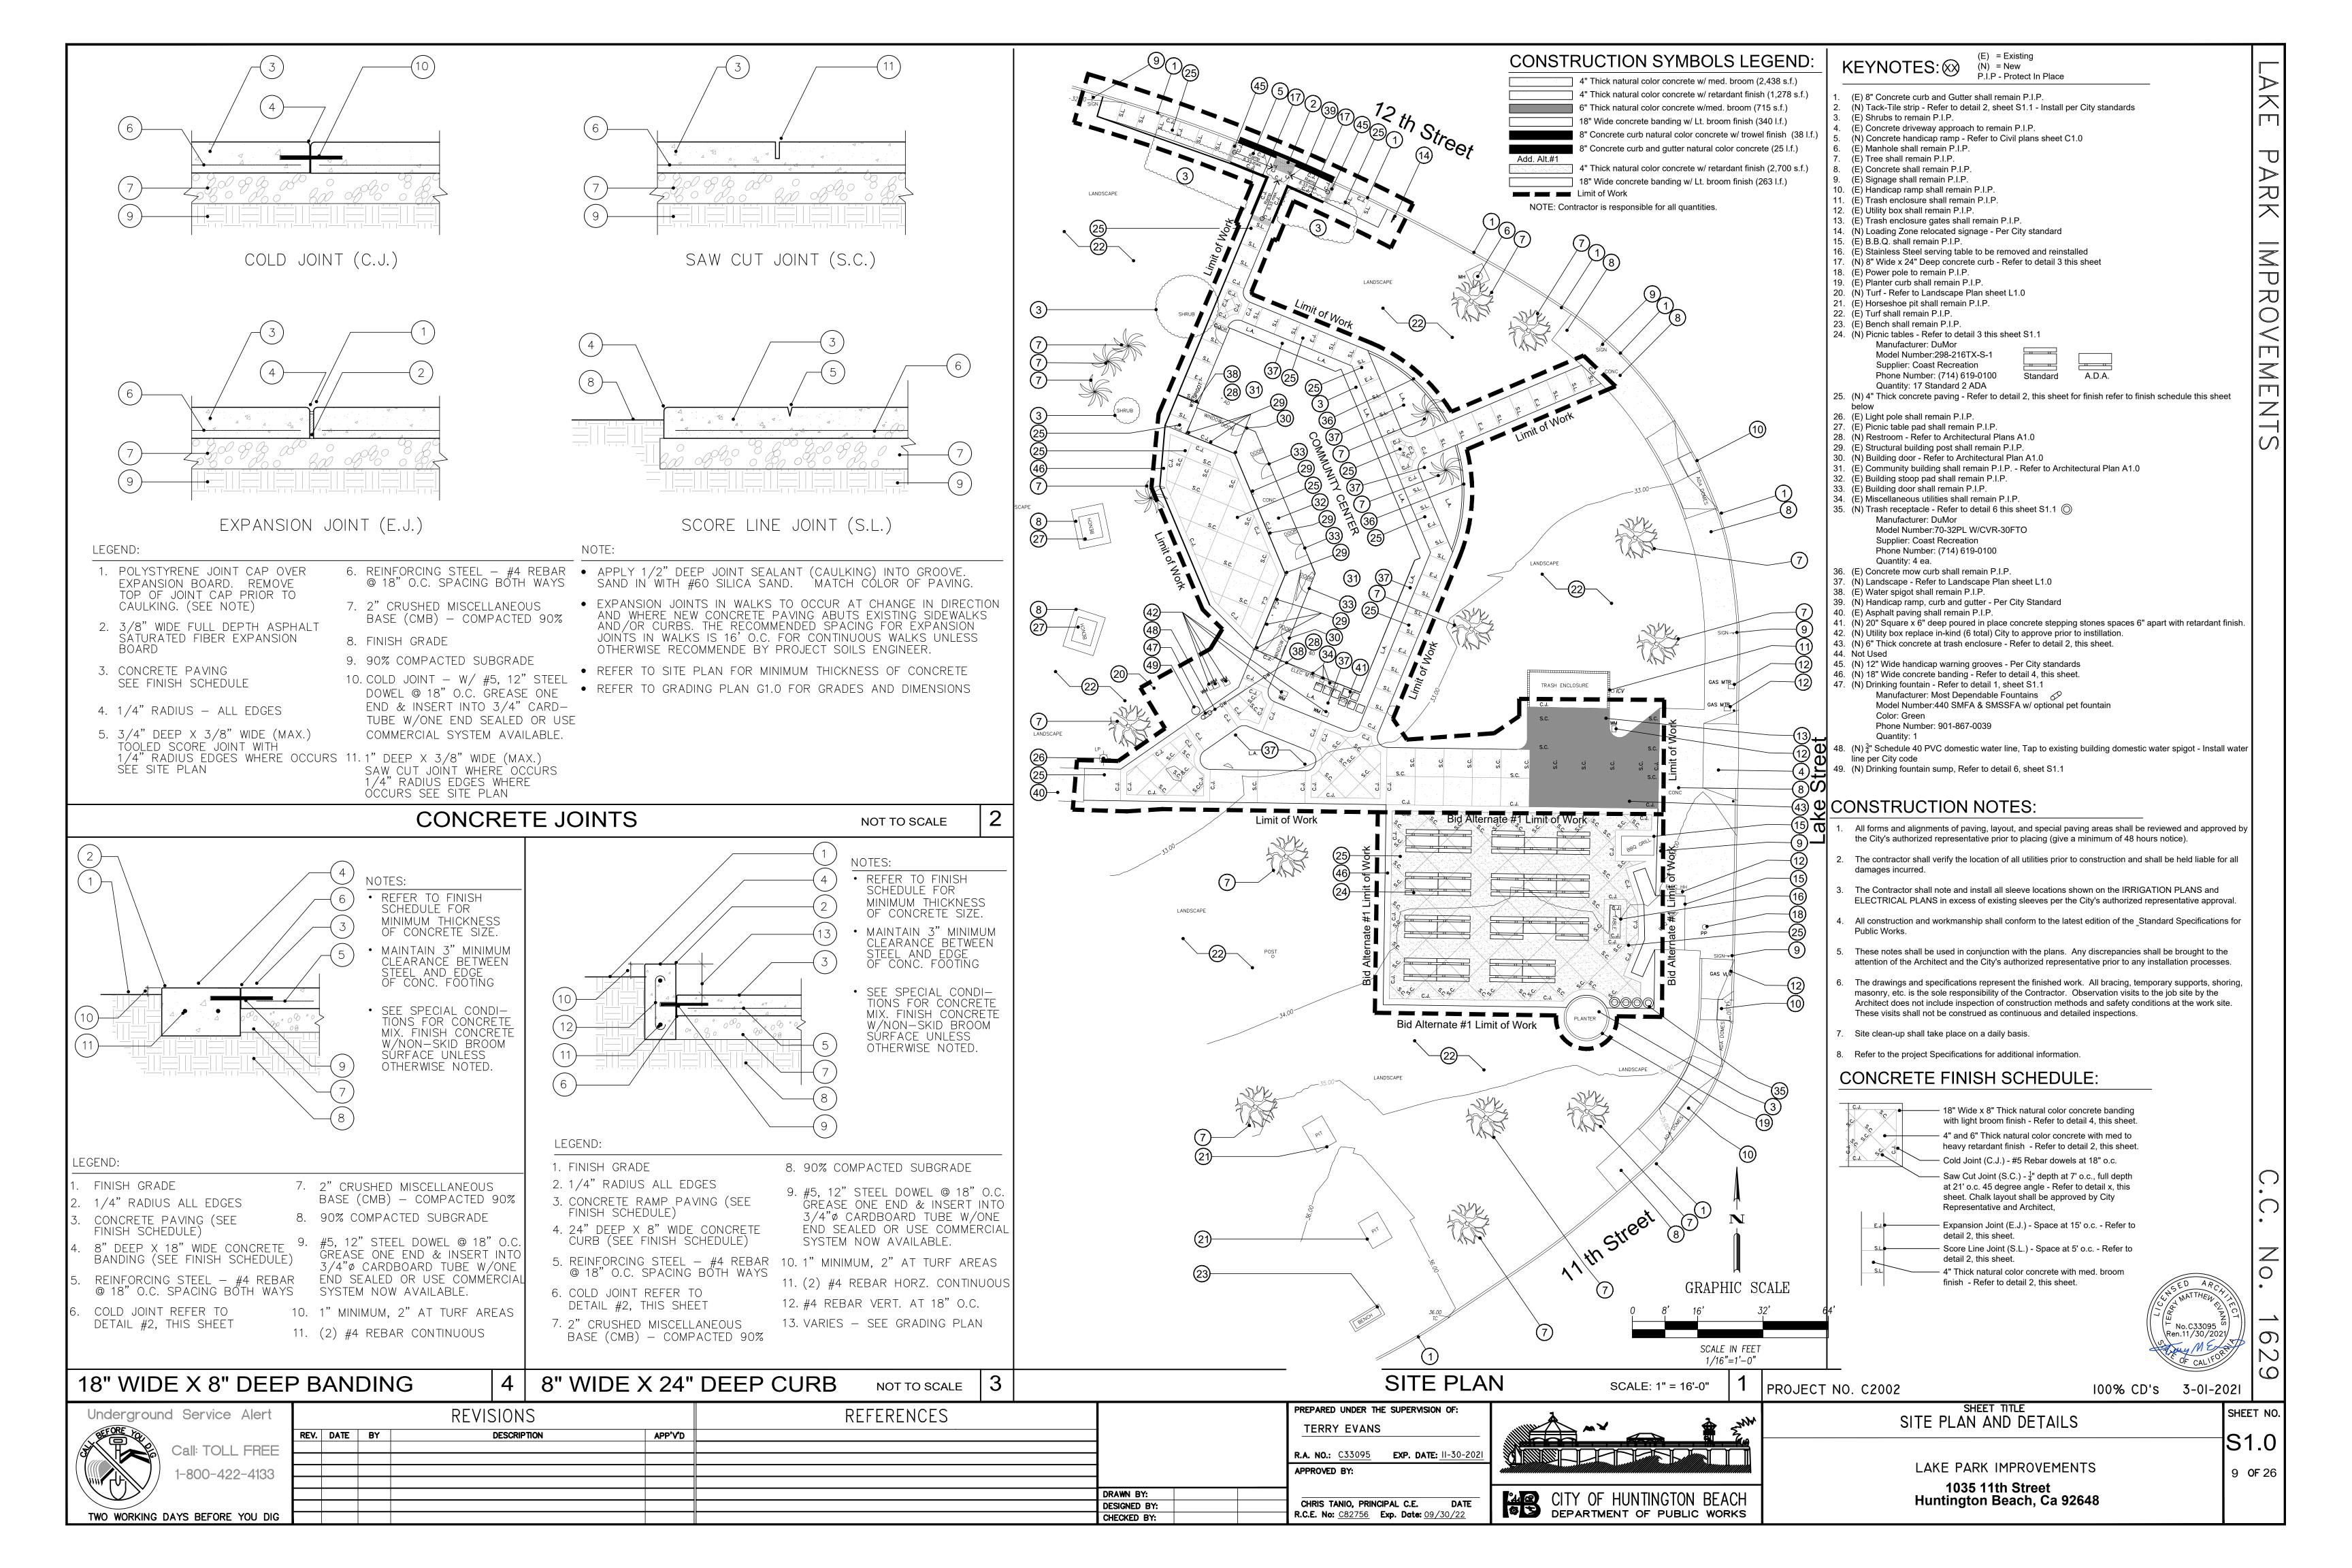


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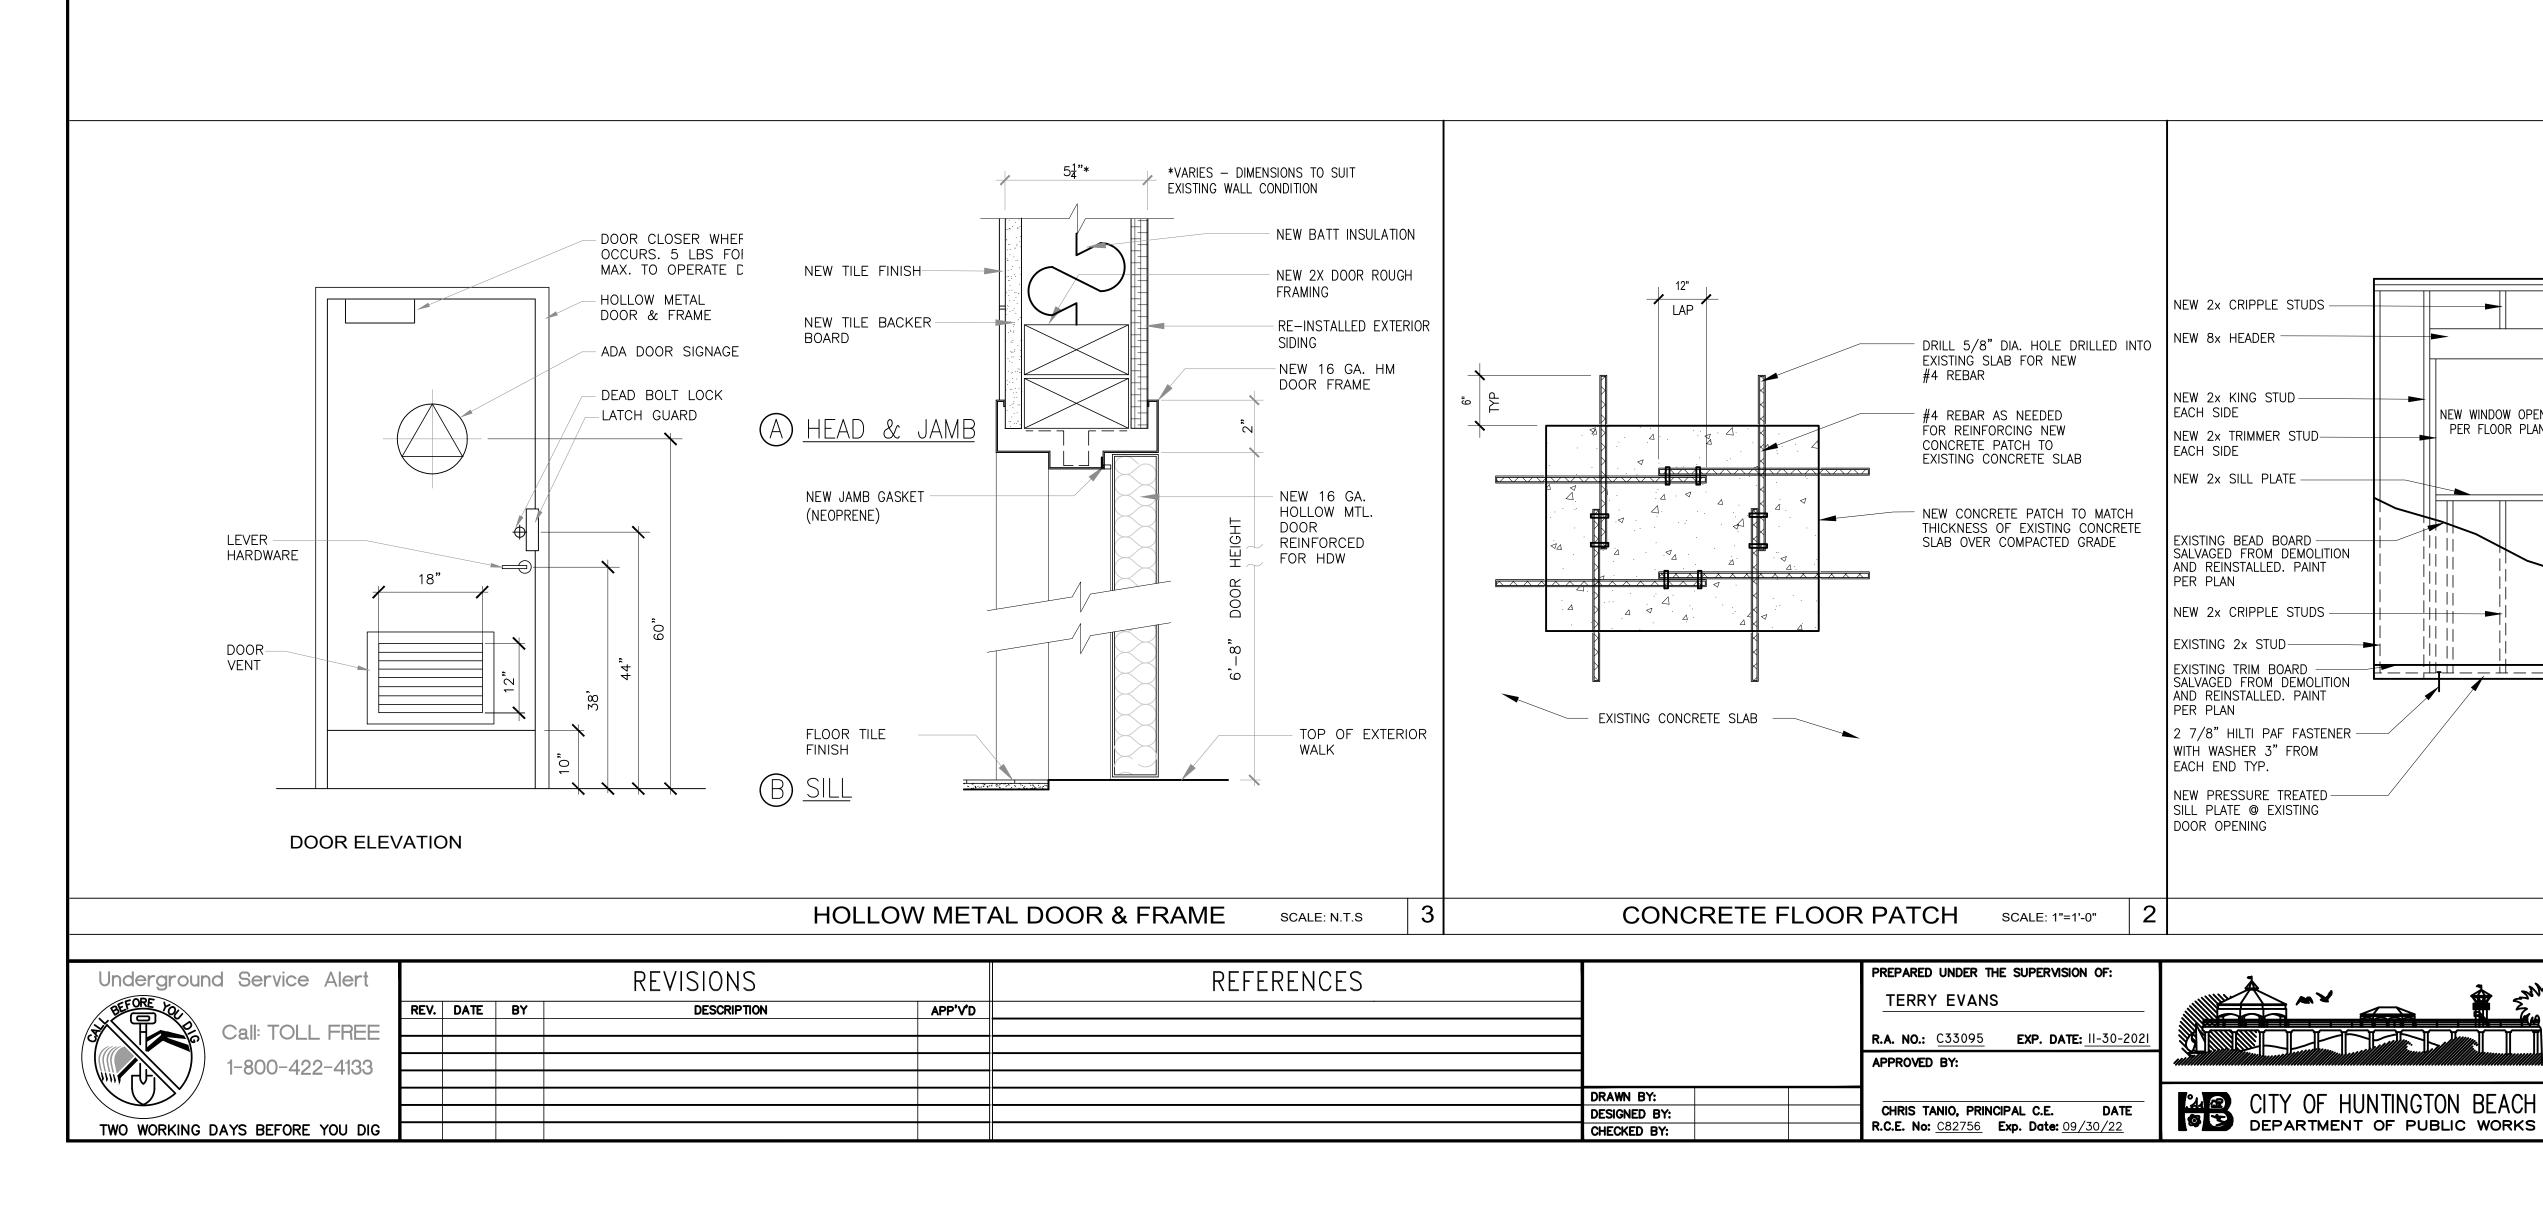


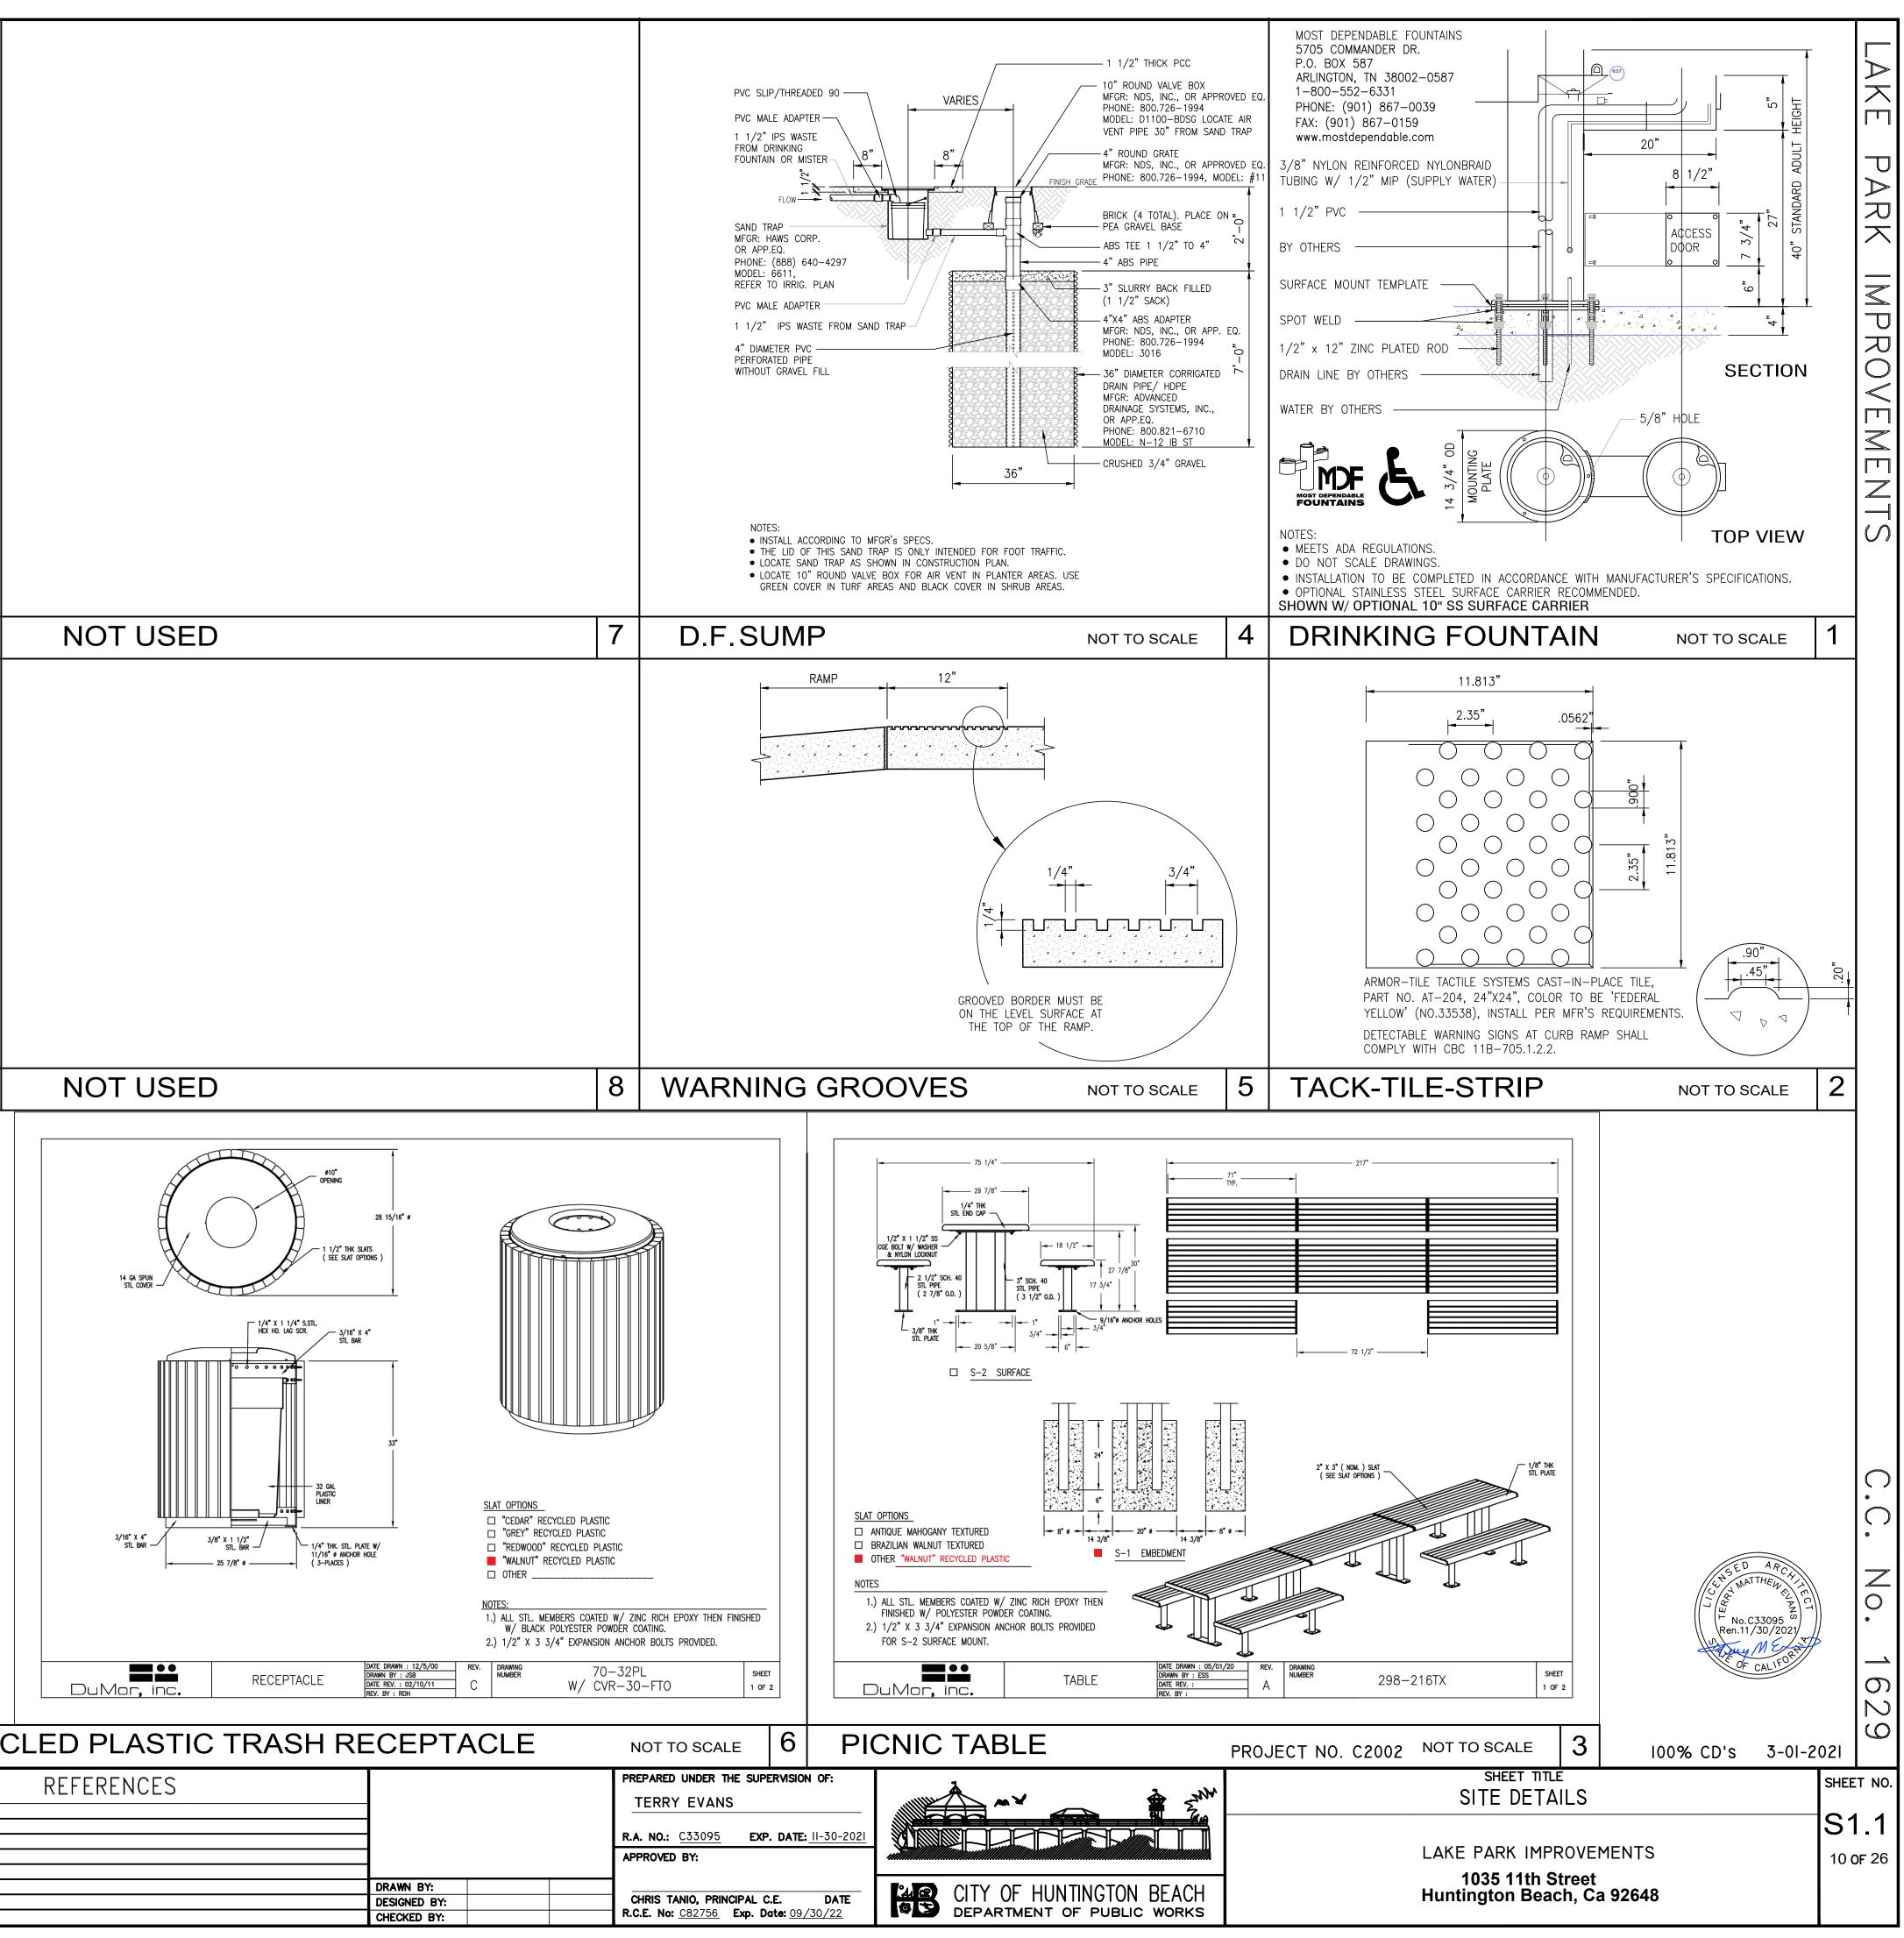


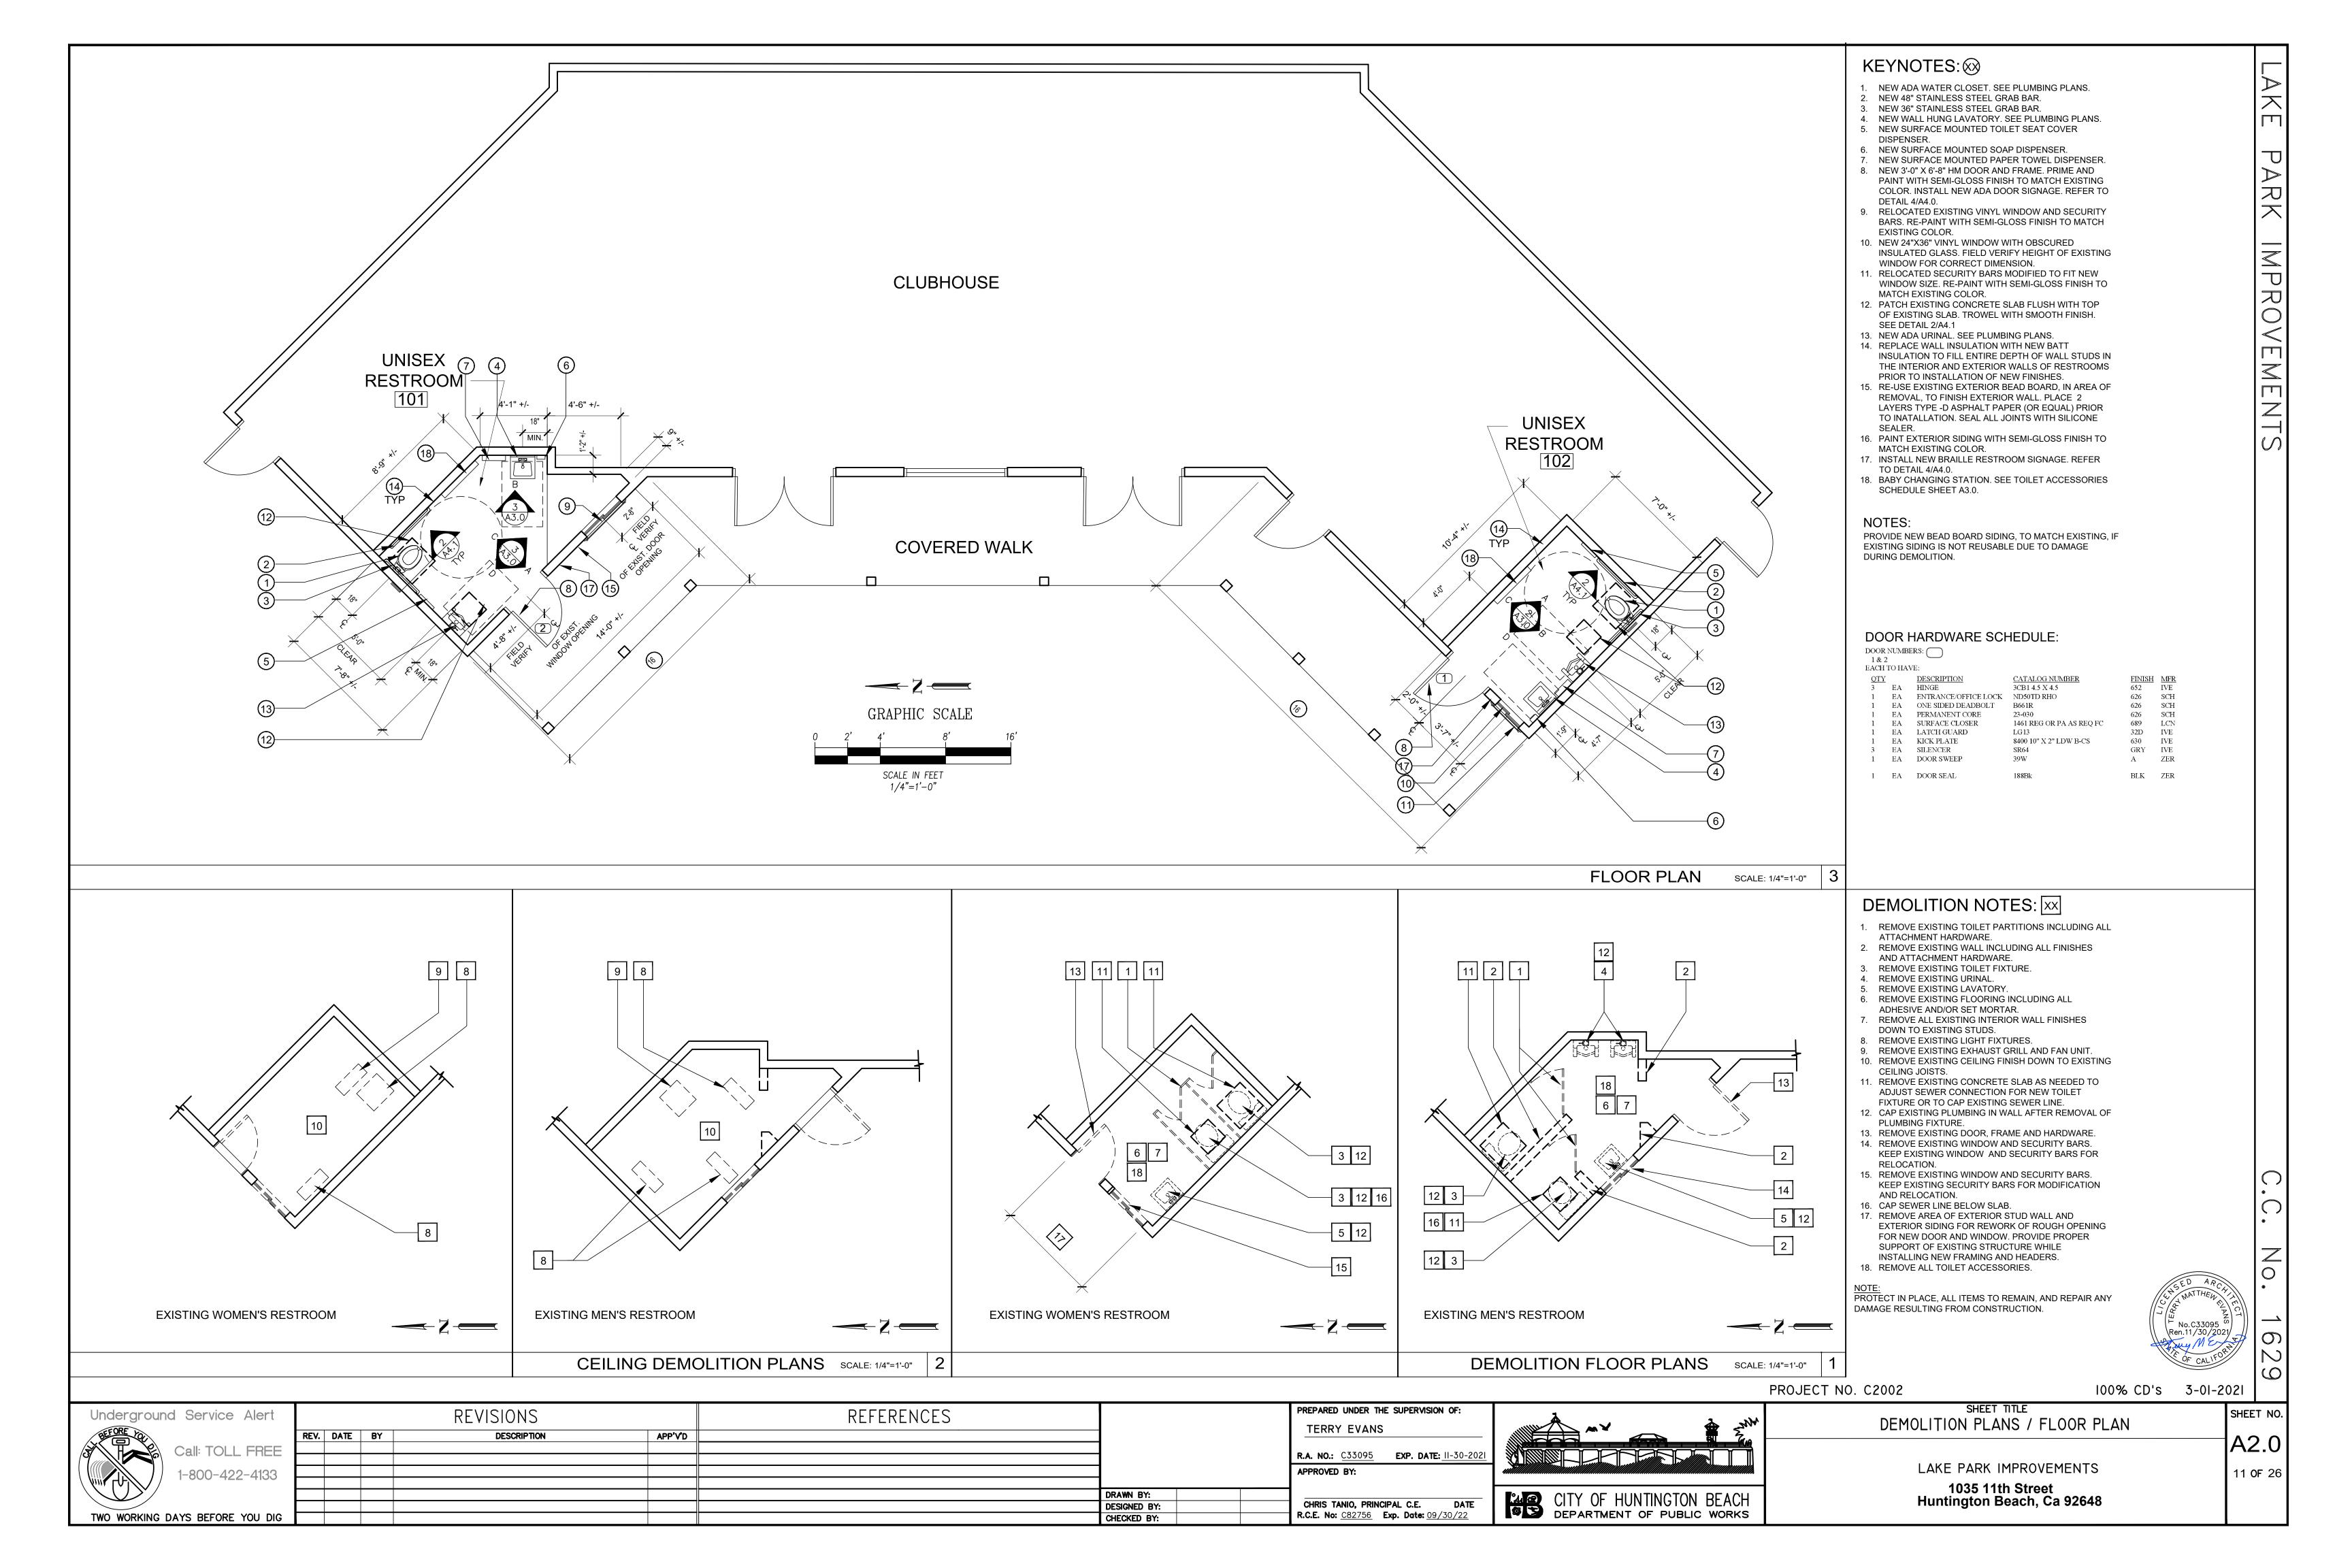
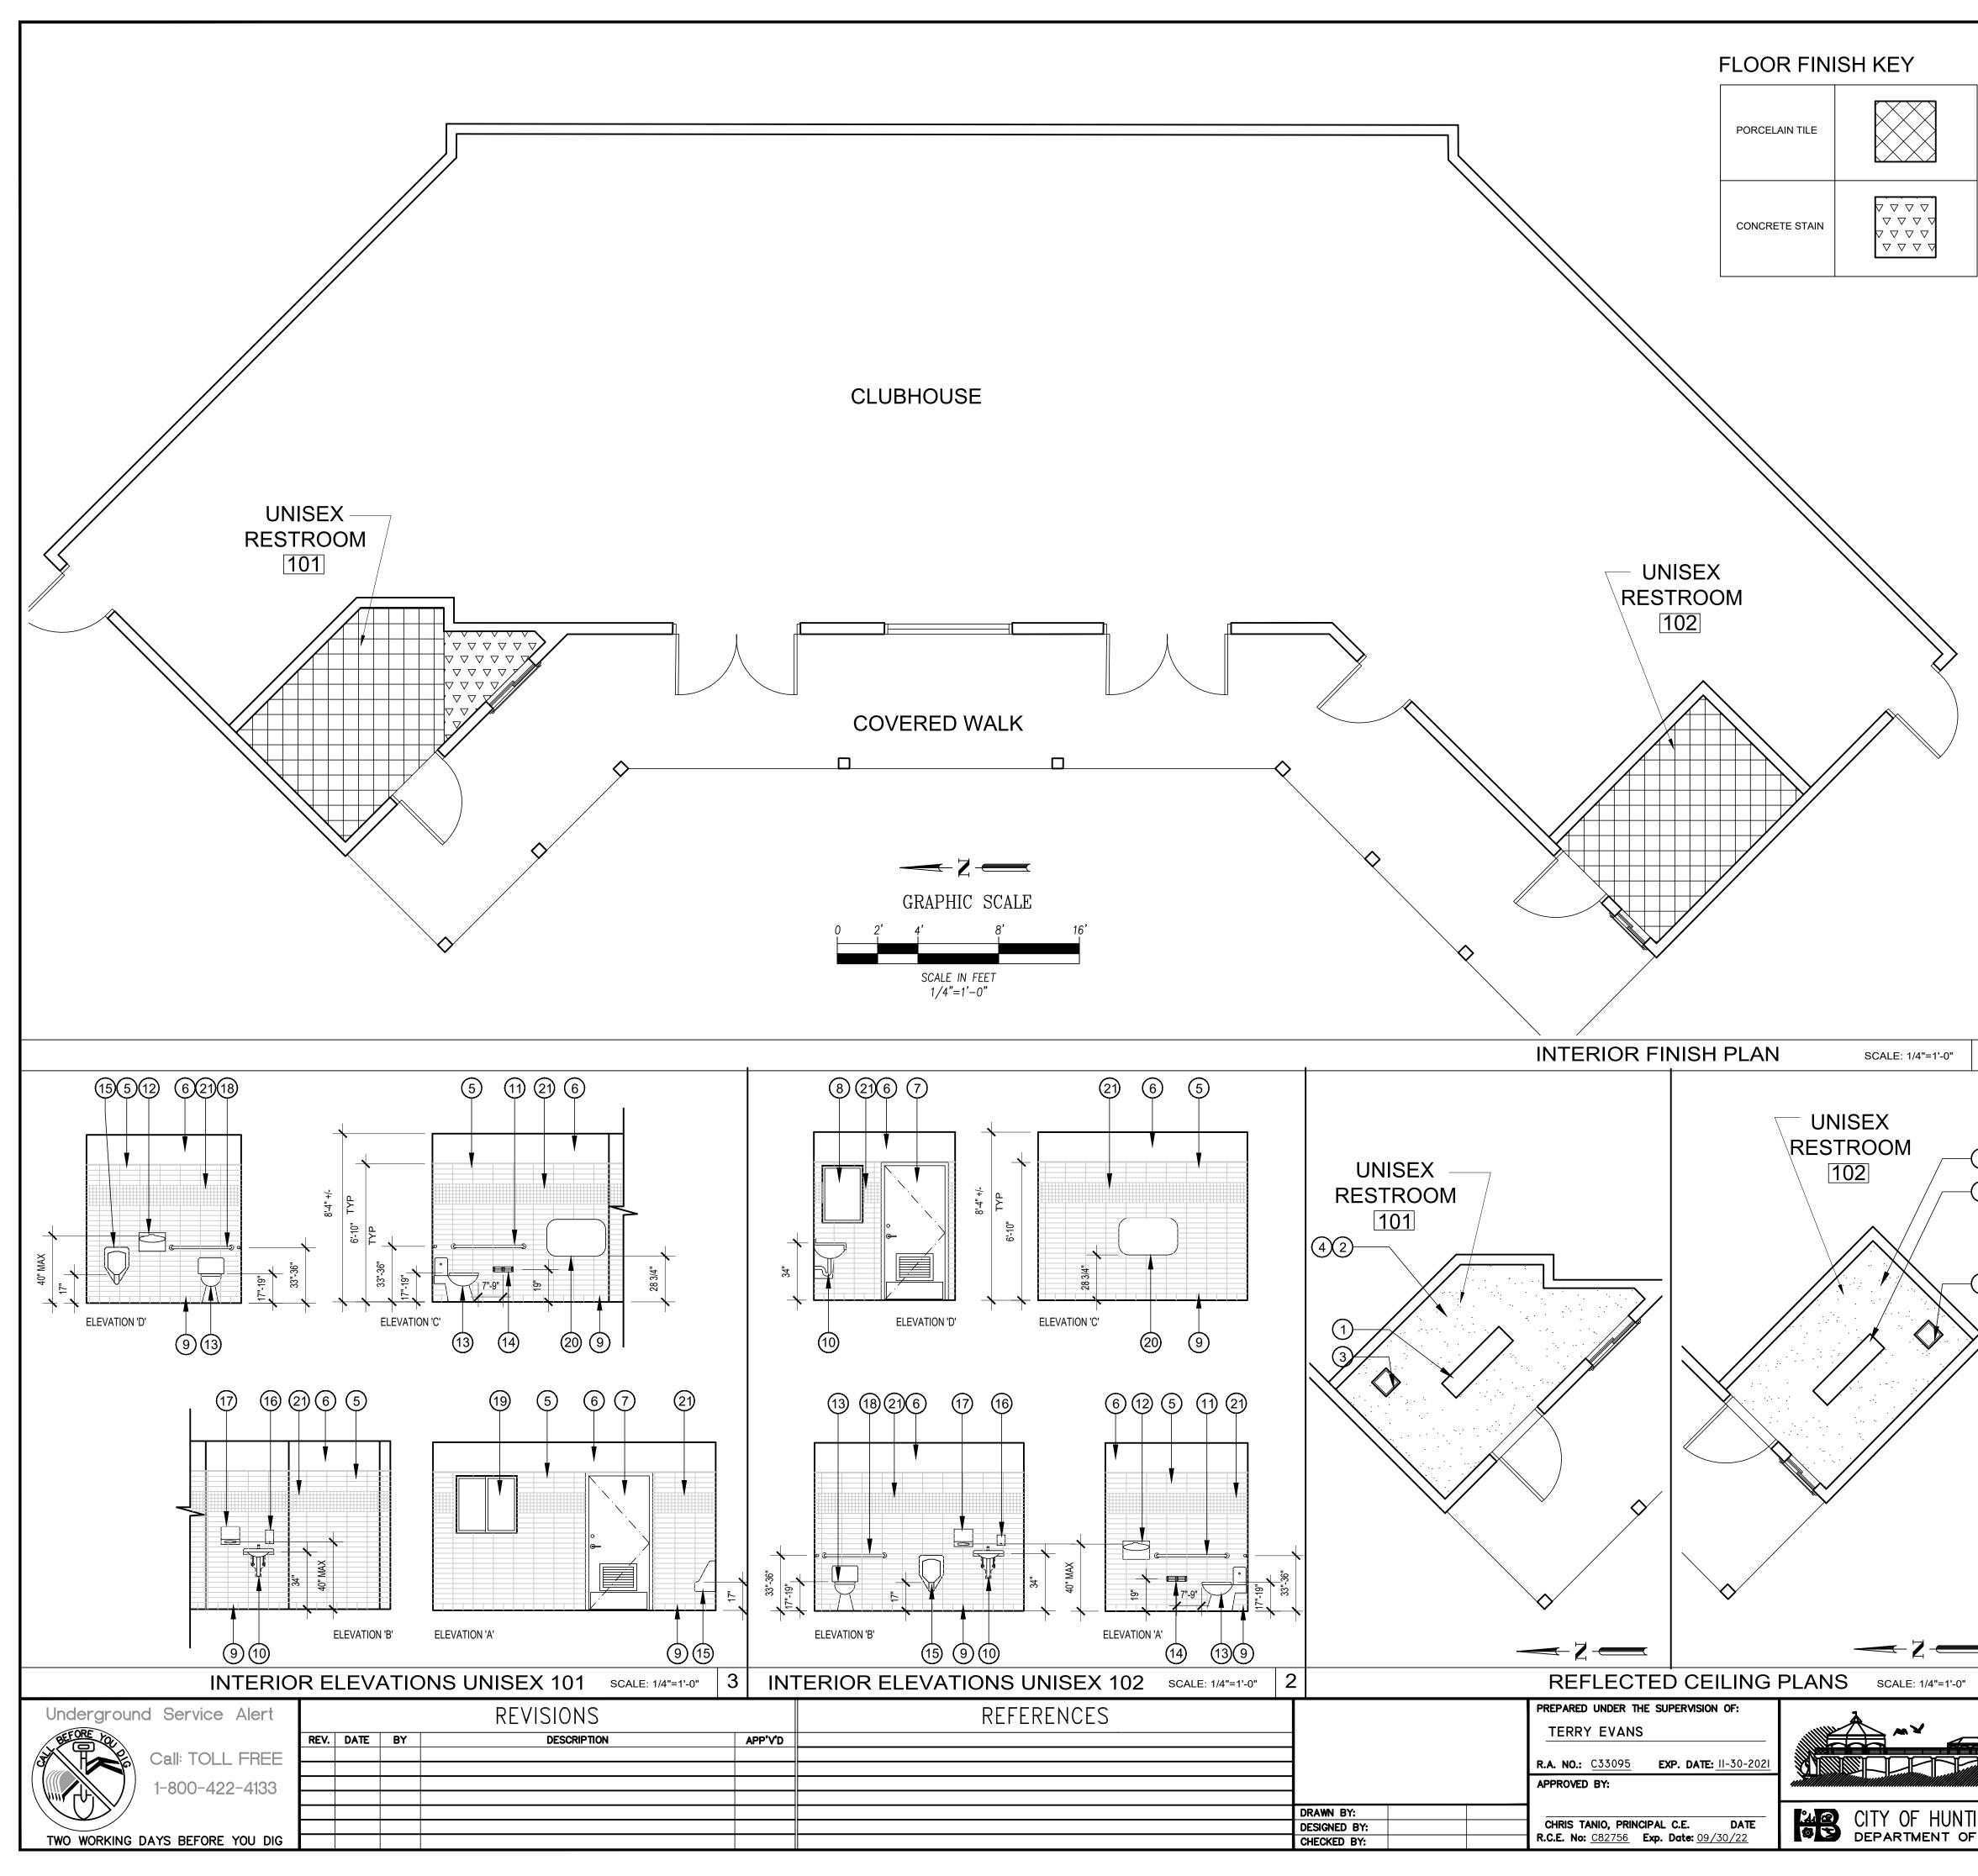
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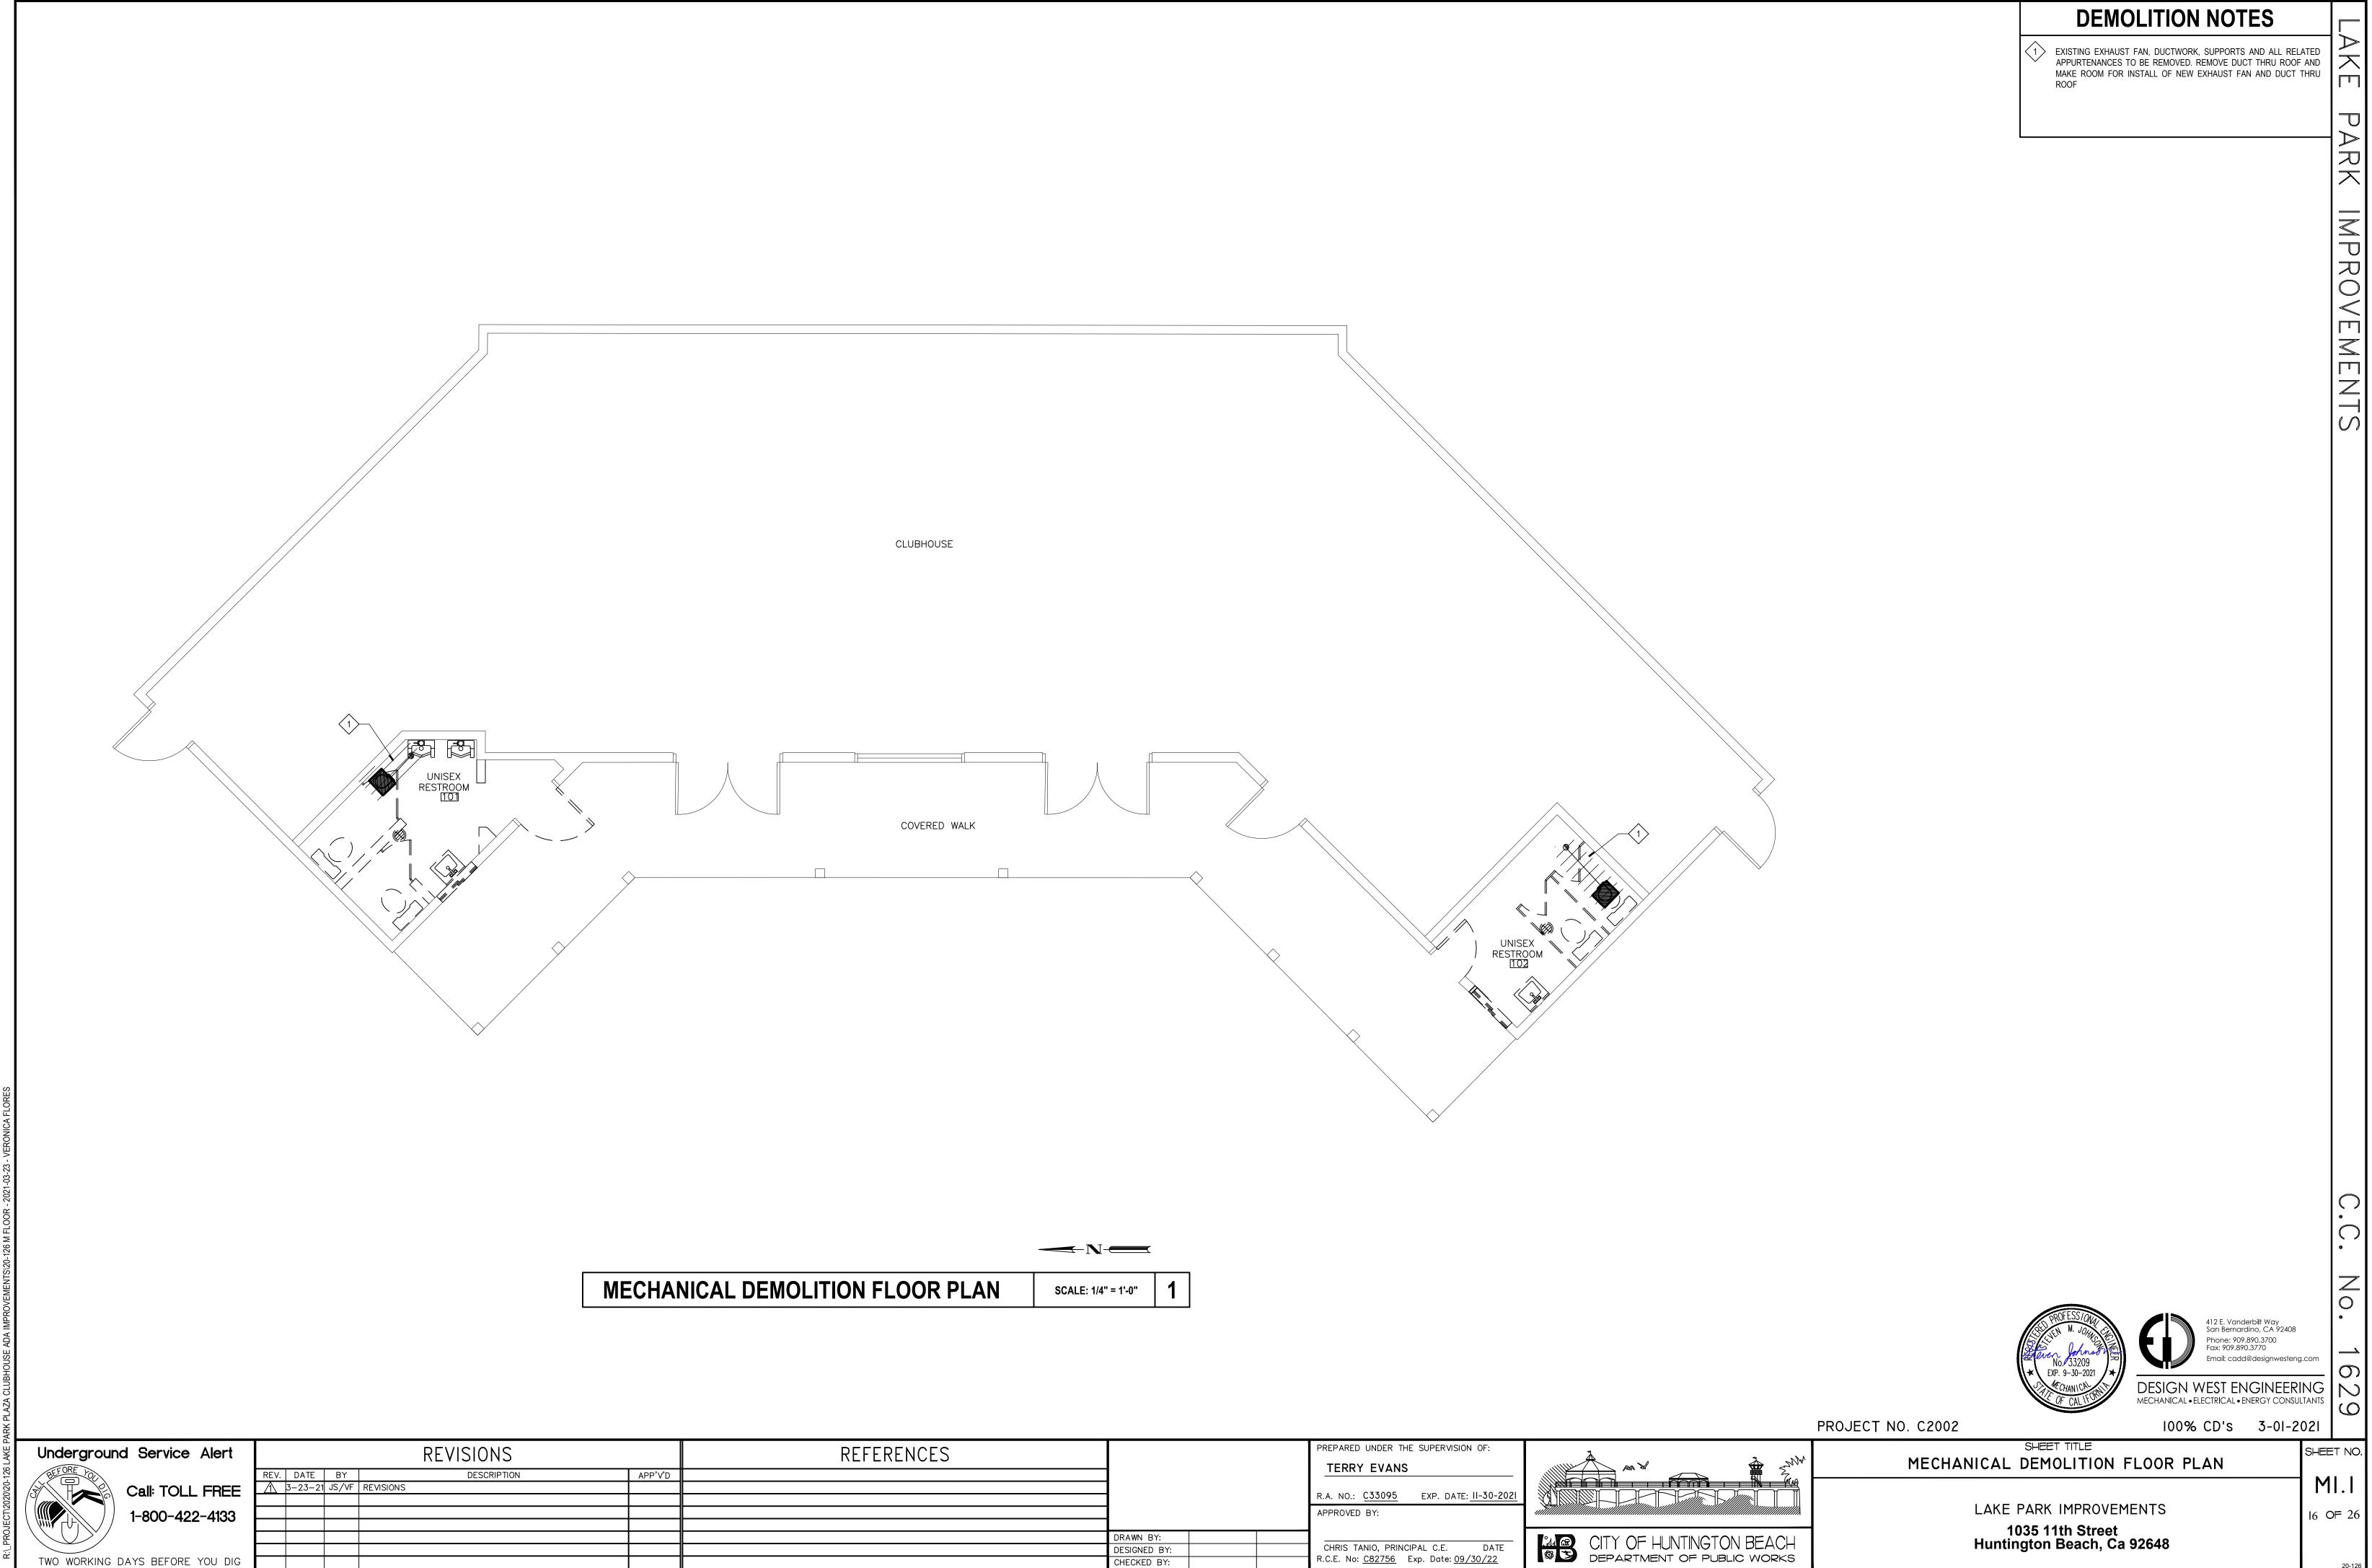




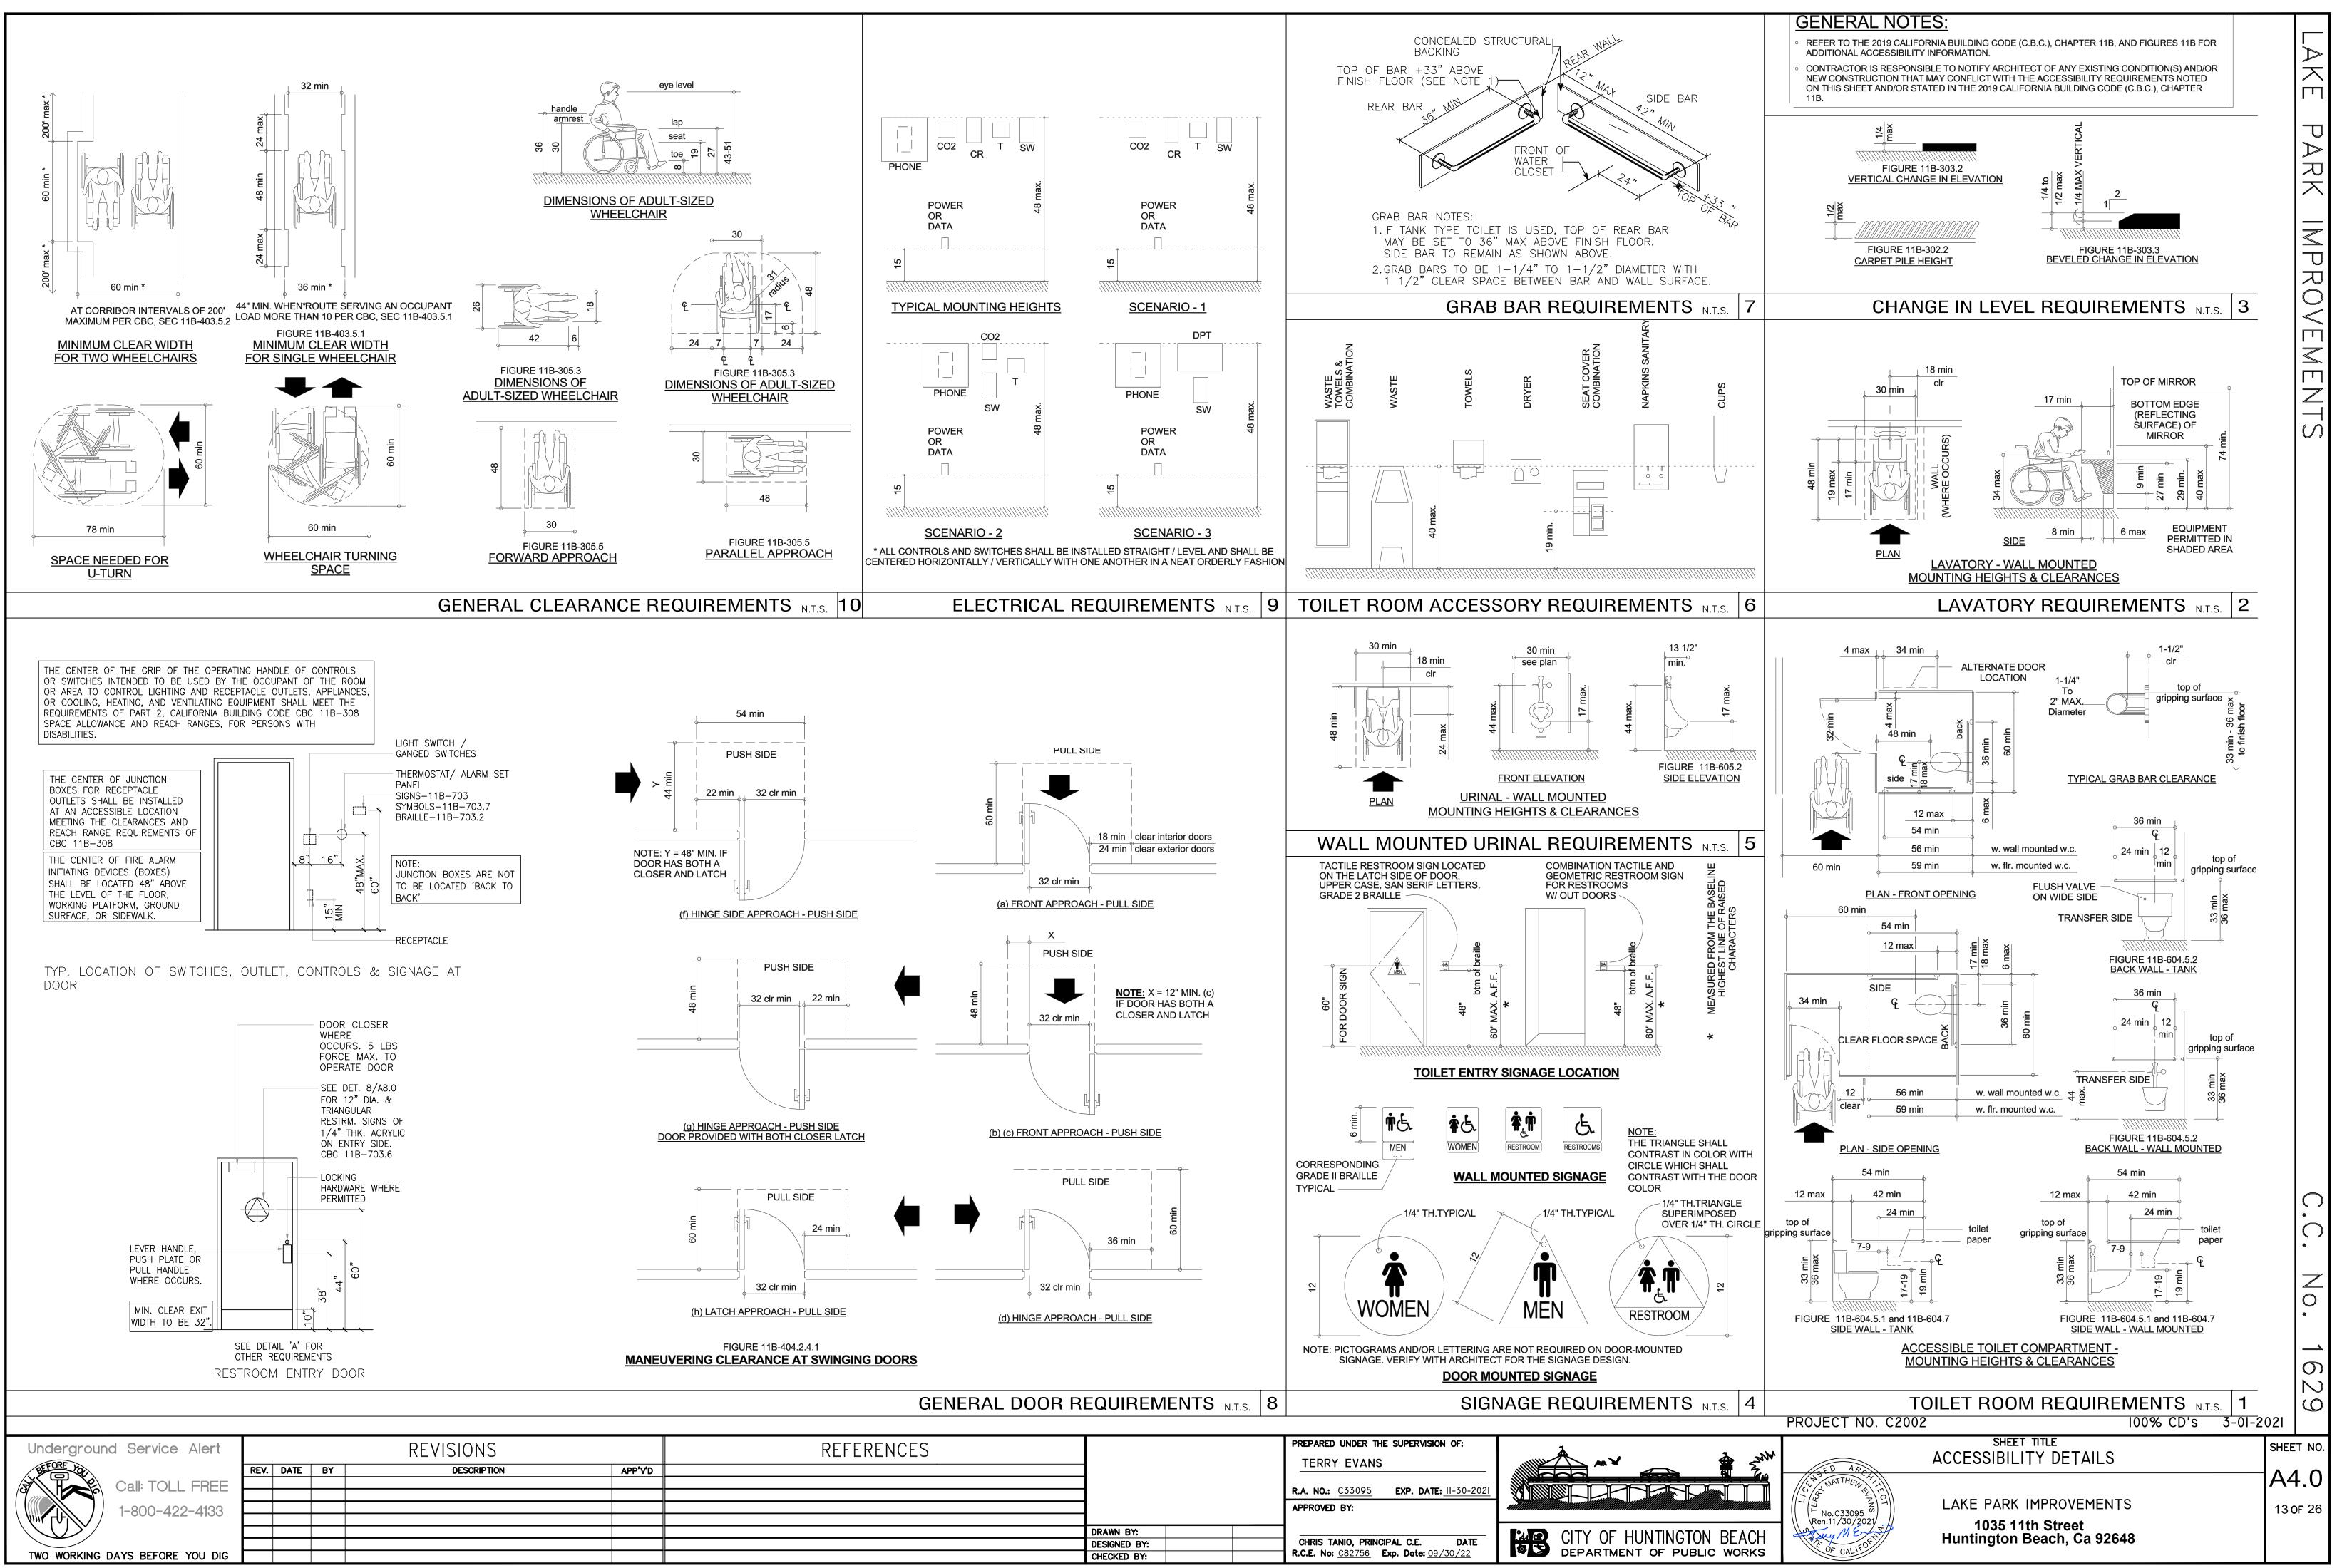


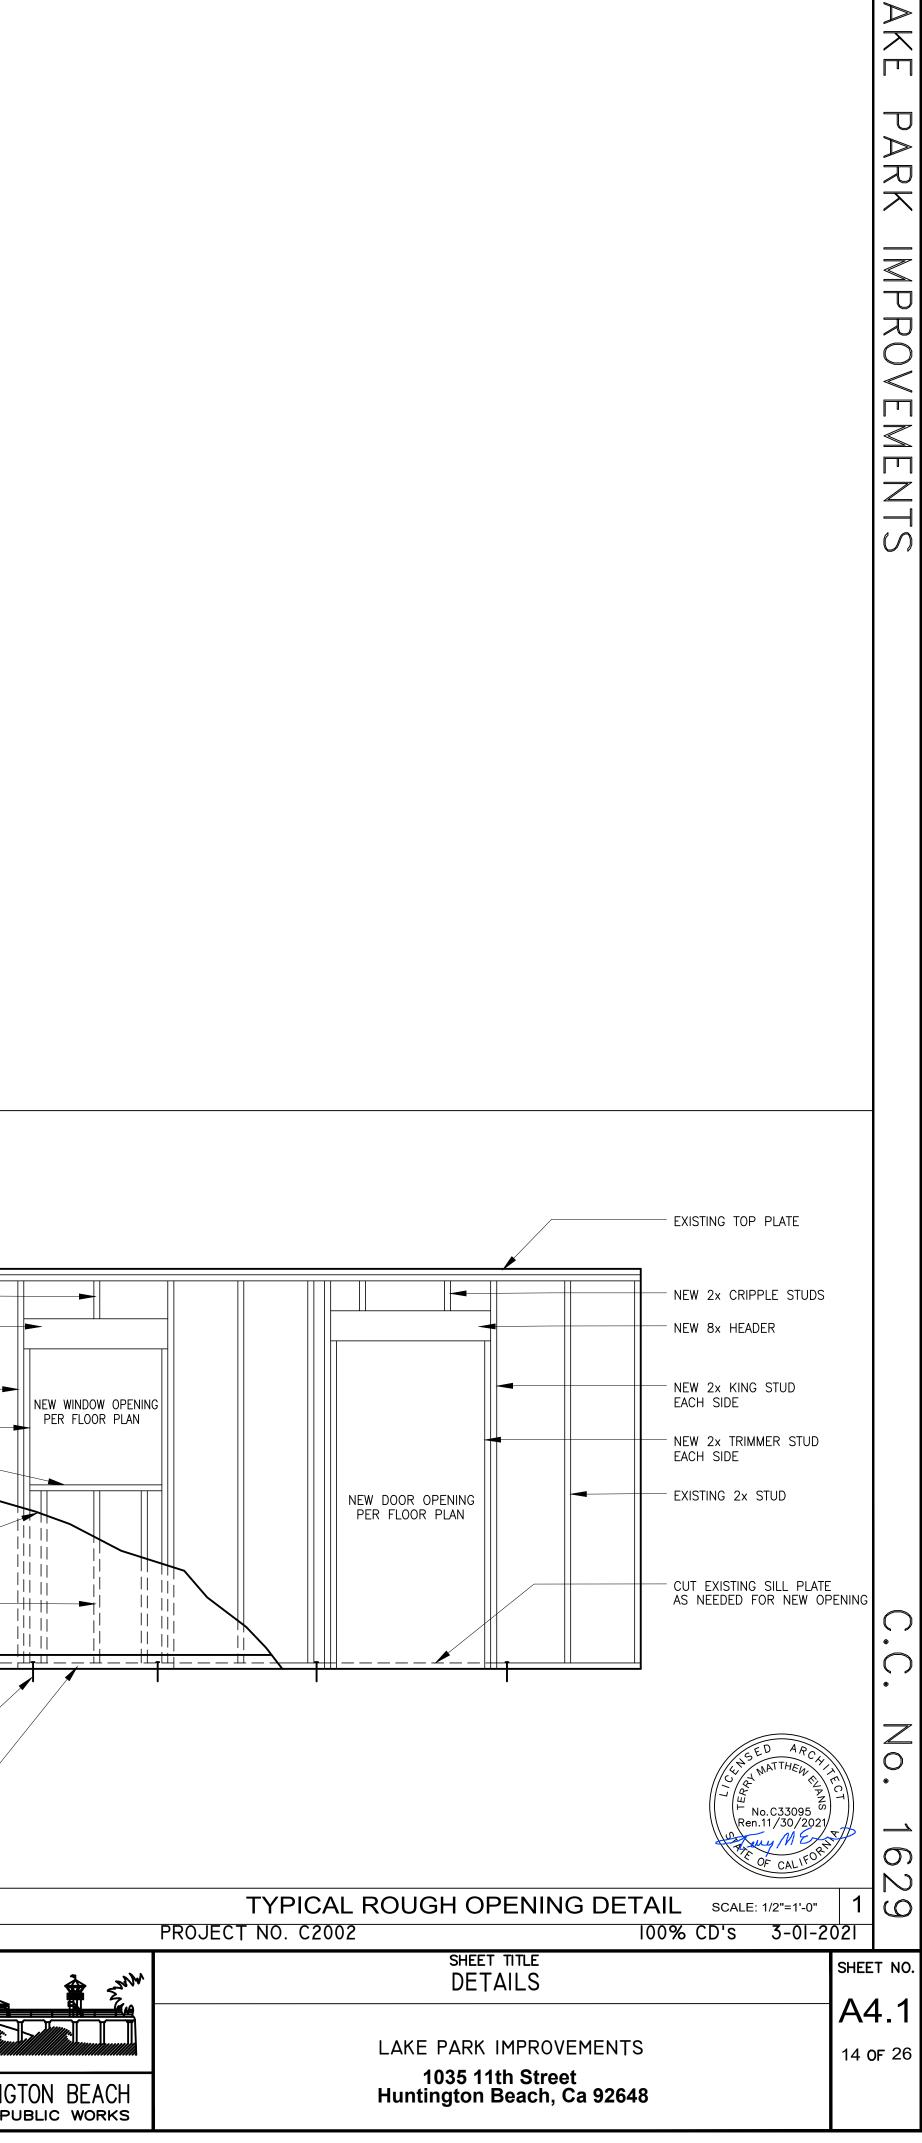	EXHAU	UST FAN SCHEDULE	HVAC LEGEND
	TAG MFR. & MODEL NO. AREA SERVED TYPE	FAN SYSTEM ELECTRICAL OPER.WT (LBS) REMARKS (SEE EQUIPMENT NOTES BELOW) EXHAUST CFM ESP POWER V-PH-HZ RPM OPER.WT (LBS) BELOW) 100 .25 48 WATTS 120-1Ø-60Hz 649 16 1 2 3 4 5 100 .25 48 WATTS 120-1Ø-60Hz 649 16 1 2 3 4 5 100 .25 48 WATTS 120-1Ø-60Hz 649 16 1 2 3 4 5	SYMBOL ABBREVIATIONS DESCRIPTION Image: Symbol
	A TO OPERATE ON TIME CLOCK (REFER TO ELECTRICAL DRAWINGS) SMACNA TABLE 3-S ROUND DUCT GAUGE UNREINFORCED POSITIVE PRESSURE TO 10 IN. WC. RECTANGULAR DUCT DUCT SIZE GAUGE 13" TO 16" 24 DD, SS NONE 13" TO 16" 24 19" TO 30" 24 DJ, SS NONE 13" TO 16" 24 19" TO 30" 24 DJ, SS NONE 13" TO 16" 22 1"PS OR BS 1x1x1-10 43" TO 54" 22 10" TO 14" 28 10" TO 24" 24 10" TO 14" 28 10" TO 14" 28 10" TO 14" 28 10" TO 14" 28 10" TO 24" 24 10" TO 24" 24	120V-10-60HZ Image: clock, set To operate DURING occurred Hours Isc. sw. Image: clock for the clock for	Image: Construction of the state state of the state of the state of the state
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	DUCT THRU ROOF 4	ROUND DUCT SUPPORT 1	PROJECT NO. C2002 Image: Construction of the construction of
Underground Service Alert REVISIONS Image: Call: TOLL FREE BY Description APP'V'D Image: Labor Alext Image: Labor Alext Image: Labor Alext Image: Labor Alext APP'V'D Image: Labor Alext Image: Labor Alext Image: Labor Alext Image: Labor Alext APP'V'D Image: Labor Alext Image: Labor Alext Image: Labor Alext Image: Labor Alext APP'V'D Image: Labor Alext Image: Labor Alext Image: Labor Alext Image: Labor Alext APP'V'D Image: Labor Alext Image: Labor Alext Image: Labor Alext Image: Labor Alext APP'V'D Image: Labor Alext Image: Labor Alext REFERENCES II BRAWN BY: R.A. DESIGNED BY: CHI	EPARED UNDER THE SUPERVISION OF: TERRY EVANS A. NO.: C33095 EXP. DATE: II-30-2021 PROVED BY: HRIS TANIO, PRINCIPAL C.E. DATE DATE: C82756 Exp. Date: 09/30/22	SHEET TITLE SHEET MECHANICAL LEGEND, NOTES, DETAILS & SCHEDULE MO LAKE PARK IMPROVEMENTS 15 OF 1035 11th Street Huntington Beach, Ca 92648

					EXHA	UST FAN	SCH	EDULE		
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	EF 1	COOK GEMINI GC-186	UNISEX RESTROOM 10)1 (EILING	100	.25	48 WATTS	120-1Ø-60Hz	649
	EF 2	COOK GEMINI GC-186	UNISEX RESTROOM 10)2 (EILING	100	.25	48 WATTS	120-1Ø-60Hz	649
		WHITE STEEL GRILLE (2)	WITH FAN SPEED CONTRO			I IMPS) (3) INTEGF	I RAL BACK DR	I AFT DAMPER		
SMACNA TABLE 3-5 ROUND DUCT	GAUGE UNREINFORCED POSITI	VE PRESSURE TO 10 IN. WC.							120V-1Ø-60HZ	
RECTANGULAR		DUCT							↑ ↑ 	
DUCT SIZE	GAUGE T	RANSVERSE JOINT	BRACING							
UP TO 12"	26	DD, SS	NONE							
13" TO 18"	24	DD, SS	NONE							
19" TO 30"	24	DD, SS	NONE				TO	E CLOCK, SET OPERATE		(1
31" TO 42"	22	1" PS OR BS	1x1x1-1/8				DUF HOL	RING OCCUPIED		
43" TO 54"	22 1-1	1/2" STANDING SEAM	1.5x1.5							
ROUND								DISC. SW		
DUCT SIZE UP TO 9"	GAUGE T	RANSVERSE JOINT 2" SLIP	BRACING						_ '	C
10" TO 14"	28	4" SLIP	NONE							
14" TO 18"	26	4" SLIP	NONE							1
18" TO 24"	24	4" SLIP	1x1x1-1/8						(M)	/
				2					ECHANICAL CONTR	ACTOR
	DUCT	GAUGE SC	HEDULE	3		E	KHAU	JST FAI		NGD
22 GA. G.I. COUNTER FLASHING. #10 S.M.S. @ 6" O.C. MAX. CAULK & SEAL WATERTIGHT 22 GA. G.I. FLASHING. (TYP.) ROOFING UP ALL SIDES BY ROOF CONTR. CANT STRIP BY ROOF CONTR.		FOF	CT. SEE PLANS SIZE AND CATION. - CAULK & SEAL WATERTIGHT. 4" MIN. TO TOP OF NAILER. ROOF ROOF PROVIDE ADDITIONAL BLOCKING			FOR CONNECTION STRUCTURE - REF TO 2006 SMACNA GUIDELINES HANGER STRAP - SEE SCHEDULE BELOW 3/8"ø MACHINE - BOLT DUCT STRAP	ER MACNA HVAC FAL E 20" y" E I0" y"	HANGER SIZE 1" x 22 GA. 1" x 20 GA. HANGER SIZE 2" x 18 GA. 2" x 16 GA. 1/8" STEEL X 1-1/.	HANGER STRAP MAX. 5 10' 10' MAX. 5 12' 12'	
		יי יד די ווח		A					ייים חוי	
		DUCT THE		4				KUUI	ND DU	012




REFERENCES		PREPARED UNDER THE SUPERVISION OF: TERRY EVANS R.A. NO.: C33095 EXP. DATE: II-30-2021 APPROVED BY:	
	DRAWN BY: DESIGNED BY: CHECKED BY:	CHRIS TANIO, PRINCIPAL C.E. DATE R.C.E. No: <u>C82756</u> Exp. Date: <u>09/30/22</u>	CITY OF H

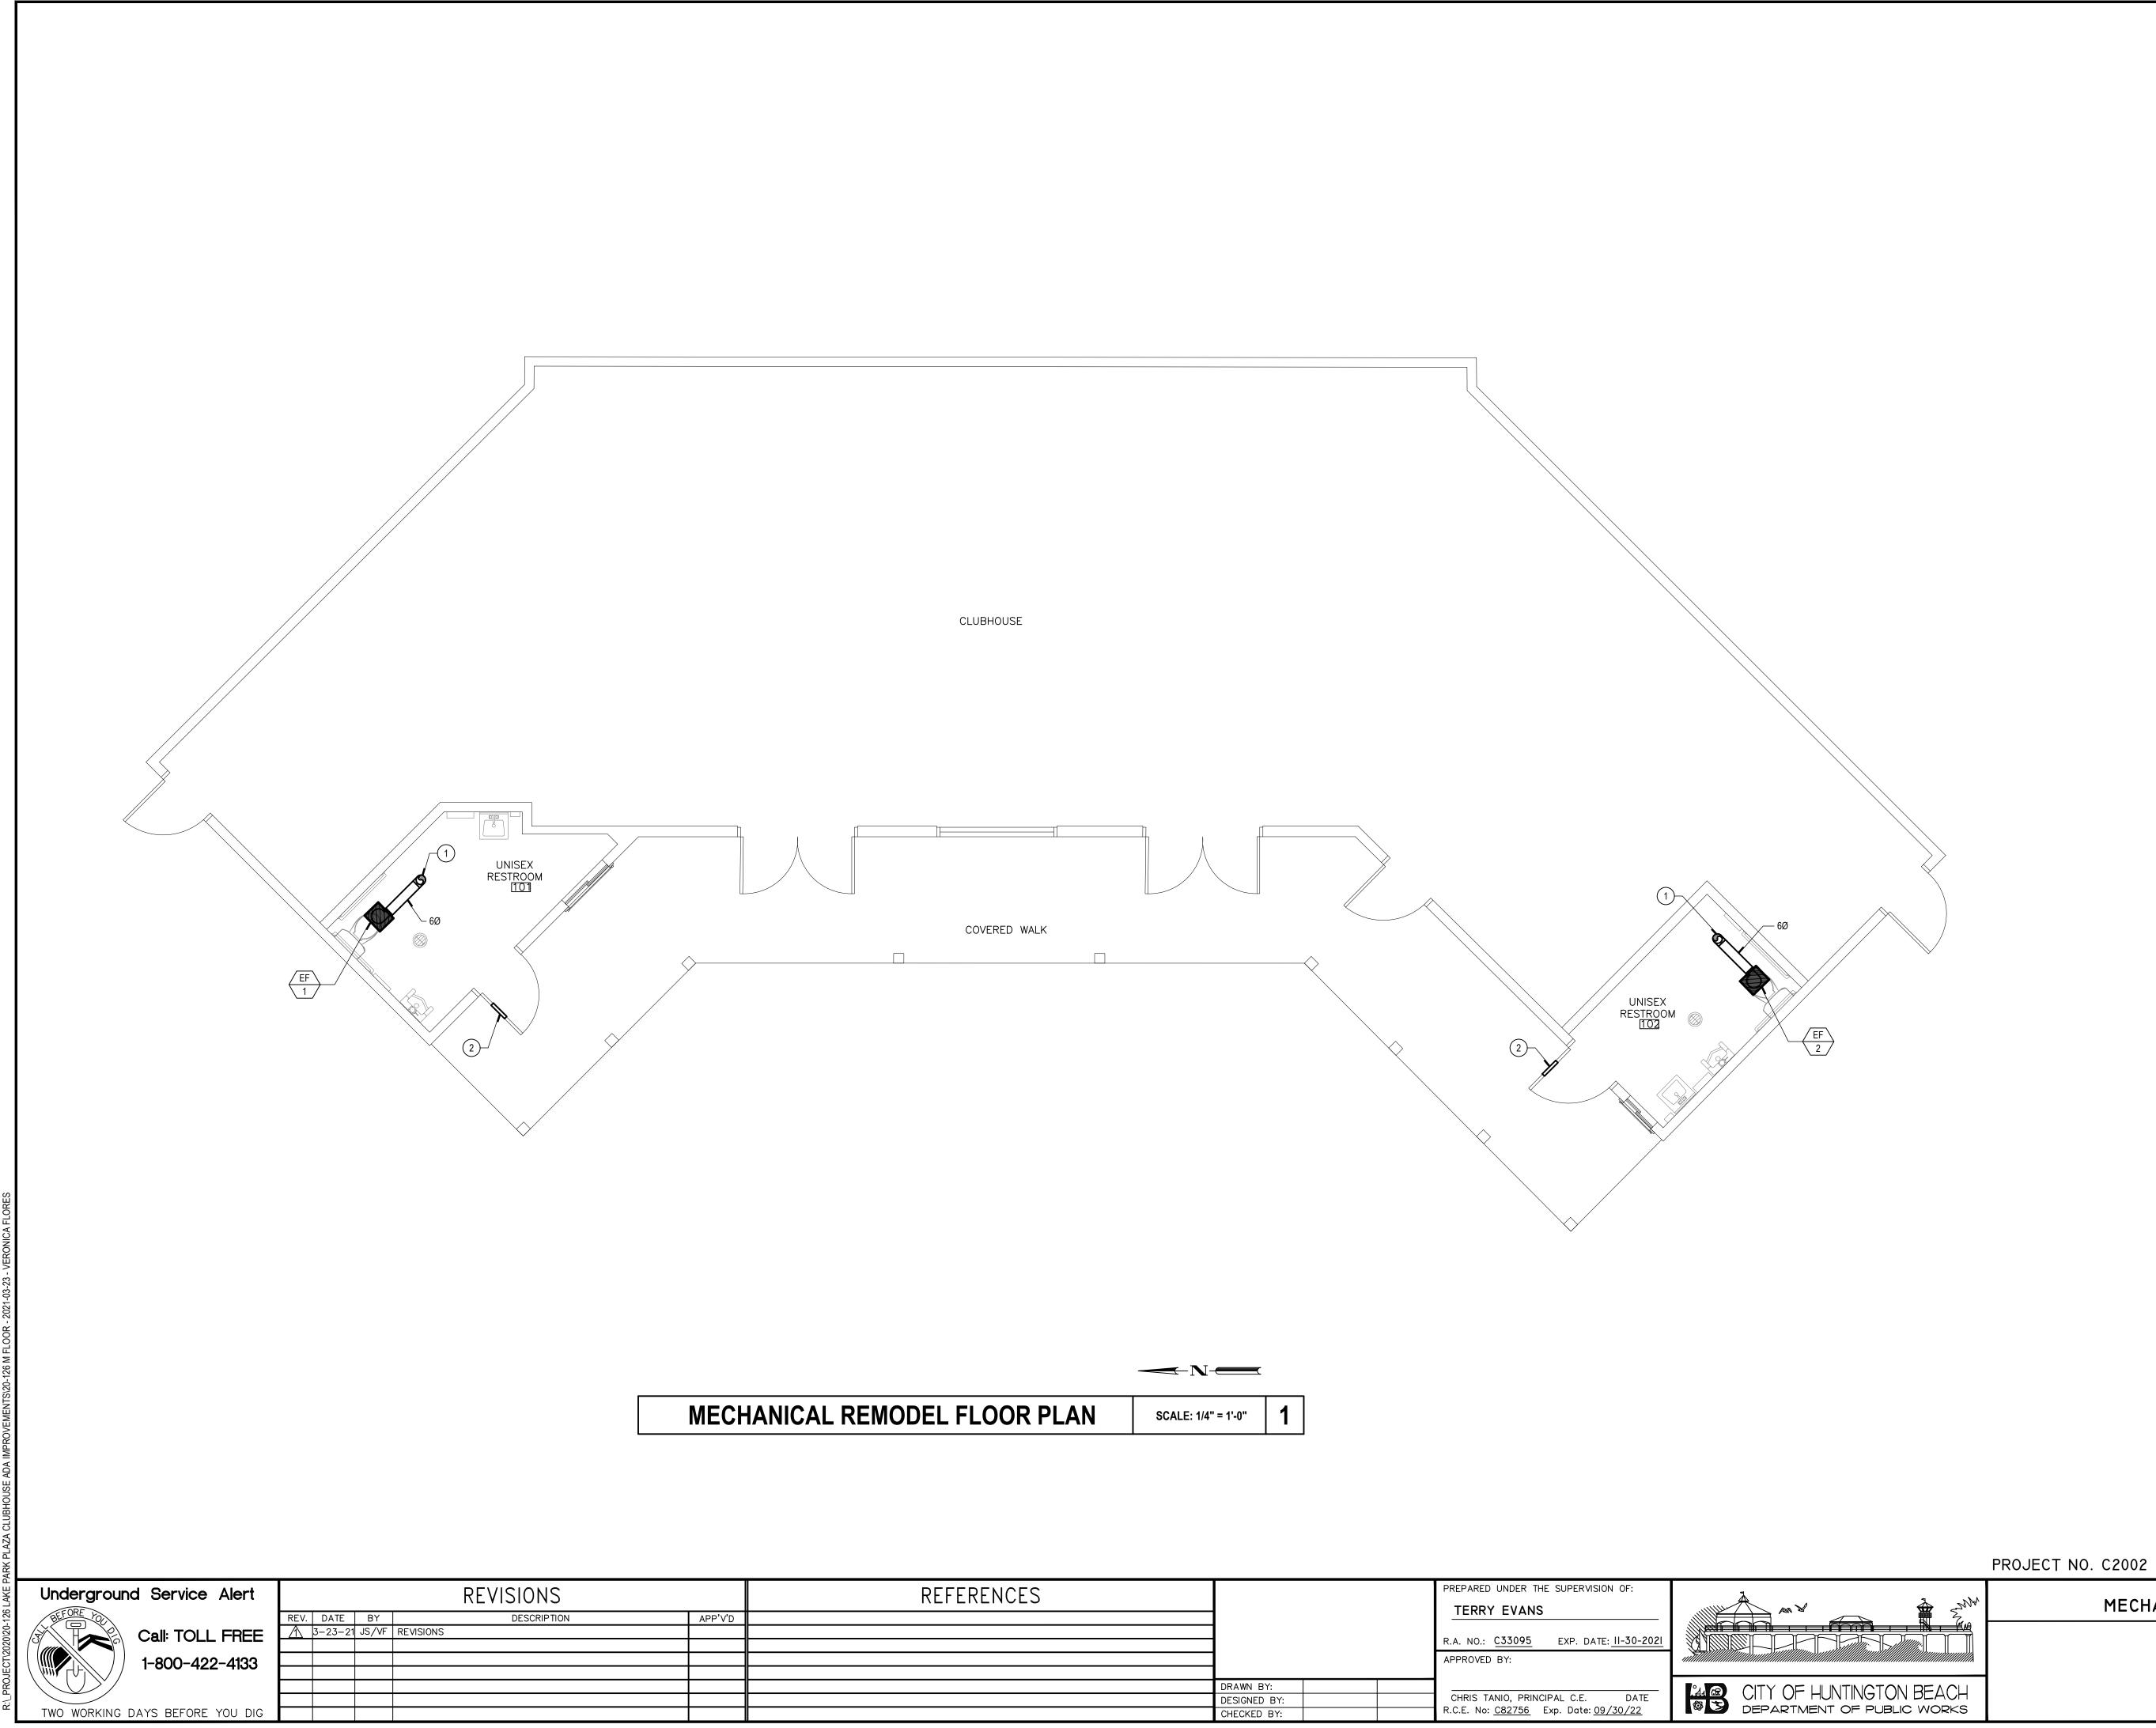

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	DESIGNED BY: CHECKED BY:	R.C.E. No: <u>C82756</u> Exp. Date: <u>09/30/22</u>		

GENERAL NOTES	
ALL DUCTWORK SHALL BE HARD DUCT. FLEXIBLE AIR DUCTS AND CONNECTORS SHALL BE NOT MORE THAN 5' IN LENGTH AND SHALL NOT BE USED IN LIEU OF RIDGED ELBOWS OR FITTINGS. FLEXIBLE AIR DUCTS SHALL BE PERMITTED TO BE USED AS AN ELBOW AT A TERMINAL DEVICE (SEC 603.4.1 CMC)	
ALL VENTING SHALL HAVE A MIN. OF 10' CLEARANCE FROM ANY FORCED AIR INLET W/ A MIN. OF 3' CLEARANCE ABOVE & A MIN OF 4' CLEARANCE FROM ANY PROPERTY LINE EXCEPT A PUBLIC WAY. 502 CMC)	
CONTRACTOR SHALL PATCH ALL ROOF PENETRATIONS AS NEED TO MAINTAIN EXISTING ROOFING WARRANTY.	
CONSTRUCTION NOTES	
) ROUTE 6"Ø EXHAUST DUCT UP THRU ROOF TO APPROVED ROOF CAP WITH WEATHER HOOD AND 1/4" MESH SCREEN	
) PROVIDE 12"x12" LOUVER IN DOOR WITH 1/4" MESH SCREEN ON THE INSIDE OF THE LOUVER. MOUNT BOTTOM OF LOUVER 18" ABOVE FINISHED FLOOR	
	ALL DUCTWORK SHALL BE HARD DUCT. FLEXIBLE AIR DUCTS AND CONNECTORS SHALL BE NOT MORE THAN 5' IN LENGTH AND SHALL NOT BE USED IN LIEU OF RIDGED ELBOWS OR FITTINGS. FLEXIBLE AIR DUCTS SHALL BE PERMITTED TO BE USED AS AN ELBOW AT A TERMINAL DEVICE (SEC 603.4.1 CMC) ALL VENTING SHALL HAVE A MIN. OF 10' CLEARANCE FROM ANY FORCED AIR INLET W/ A MIN. OF 3' CLEARANCE ABOVE & A MIN OF 4' CLEARANCE FROM ANY PROPERTY LINE EXCEPT A PUBLIC WAY. 502 CMC) CONTRACTOR SHALL PATCH ALL ROOF PENETRATIONS AS NEED TO MAINTAIN EXISTING ROOFING WARRANTY. CONSTRUCTION NOTES ROUTE 6''Ø EXHAUST DUCT UP THRU ROOF TO APPROVED ROOF CAP WITH WEATHER HOOD AND 1/4'' MESH SCREEN ON THE INSIDE OF THE LOUVER IN DOOR WITH 1/4'' MESH SCREEN ON THE INSIDE OF THE LOUVER. MOUNT BOTTOM OF LOUVER 18'' ABOVE

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XP. 9-30-20

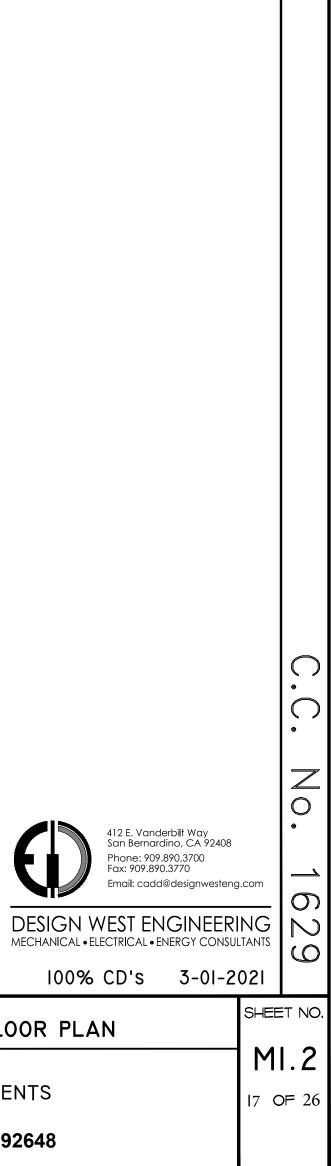SHEET TITLE

				VALVES WHICH CLOSE WITH THE FLOW OF FLUID, OI SERVING MORE THAN ONE FIXTURE. PROVIDED W ACCESS PANEL.	R ON HEADERS	7. THE INSTALLATION OF ACCESS PANELS OR OTHER INDICATING EQUIPMEN
				PIPE MATERIA	AL SCHEDULE	READING, ADJUSTMENT, INSPECTION, REPAIRS, REMOVAL OR REPLACEN LOCATED WITH REFERENCE TO THE FINISHED BUILDING.
				PIPE MATERIAL TYPE OF	PRESSURE SHUT-OFF	8. ALL EQUIPMENT AND FIXTURES INSTALLED UNDER THIS CONTRACT SHA ACCORDANCE WITH 2019 CPC/CBC.
				SERVICE & WEIGHT JOINTS	MATERIAL - SwP	9. THE INTENT OF THE DRAWINGS AND SPECIFICATIONS IS TO CONSTRUCT WITH TITLE 24, CALIFORNIA CODE OF REGULATIONS.
				COLD WATER ABV. GROUND COPPER L TUBE SOLDERED	CAST BRONZE/ WROUGHT COPPER 125 GATE CHECK	10. WHERE MATERIAL IS SHOWN ON THE DRAWINGS BUT NOT SPECIFIED, IT SH QUALITY AS EXISTING MATERIAL.
				HOT WATER ABV. GROUND COPPER L TUBE SOLDERED	CAST BRONZE/ WROUGHT COPPER 125 BALL CHECK	11. THE FIRE PROTECTION CONTRACTOR SHALL PROVIDE ALL REQUIRED HYDR SPRINKLER HEAD LOCATION IN ACCORDANCE WITH NFPA 13 TO THE LOCAL
				VENT NO-HUB CAST IRON NO-HUB	N/A N/A N/A	AND APPROVAL OF THE FIRE PROTECTION SYSTEM. 12. TEST SYSTEM(S) IN ACCORDANCE WITH REQUIREMENTS OF THE GOVERNING
				WASTE, VENT, SOIL & SCH 40 PVC DWV SOLVENT- ROOF DRAINS SCHEDULE 40 ABS WELD	ABS N/A N/A	13. ALL CLEANOUTS SHALL BE INSTALLED WHERE READILY ACCESSIBLE REQUIREMENTS THE CONTRACTOR SHALL COORDINATE ALL CLEANOUT CABINETS, ETC. AND THE ARCHITECT PRIOR TO ANY INSTALLATION.
				PIPE INSULATI	ION SCHEDULE	14. THE CONTRACTOR SHALL BE RESPONSIBLE FOR PATCHING AND REPAIRING EXCAVATED AND/OR DAMAGED BY THEIR OPERATIONS. IN ADDITION, THE TO ORIGINAL CONDITION ALL PLANTED AREAS DAMAGED BY THEIR OPERATI
				FLUID CONDUCTIVITY INSULATION TEMPERATURE RANGE MEAN RATING RANGE (IN BTU-IN/HR TEMPERATURE	PIPE SIZE (IN. DIA.) < 1 1 to < 1.5 1.5 to < 4 4 to < 8 8 an large	
				(°F) PER SQFT/°F) (°F)		16. WHEN REQUIRED BY THE AUTHORITY HAVING JURISDICTION, POTABLE DISINFECTED AND FLUSHED PRIOR TO USE BY WATER-CHLORIN/
				105° - 140° 0.22 - 0.28 100° INCHES	INSATE AND HOT WATER) AND SERVICE WATER HEATING SYSTEMS 1.0 1.5 2.0 2.0 2.0	PRESCRIBED IN AWWA C651, METHODS OF CLEANING/ DISINFECTING FC
				NOTE: WHERE INSULATED PIPING IS EXPOSED OUTDOORS, IT SHALL 0.016 INCH THICK CORRUGATED ALUMINUM JACKET. PROVIDE VALVE		17. PLUMBING PIPE, FITTINGS AND FIXTURES USED TO CONVEY OR D
				WHEN VALVE IS CYCLED		18. ANY SUBSTITUTION MADE BY THE CONTRACTOR THAT IS DIFFERENT FRO DRAWINGS SHALL BE CLEARLY INDICATED ON THE SUBMITTAL AS TO ALL TH
						19. Shut-off valves shall be provided in Main Branches, Runs to Rise Drawings.
						20. NEW NON-RESIDENTIAL WATER CLOSETS SHALL COMPLY WITH 2016 CAL-G EXCEED 1.28 GALLONS PER FLUSH. TANK-TYPE WATER CLOSETS S
						21. NEW NON-RESIDENTIAL LAVATORY FAUCETS SHALL COMPLY WITH 2016 C
LUNES						NOT EXCEED 0.5 GALLONS PER MINUTE AT 60 PSI. MANDATORY CALGREEN CH
						2019 NON - RESIDENTIAL MANDATORY MEASURE CHECKLIST
- 47-00-						CODE SECTION REQUIREMENT
-1707 - 110011						5.303.4 PLUMBING FIXTURES SHALL MEET THE MAXIMUM FLOW RATE VALUES SHOWN IN TABLE 5.303.2.3. EXCEPTIONS: 1. BUILDINGS THAT DEMONSTRATE 20-PERCENT OVERALL WATER
1021-02/0141						USE REDUCTION. IN THIS CASE A CALCULATION DEMONSTRATING A 20% REDUCTION IN THE BUILDING "WATER USE BASELINE," AS ESTABLISHED IN TABLE 5.303.2.2 SHALL BE PROVIDED.
						5.303.4 1. THE INSTALLATION OF WATER-CONSERVING FIXTURES (WATER CLOSETS, URINALS) MEETING THE CRITERIA ESTABLISHED IN SECTIONS 5.303.2 OR 5.303.3
						5.303.6PLUMBING FIXTURES AND FITTINGS SHALL BE INSTALLED WITH THE CALIFORNIA PLUMBING CODE, AND SHALL MEET THE APPLIBABLE STANDARDS REFERENCED IN TABLE 1401.1 OF THE CALIFORNIA PLUMBING CODE AND IN CHAPTER 6 OF THIS CODE
	Underground Service Alert	REVISIONS		REFERENCES		PREPARED UNDER THE SUPERVISION OF:
	Call: TOLL FREE	REV. DATE BY DESCRIPTION 1 3-23-21 JS/VF REVISIONS	APP'V'D			R.A. NO.: <u>C33095</u> EXP. DATE: <u>II-30-2021</u>
	1-800-422-4133				DRAWN BY:	
	TWO WORKING DAYS BEFORE YOU DIG				DESIGNED BY: CHECKED BY:	CHRIS TANIO, PRINCIPAL C.E. DATE R.C.E. No: <u>C82756</u> Exp. Date: <u>09/30/22</u>

FIXTURE SCHEDULE

SYMBOL			CO	NNECT	ION SIZ	ZE:	
STIVIDUL			TRAP	VENT	CW	HW	ELEC.
WC 1	WATERCLOSET: KOHLER "HIGHLINE" K-3519 PRESSURE ASSISTED, ADA, 17-1/8" HIGH RIM, (1.0 GPF), FLOOR MOUNTED, ELONGATED BOWL, TANK TYPE, WHITE VITREOUS CHINA. BEMIS PLASTIC SEAT MODEL 2L2155T, ELONGATED, OPEN FRONT, 1/4 ANGLE STOPS, STAIN & CHEMICAL RESISTANT.	3"	INT.	2"	1/2"	-	-
	URINAL: KOHLER "BARDON" K-4991-ET, ADA 17" HIGH RIM, STANDARD 24" HIGH RIM, (0.125 GPF), WALL HUNG, WHITE VITREOUS CHINA, 3/4" TOP SPUD. SLOAN ROYAL 186-0.125 FLUSH VALVE. JOSAM 17560-UR URINAL CARRIER FLOOR MOUNTED BEARING PLATE TYPE.	2"	2"	1-1/2"	3/4"	-	-
	LAVATORY: KOHLER "CHESAPEAKE" K-1722, WHITE VITREOUS CHINA, WALL HUNG LAVATORY W/ FAUCET HOLES ON CENTERS. CHICAGO FAUCETS 333-665E39PSHABCP METERING FAUCET W/0.35 GPM AREATOR, GRID STRAINER DRAIN W/ 1-1/2" CAST BRASS P-TRAP WITH CHROME FINISH, ANGLE STOPS W/ RIGID RISER. PROVIDE JOSAM 17000 SERIES WALL CARRIER	2"	1-1/2"	1-1/2"	1/2"	-	-
FD 1	FLOOR DRAIN: JOSAM 30002-5A FLOOR DRAIN WEJLOC CAST IRON BODY W/CLAMP RING, FLANGE, ADJUSTABLE NIKALOY STRAINER, POLISHED BRONZE GRATE. PROVIDED WITH TRAP PRIMER CONNECTION FOR TP-1.	2"	2"	1-1/2"	-	-	-
TP 1	TRAP PRIMER: MIFAB. MODEL "M-500" 1/2" INLET AND 1/2" OUTLET WITH OPTIONAL DISTRIBUTION UNIT, MAY BE LOCATED AS INDICATED ON DRAWINGS OR AS REQUIRED BY CODE. UPC LISTED. PROVIDED WITH A 12"X 12" ACCESS PANEL OR LARGER DEPENDING ON THE REQUIRED ACCESS TO THE EQUIPMENT AND SHUT-OFF VALVE. (CONTRACTOR TO VERIFY).	-	-	-	1/2"	-	-
WHA 1	WATER HAMMER ARRESTOR: MIFAB, INC. MODEL "MWH" (SEE PLANS FOR SIZE), INSTALLED ON ALL QUICK CLOSING VALVES AND ALL VALVES WHICH CLOSE WITH THE FLOW OF FLUID, OR ON HEADERS SERVING MORE THAN ONE FIXTURE. PROVIDED WITH A 12"X 12" ACCESS PANEL.	-	-	-	-	-	-


SERVICE	PIPE MATERIAL & WEIGHT	TYPE OF JOINTS	PRESSURE FITTINGS MATERIAL	SHUT-OFF RATINGS PSI - SwP	VALVE
COLD WATER ABV. GROUND	COPPER L TUBE	SOLDERED	CAST BRONZE/ WROUGHT COPPER	125	BALL GATE CHECK
HOT WATER ABV. GROUND	COPPER L TUBE	SOLDERED	CAST BRONZE/ WROUGHT COPPER	125	BALL CHECK
VENT	NO-HUB CAST IRON	NO-HUB	N/A	N/A	N/A
WASTE, VENT, SOIL & ROOF DRAINS	SCH 40 PVC DWV SCHEDULE 40 ABS	SOLVENT- WELD	ABS	N/A	N/A


TEMPERATURE RANGE MEA					PIPE S	IZE (IN. DIA.)		
	MEAN RATING TEMPERATURE		< 1	1 to < 1.5	1.5 to < 4	4 to < 8	8 and larger	
	PER SQF1/°F)	(°F)			REQUIRED INSUL	ATION THICK	NESS (IN.)	
SPACE HEATING, HOT WATER SYSTEMS (STEAM, STEAM CONDENSATE AND HOT WATER) AND SERVICE WATER HEATING SYSTEMS								
105° - 140°	0.22 - 0.28	100°	INCHES	1.0	1.5	2.0	2.0	2.0
	0.22 - 0.20	100*	R-VALUE	R-7.7	R-12.5	R-11	R-9	R-8
TE: WHERE INSULATED PIPING IS EXPOSED OUTDOORS, IT SHALL BE COVERED. COVER OUTDOOR EXPOSED INSULATED PIPING WITH								

GENERAL NOTES

- 1. THE TOTAL INSTALLATION SHALL COMPLY WITH ANY AND ALL REQUIREMENTS OF THE LEGALLY CONSTITUTED AUTHORITIES HAVING JURISDICTION INCLUDING 2019 CBC (CALIFORNIA BUILDING CODE) AND 2019 CMC/CPC (CALIFORNIA MECHANICAL AND PLUMBING CODE).
- 2. THE CONTRACTOR SHALL VISIT THE SITE PRIOR TO BID AND SHALL THOROUGHLY FAMILIARIZE HIMSELF WITH THE EXISTING CONDITIONS UNDER WHICH HE WILL BE REQUIRED TO WORK. ALL INDICATED DIMENSIONS ARE APPROXIMATE AND ARE GIVEN FOR ESTIMATE PURPOSES ONLY.
- 3. BEFORE PROCEEDING WITH THE WORK THIS CONTRACTOR SHALL CAREFULLY CHECK AND VERIFY ALL DIMENSIONS, SIZES, REQUIRED CLEARANCES AND SHALL ASSUME FULL RESPONSIBILITY FOR THE FITTING OF ALL EQUIPMENT AND MATERIALS HEREIN REQUIRED TO OTHER PARTS OF THE WORK OF OTHER TRADES.
- 4. THE DRAWINGS ARE ESSENTIALLY DIAGRAMMATIC TO THE EXTENT THAT ALL OFFSETS, BENDS, SPECIAL FITTINGS AND LOCATIONS ARE NOT EXACTLY LOCATED. IN THE PREPARATION OF THESE DOCUMENTS, CERTAIN ASSUMPTIONS ARE MADE REGARDING EXISTING CONDITIONS. SOME OF THESE ASSUMPTIONS MAY NOT BE VERIFIABLE WITHOUT EXPENDING ADDITIONAL SUMS OF MONEY OR DESTROYING OTHERWISE ADEQUATE OR SERVICEABLE PORTIONS OF EXISTING BUILDINGS AND/OR EQUIPMENT. THEREFORE, THE ENGINEER SHALL NOT BE HELD RESPONSIBLE FOR ANY CHANGES OR ADDITIONAL COSTS INCURRED DUE TO EXISTING CONDITIONS.
- 5. ITEMS RELATED TO PLUMBING UTILITIES AND/OR OTHER SERVICE(S); MATERIALS, LABOR, PERMITS, FEES, ETC., SHALL BE VERIFIED WITH THE RESPECTIVE SERVING UTILITY COMPANY PRIOR TO SUBMISSION OF A BID. THE ACT OF SUBMITTING A BID SHALL CONSTITUTE FULL RESPONSIBILITY OF THE CONTRACTOR TO INSTALL SERVICE(S) IN COMPLIANCE WITH THE REQUIREMENTS OF THE SERVING UTILITY COMPANY AND THE MECHANICAL ENGINEER. THE CONTRACTOR SHALL BE RESPONSIBLE FOR ALL CHARGES LEVIED BY THE SERVING UTILITY COMPANY EXCEPTING THE FIRST BILLING DEPOSIT.
- THE CONTRACTOR SHALL COMPLY WITH ALL CONTRACT DOCUMENTS IN LAYING OUT THEIR WORK AND 6. EQUIPMENT. THEY SHALL COORDINATE THE WORK OF THIS SECTION WITH THE WORK OF OTHER TRADES AND ALL JOB CONDITIONS.

CODE SECTION	REQUIREMENT	
5.303.4	PLUMBING FIXTURES SHALL MEET THE MAXIMUM FLOW RATE VALUES SHOWN IN TABLE 5.303.2.3. EXCEPTIONS: 1. BUILDINGS THAT DEMONSTRATE 20-PERCENT OVERALL WATER USE REDUCTION. IN THIS CASE A CALCULATION DEMONSTRATING A 20% REDUCTION IN THE BUILDING "WATER USE BASELINE," AS ESTABLISHED IN TABLE 5.303.2.2 SHALL BE PROVIDED.	
5.303.4	1. THE INSTALLATION OF WATER-CONSERVING FIXTURES (WATER CLOSETS, URINALS) MEETING THE CRITERIA ESTABLISHED IN SECTIONS 5.303.2 OR 5.303.3	
5.303.6	PLUMBING FIXTURES AND FITTINGS SHALL BE INSTALLED WITH THE CALIFORNIA PLUMBING CODE, AND SHALL MEET THE APPLIBABLE STANDARDS REFERENCED IN TABLE 1401.1 OF THE CALIFORNIA PLUMBING CODE AND IN CHAPTER 6 OF THIS CODE	

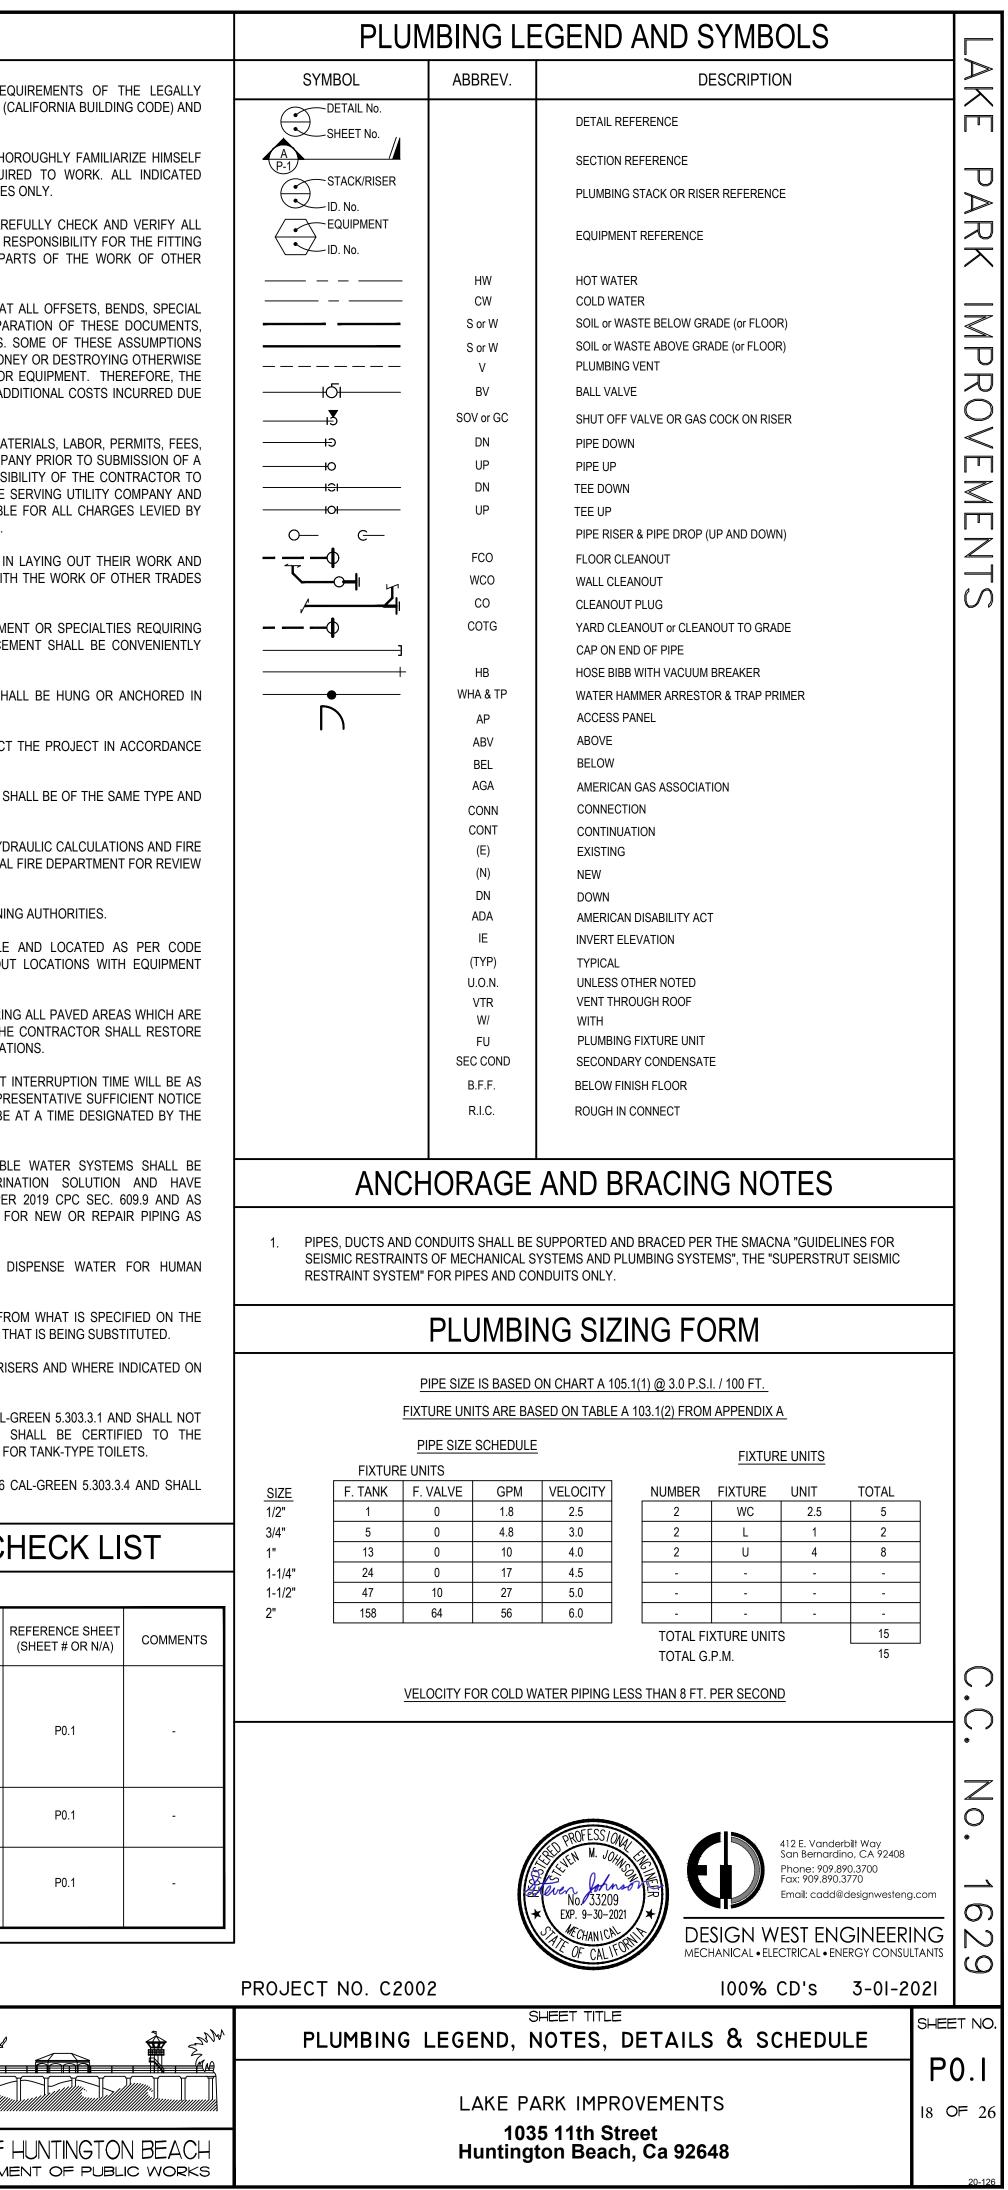

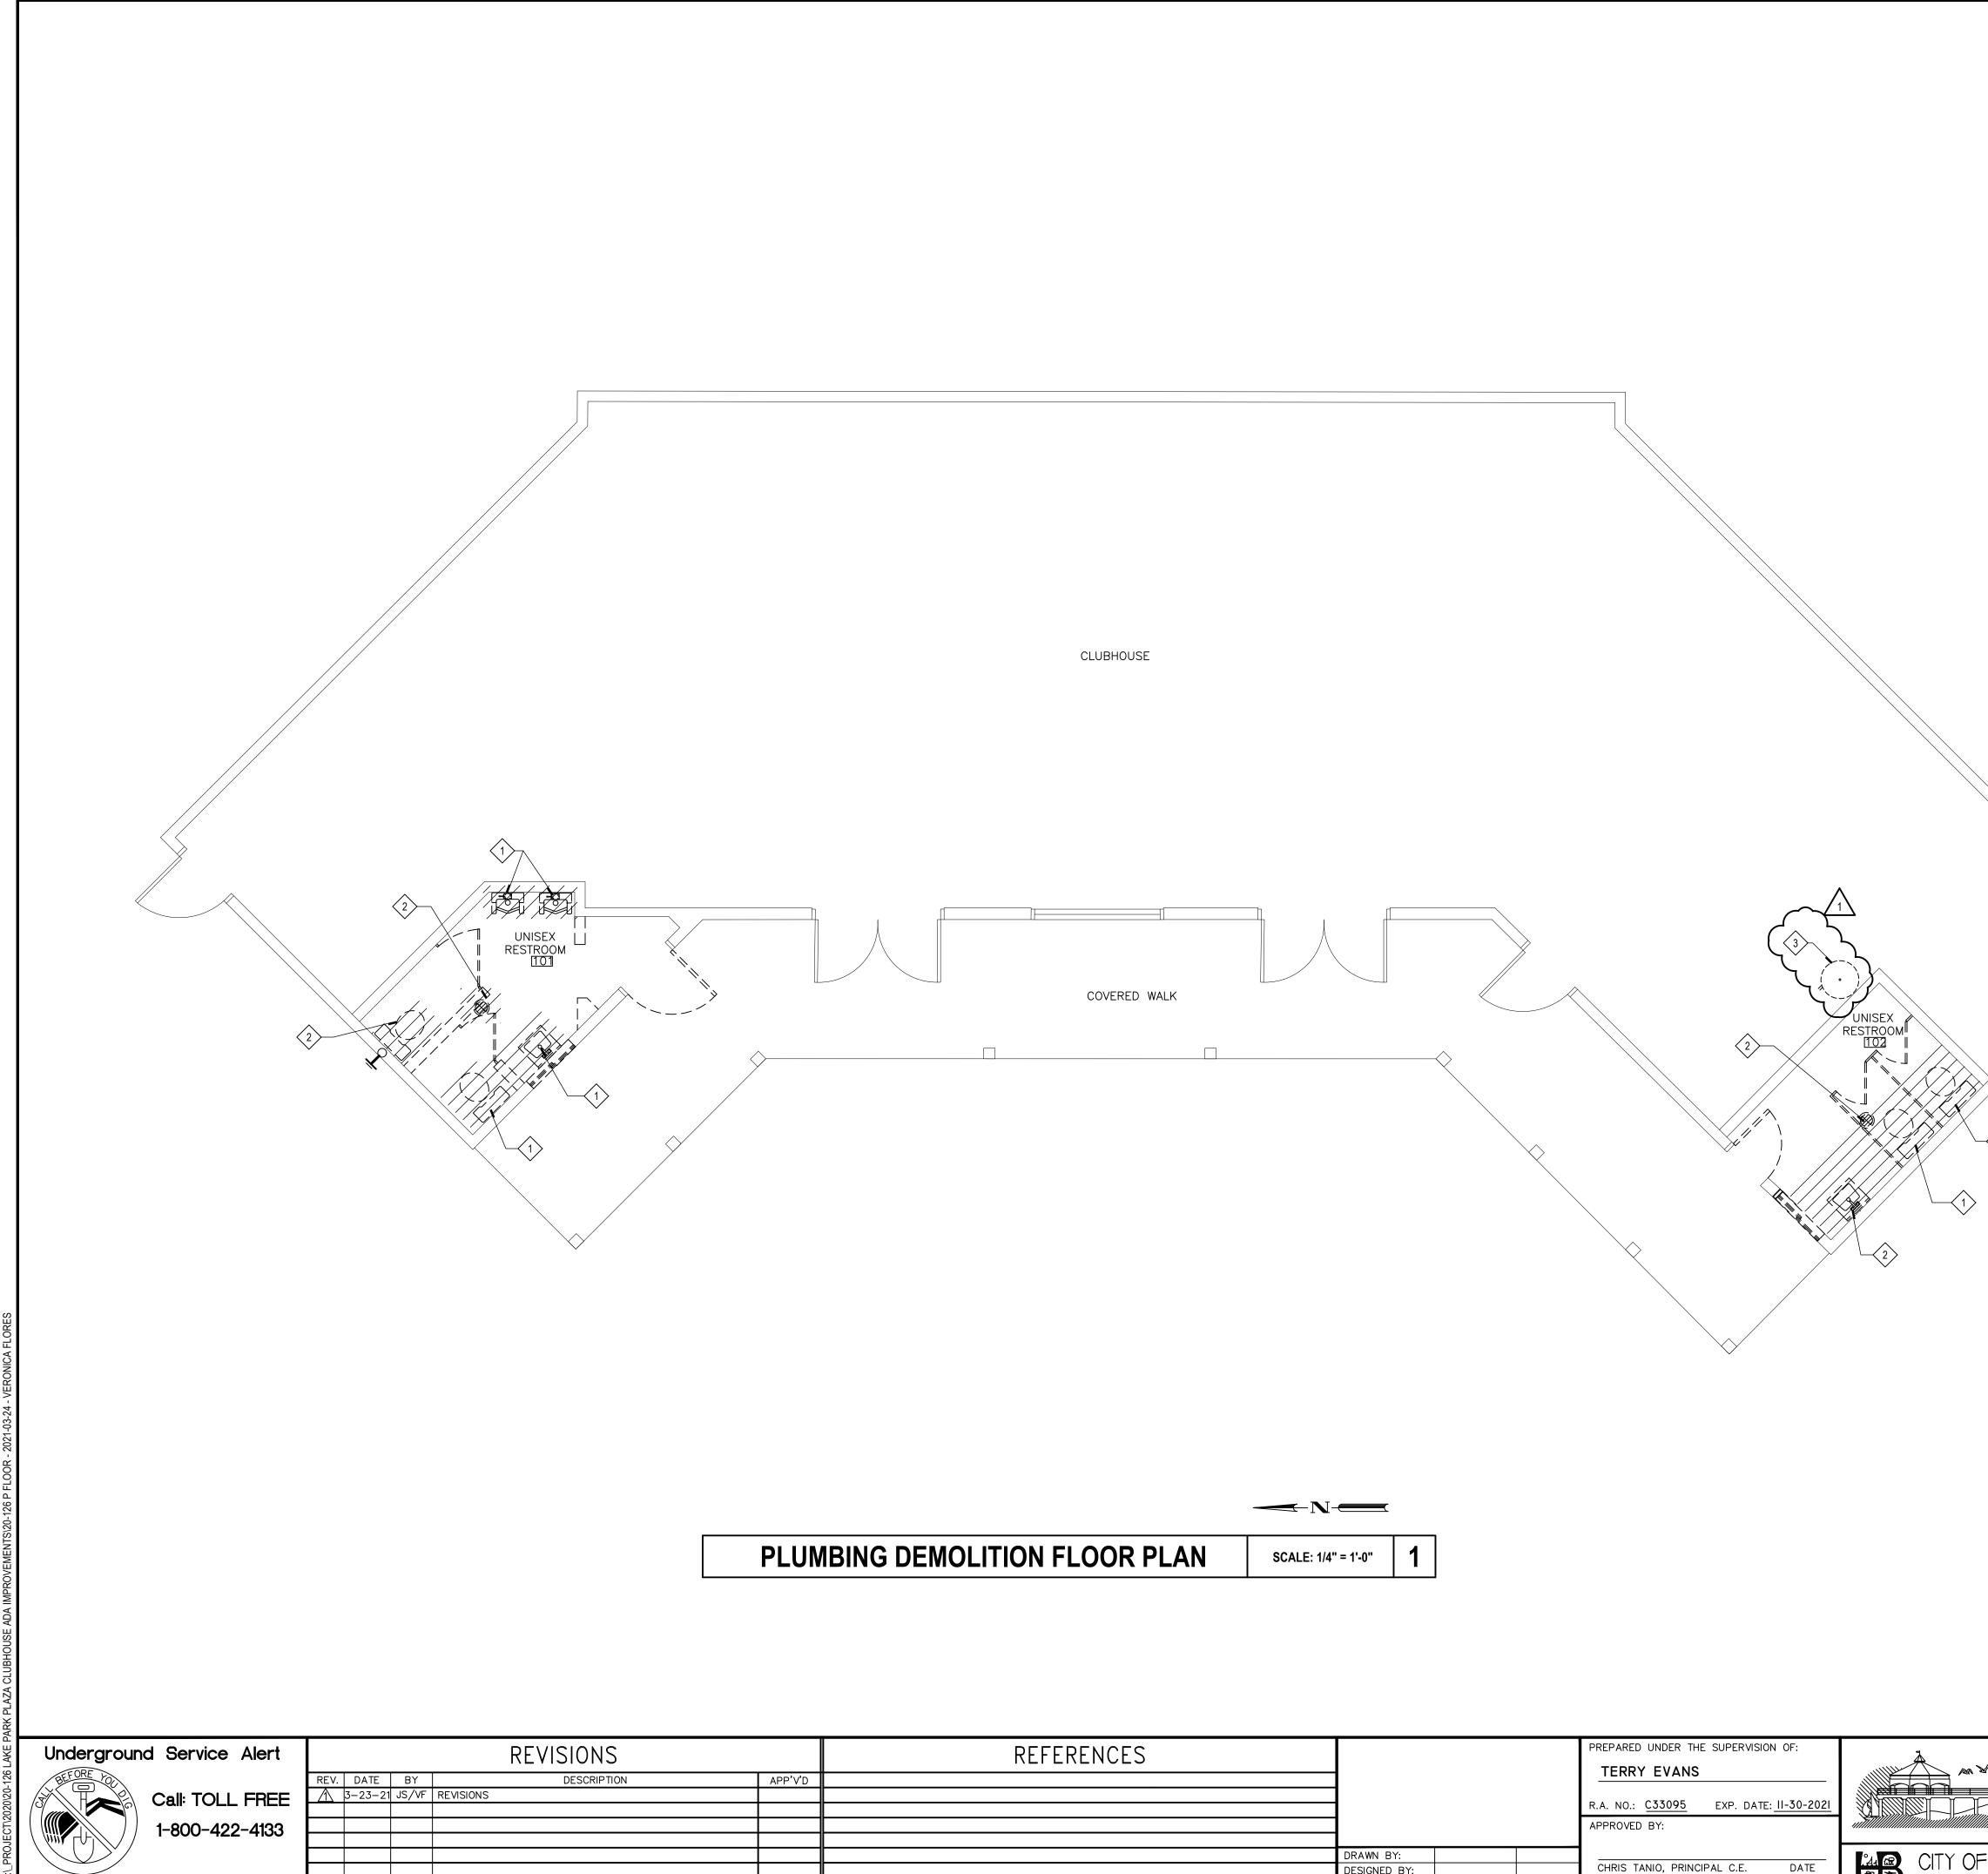

TWO WORKING DAYS BEFORE YOU DIG

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	DRAWN BY: DESIGNED BY: CHECKED BY:	CHRIS TANIO, PRINCIPAL C.E. DATE R.C.E. No: <u>C82756</u> Exp. Date: <u>09/30/22</u>	CITY OF H

DEMOLITION NOTES	
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EXISTING FIXTURE TO BE REMOVED. REMOVE ALL RELATED PIPING BACK AND CAP IN CEILING AND BELOW SLAB


2 EXISTING FIXTURE TO BE REMOVED AND REPLACED WITH NEW FIXTURE. EXISTING PIPING TO REMAIN & REWORKED FOR CONNECTION

 $\sqrt{3}$ EXISTING WATER HEATER TO REMAIN $\sqrt{1}$

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 \bigcirc \bigcirc Z 0 412 E. Vanderbilt Way San Bernardino, CA 92408 Phone: 909.890.3700 Fax: 909.890.3770 ____ Email: cadd@designwesteng.con \mathcal{O} DESIGN WEST ENGINEERING MECHANICAL • ELECTRICAL • ENERGY CONSULTANTS \mathbb{N} \odot 100% CD's 3-01-2021 PROJECT NO. C2002 SHEET TITLE SHEET NO. PLUMBING DEMOLITION FLOOR PLAN PI.I LAKE PARK IMPROVEMENTS 19 OF 26 1035 11th Street Huntington Beach, Ca 92648 F HUNTINGTON BEACH MENT OF PUBLIC WORKS




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		GEN	ERAL NOTES	
		AIR INLET W/ A MIN. OF	AVE A MIN. OF 10' CLEARANCE FROM ANY F F 3' CLEARANCE ABOVE & A MIN OF 4' CLEA	P
		2. CONTRACTOR SHALL	LINE EXCEPT A PUBLIC WAY. PER SEC. 906 TRACE EXISTING WASTE LINES PRIME	OR TO
		WASTE LINES TO VER MADE. CONTRACTOR	ERIFY EXACT LOCATION AND DEPTH OF EX IFY THAT CONNECTION TO WASTE LINES SHALL NOTIFY GENERAL CONTRACTO ELY IF THERE ARE ANY PROBLEM WITH EX	CAN BE
		SEWER LINE, AS IT REL	ATES TO ITS CONDITION OR INVERT ELEVAT	
			DE THE BUILDING SHALL BE SLOPED AT 2% S PATCH ALL ROOF PENETRATIONS AS NE	
			BE PROVIDED TO THE LAVATORIES	
		CONST	RUCTION NOTES	
			VASTE LINE INTO EXISTING WASTE LINE. R	\leq
		ADDITIONAL PIPING INTO EXISTING VEN	S NEEDED FOR NEW CONNECTION AND P AS REQUIRED. CONNECT NEW 1-1/2" VEN T. PROVIDE NEW 1/2" CW LINE INTO EXIST EXACT SIZE AND LOCATION OF EXISTING LIN	NT LINE
		AND REWORK EXIS AND PROVIDE ADDI	VASTE LINE INTO EXISTING WASTE LINE. CL TING PIPING AS NEEDED FOR NEW CONN ITIONAL PIPING AS REQUIRED. CONNECT	IECTION
		EXISTING CW LINE. EXISTING LINE	XISTING VENT. PROVIDE NEW 3/4" CW LIN . FIELD VERIFY EXACT SIZE AND LOCAT	ION OF
		VERIFY EXACT SIZE	WASTE LINE INTO EXISTING WASTE LINE AND LOCATION OF EXISTING LINE	
			/2" VENT LINE INTO EXISTING VENT LINE AND LOCATION OF EXISTING LINE	
		EXACT SIZE AND LOO	CW LINE INTO EXISTING CW LINE. FIELD	VERIFY
		(6) ROUTE 3/4" CW DN IN (7) EXISTING WATER HE	N WALL AND ROUTE TO FIXTURE	\sim
			' HW LINE INTO EXISTING HW LINE. FIELD D LOCATION OF EXISTING LINE	VERIFY
		9 3/4" HW DN IN WALL		
wc co				
1-1/2"				
4"				
TP WHA 1 1				
				6
		PROFESSIONAL	412 E. Vanderbilt Way San Bernardino, CA 9240	
		Steven Johnson	Phone: 909.890.3700 Fax: 909.890.3770 Email: cadd@designweste	
		EXP. 9-30-2021	DESIGN WEST ENGINEE	
	PROJECT NO. C2002	CALIN	100% CD's 3-01-	
	PLUMBING	SHEET TITLE	OR PLAN	SHEET NO.
				PI.2
	1	PARK IMPROVEMI		20 OF 26
F HUNTINGTON BEACH MENT OF PUBLIC WORKS	Hunti	ngton Beach, Ca	92648	20-126

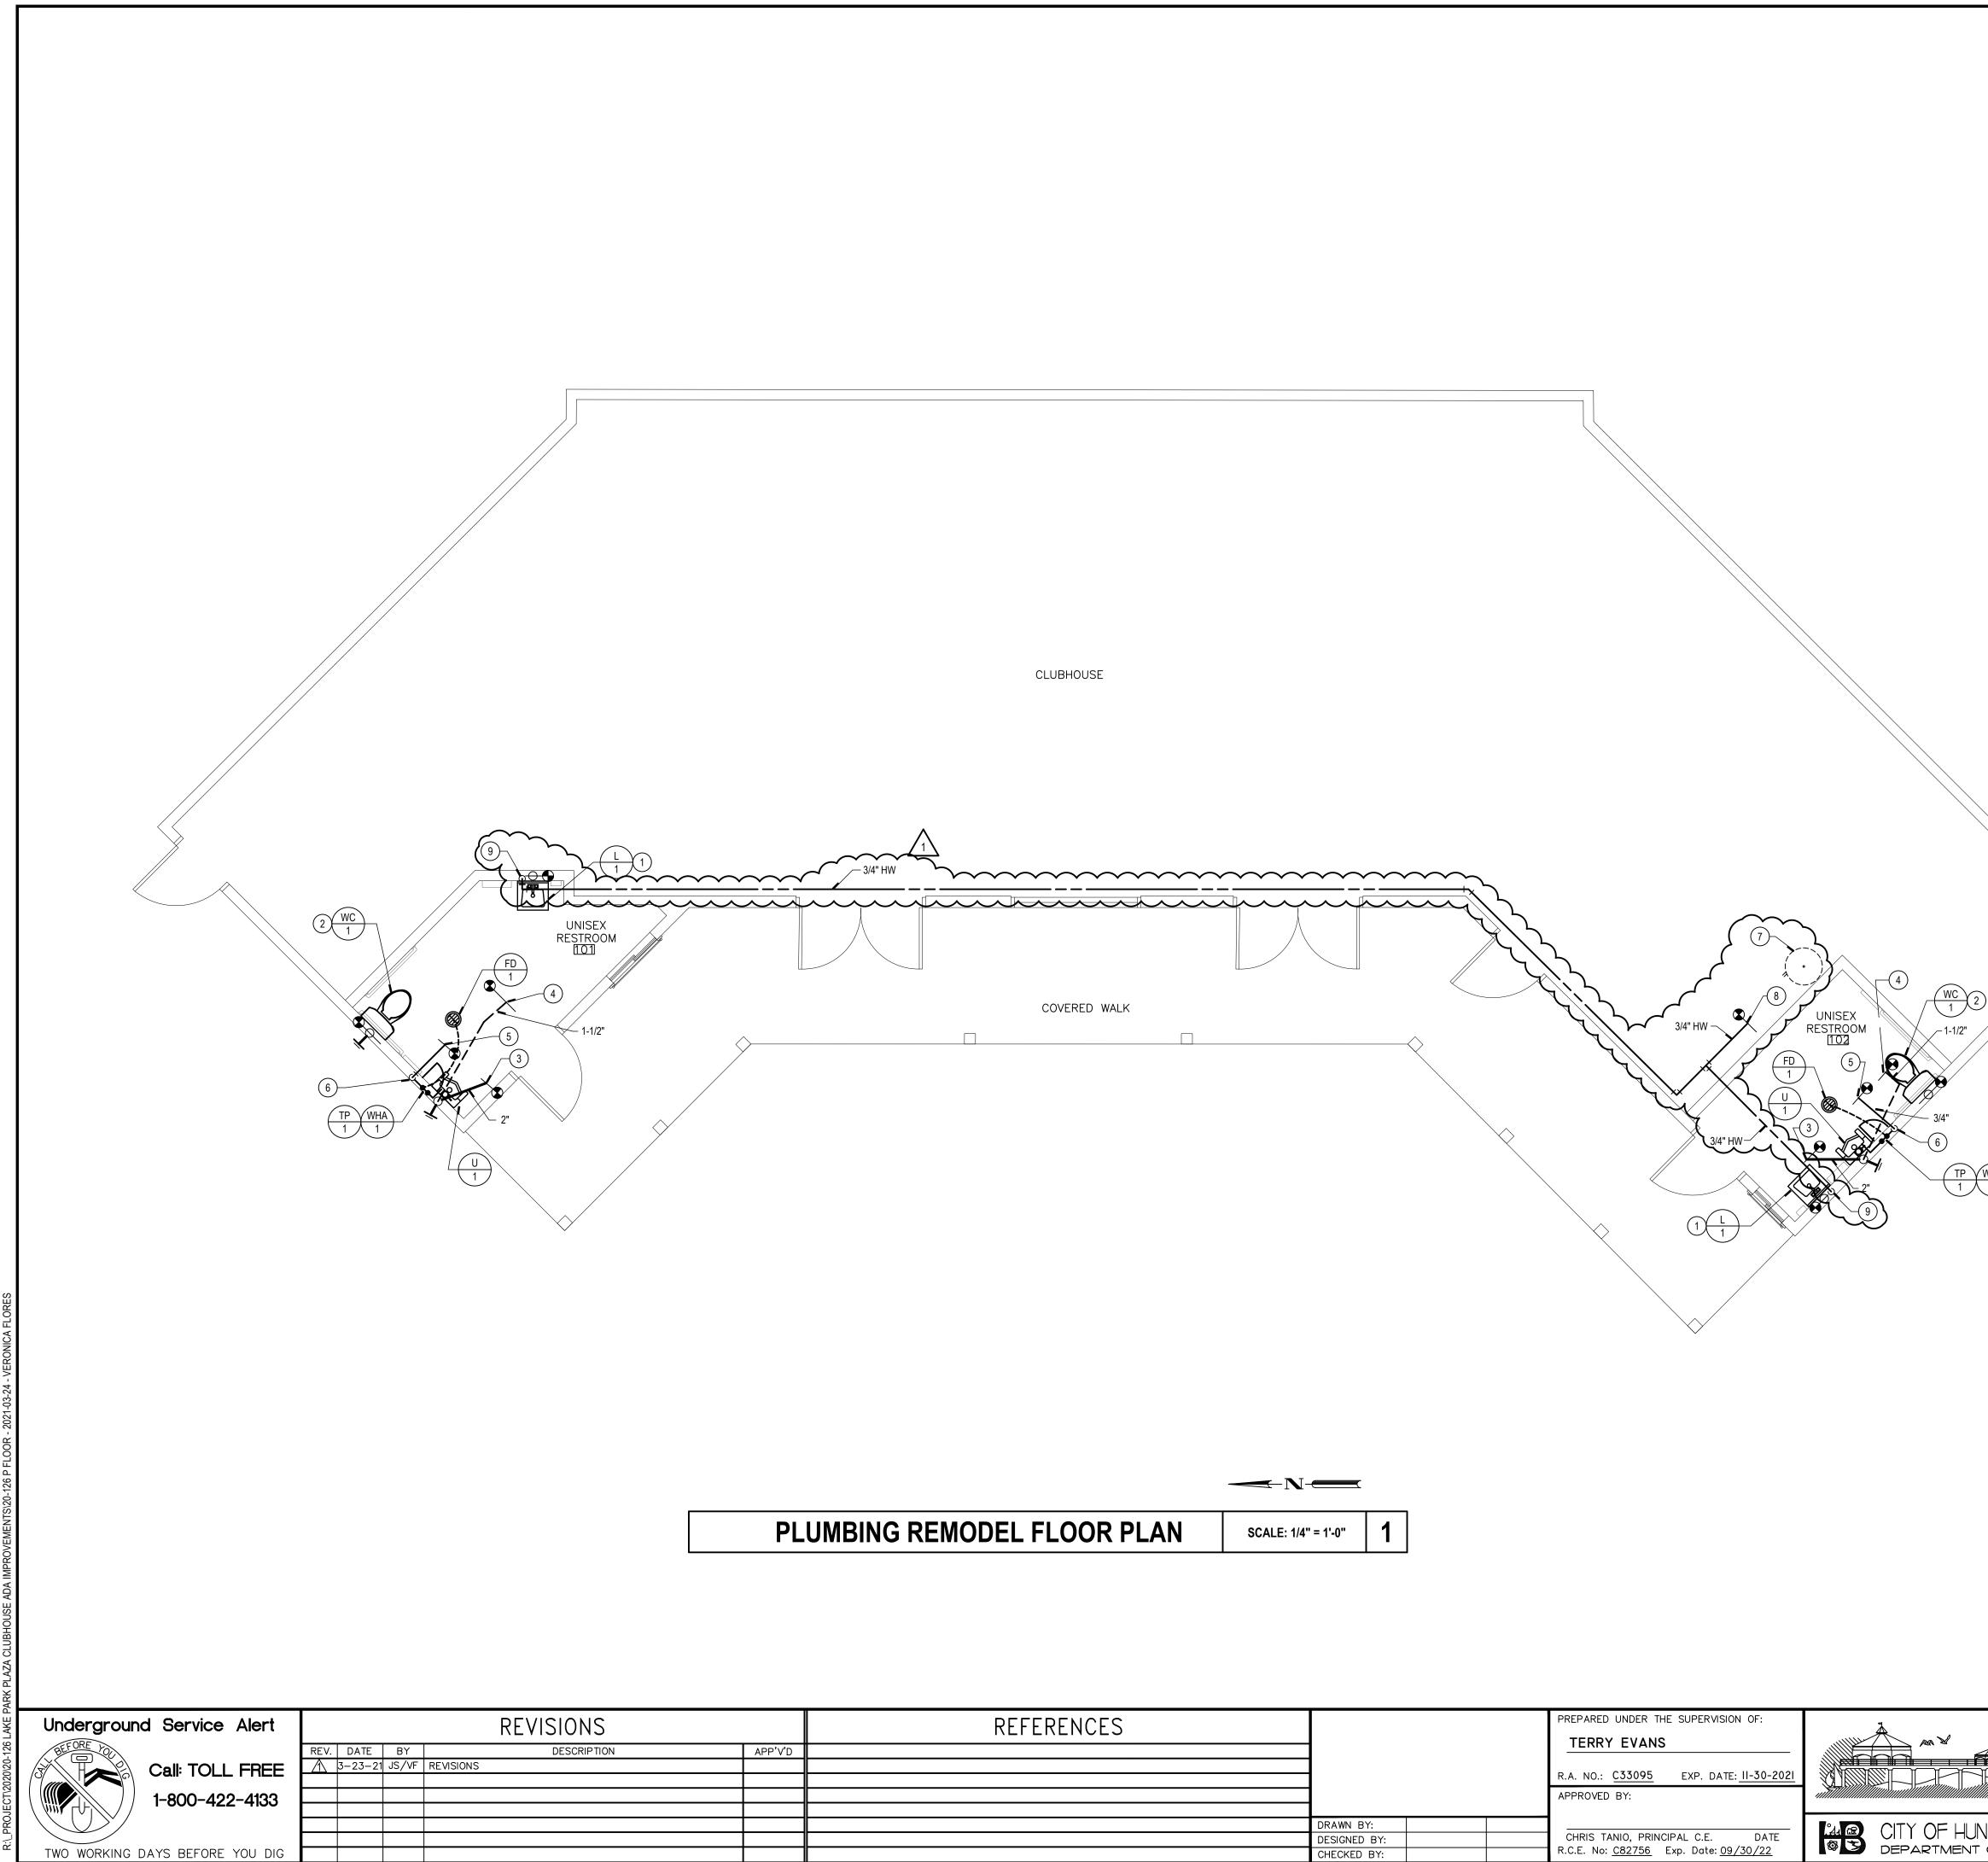
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	Underground Service Alert	REV. DATE BY	REVISIONS	APP'V'D	
-070707		3-23-21 JS/VF REVISIONS			
	1-800-422-4133				
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1/2020/20-126 LAKE PARK PLAZA CLUBHOUSE ADA IMPROVEMENTS/20-126 P FRONT - 2021-03-24 - VERONICA




	GENERAL	_ N(DTES								
1	. CONTRACTOR SHALL VERIFY EXISTING SITE CONCATIONS OF SERVICE FACILITIES BEFORE S CONTRACTOR ACCEPTS THE CONDITIONS UND PERFORM HIS WORK.	SUBMITTIN	G BID. SUBM	ITTAL OF BID INDICATES							
2	. CONSTRUCTION TERMINOLOGY, AND THE STAN THESE CONTRACTOR DOCUMENTS ARE BASE (NATIONAL ELECTRICAL CONTRACTORS ASSOC AMERICAN NATIONAL STANDARDS INSTITUTE MANUFACTURERS ASSOCIATION, UNDERWRITE ELECTRICAL CODE. SUBMITTAL OF BID INDI THESE STANDARDS AND THE REQUIREMENTS AS SET FORTH IN THESE CONTRACT DOCUM	ED ON PU CIATION), DOCUMEN IRS LABO ICATES TI S NECESS	JBLISHED STAN NATIONAL ELE ITS, NATIONAL RATORIES, AND HE CONTRACTO GARY TO PERFO	DARDS OF N.E.C.A. CTRICAL SAFETY CODE, ELECTRICAL THE CALIFORNIA R IS FAMILIAR OF DRM ALL THE WORK				5			
3	. SHOP DRAWINGS SHALL BE SUBMITTED WITHI CONTRACT. THE CONTRACTOR SHALL SUBMIT MATERIALS AND EQUIPMENT INCLUDING MANU FOR THE JOB. SHOP DRAWINGS SHALL INCI ENGINEER IDENTIFICATION, AND ALL DATA WIT CATALOG NUMBERS, MANUFACTURER'S BROC	T EIGHT JFACTURE LUDE JOE TH CAPAC	COPIES OF A R AND MODEL B DESCRIPTION ITIES, SIZES, [COMPLETE LIST OF NUMBER PROPOSED , ARCHITECT AND DIMENSIONS,			$^{\circ}$				
4	. SUBMIT SHOP DRAWINGS FOR ALL MAJOR PII INCLUDES, BUT NOT LIMITED TO: LIGHTING FI	ECES OF	ELECTRICAL E	QUIPMENT, WHICH							
5	. THESE PLANS ARE DIAGRAMMATIC ONLY. FO ARCHITECTURAL DRAWINGS FOR DETAILS, STR OUTLET LOCATIONS.										
6	. ROUTING OF RACEWAYS SHALL BE AT THE O OTHERWISE NOTED AND SHALL BE COORDINA	OPTION OF	THE CONTRA	CTOR UNLESS							
7	. DO NOT SCALE THE ELECTRICAL DRAWINGS F OR EQUIPMENT,	FOR LOCA	TIONS OF ANY	ELECTRICAL DEVICES							
8	. CONTRACTOR SHALL PROVIDE ALL J-BOXES, COMPLETE, CODE APPROVED, INSTALLATION C ELECTRICAL SINGLE LINES AND RISER DIAGRA AND ARE NOT FOR BIDDING PURPOSES OR I RESPONSIBILITY OF THE CONTRACTOR TO RE FIRE PROTECTION, AND PLUMBING DRAWINGS	OF ALL C AMS ARE MATERIAL VIEW AND	ONDUIT. FOO FOR CALCULA TAKEOFF. IT TO COORDINA	TAGE SHOWN ON TION PURPOSES ONLY, SHALL BE THE TE WITH MECHANICAL,							
9	ALL MATERIALS SHALL BE NEW, AND OF THE GROUP OF EQUIPMENT. MATERIALS SHALL E UNDERWRITER'S LABORATORIES FOR THE USE INSPECTION LABEL WHERE SUBJECT TO APPF APPROVAL OF THE DIVISION OF INDUSTRIAL JURISDICTION. MATERIALS SHALL BE MANUFA STANDARDS ESTABLISHED BY A.N.S.I., U.L., N MANUFACTURER'S RECOMMENDATIONS.	BE LISTED E AND EN ROVAL. I SAFETY, A ACTURED) AND APPROV IVIRONMENT, A MATERIALS SHA AND ALL GOVE IN ACCORDAN	ED BY THE ND SHALL BEAR THE LL MEET WITH THE RNING BODIES HAVING CE WITH APPLICABLE			(1/2) E=-2.0				
10.	. CONTRACTOR SHALL PERFORM HIS WORK IN COUNTY, LOCAL CODES, O.S.H.A., THE PRESE AND PRESENTLY ADOPTED CALIFORNIA ELECT	ENTLY AD	OPTED NATION								
11.	. COORDINATE WITH OTHER TRADES AS TO THE EQUIPMENT. SUPPLY POWER AND MAKE COI REQUIRING ELECTRICAL CONNECTIONS AS IND ELECTRICAL DRAWINGS, AND DRAWINGS OF O OTHER TRADES FOR CONTROL DIAGRAMS, SIZ SWITCHES, STARTERS, WIRING, CONTROLS, AN OPERATIONS SHALL BE PROVIDED. THE CON OBTAINING MANUFACTURER'S SHOP DRAWINGS THIS EQUIPMENT.	NNECTION DICATED C DTHER TRA ZE AND L ND CONDU NTRACTOR	IS TO MOTORS ON THE SINGLE ADES. REVIEW OCATION OF E JIT FOR MECH/ SHALL BE RE	AND EQUIPMENT LINE DIAGRAM, THE DRAWINGS OF QUIPMENT. DISCONNECT ANICAL AND PLUMBING SPONSIBLE FOR)			
12.	. EXACT METHOD AND LOCATION OF CONDUIT I WALLS OR FLOORS OR STRUCTURAL STEEL M STRUCTURAL ENGINEER. PERFORM CORING, OF EXISTING WALLS AND SURFACES WHEREN OPENINGS SHALL BE SEALED IN AN APPROV THE PARTICULAR WALL, FLOOR, OR CEILING CONDUIT PENETRATIONS AND OPENINGS IN APPROVED.	MEMBERS SAW CUT VER IT IS VED METH . EXACT	SHALL BE AS TING, PATCHIN NECESSARY T HOD TO MEET METHOD AND	DIRECTED BY THE G, AND REFINISHING O PENETRATE. THE FIRE RATING OF LOCATIONS OF							
14	 ALL CONDUIT SHALL BE INSTALLED CONCEAL CONCEALED CONDUIT SHALL BE ELECTRICAL TYPE COUPLERS. SECURED WITH ONE-HOLE CONDUIT SHOWN AS EXPOSED OR APPROVED BE INTERMEDIATE METALLIC CONDUIT (I.M.C.). STRAPS AND SCREWS. ALL BOXES AND FITT COMPLIANCE WITH C.E.C. ARTICLE 370. 	METALLIC E PIPE S D FOR EX . SECUR	TUBING (E.M. TRAPS. TERIOR EXPOS ED WITH TWO-	T.) WITH COMPRESSION ED INSTALLATION SHALL -HOLE MALLEABLE PIPE			(3/4) E-2.0)		
16	. PENETRATIONS TO FIRE-RATED MATERIALS SH AS REQUIRED BY THE STATE FIRE MARSHAL										
	 ALL CONDUCTORS OF EVERY SYSTEM SHALL O.S.H.A. THE COMPLETE ELECTRICAL SYSTEM SHALL E 										
	THE PRESENTLY ADOPTED EDITION OF THE . CONDUCTORS SHALL BE CODE GRADE, 600 V LENGTH SHOWING MANUFACTURER'S NAME, M	C.E.C., A VOLT CLA	RTICLE #250. SS, COPPER,	MARKED 24" ALONG IT'S							
	CONDUCTORS SHALL BE TYPE "THWN" (WET) THE JOB SITE IN UNBROKEN PACKAGES.	or "the	IN" (DRY). D	ELIVER CONDUCTORS TO							
20	CONTRACTOR SHALL FURNISH AND INSTALL A FOR COMPLETE CONNECTION TO MECHANICAL DRAWINGS FOR CONTROL SCHEMATICS.							\times		- EXISTING PANEL "A"	
21.	ARCHITECTURAL REFLECTED CEILING PLANS IN SHALL TAKE PRECEDENCE OVER THE LOCATION DRAWINGS. INSTALL THE LIGHTING FIXTURES	ONS OF S IN ANY	SAME AS SHOV GIVEN AREA T	/N ON THE ELECTRICAL D AGREE WITH THE						- EXISTING MAIN SERVICE "MS"	\sim \sim \sim
22.	REFLECTED CEILING PLANS. DISCREPANCIES THE ARCHITECT. . IT SHALL BE THE CONTRACTORS RESPONSIBIL	LITY TO N	ERIFY TYPE O	F CEILING SYSTEMS							
	AND TO FURNISH APPROVED LIGHTING FIXTU IN SUBJECT CEILING. WHERE FIXTURES ARI CEILINGS, THEY SHALL BE COMPLETE WITH PLASTER FRAMES.	E RECES	SED IN PLASTE	R OR DRYWALL							
24	. PROVIDE THE OWNER WITH ONE (1) SET OF REPRODUCIBLE DRAWINGS AT THE COMPLETIO OF UNDERGROUND CONDUIT RUNS AT ALL LO	ON OF TH	E PROJECT, S	HOWING ACTUAL DEPTHS				\times			
	MANUALS, CATALOGS, SHOP DRAWINGS, ETC. PROJECT COMPLETION.	SHALL B	E TURNED OVE	R TO THE OWNER AT				\times			
25	. THE COMPLETE PROJECT SHALL BE GUARANT DATE OF ACCEPTANCE, BY OWNER. ANY WO FAULTY DURING THAT PERIOD SHALL BE COR NOTIFICATION, AT THE EXPENSE OF THE ELEC	ORK, MATE RRECTED	ERIAL OR EQUI IN A TIMELY N	PMENT FOUND TO BE							
26.	WHERE A CONFLICT OCCURS BETWEEN THESE THE ELECTRICAL BOOK SPECIFICATIONS ISSUE	E NOTES, ED AS A	THE ELECTRIC	AL DRAWINGS OR SE DOCUMENTS, THE							
	MORE STRINGENT REQUIREMENT SHALL PRE	VAIL.									
					ELECTRICA	LSIT	TE PLAN				
		-									
	Inderground Service Alert	REV.	DATE BY		IONS ESCRIPTION	APP'V'D	REFERENCES			PREPARED UNDER THE SUPERVISION OF: TERRY EVANS	
Ì	Call: TOLL FREE 1-800-422-4133									R.A. NO.: <u>C33095</u> EXP. DATE: <u>II-30-2021</u> APPROVED BY:	
Т	WO WORKING DAYS BEFORE YOU DIG							DE	RAWN BY: ESIGNED BY: HECKED BY:	CHRIS TANIO, PRINCIPAL C.E. DATE R.C.E. No: <u>C82756</u> Exp. Date: <u>09/30/22</u>	CITY (
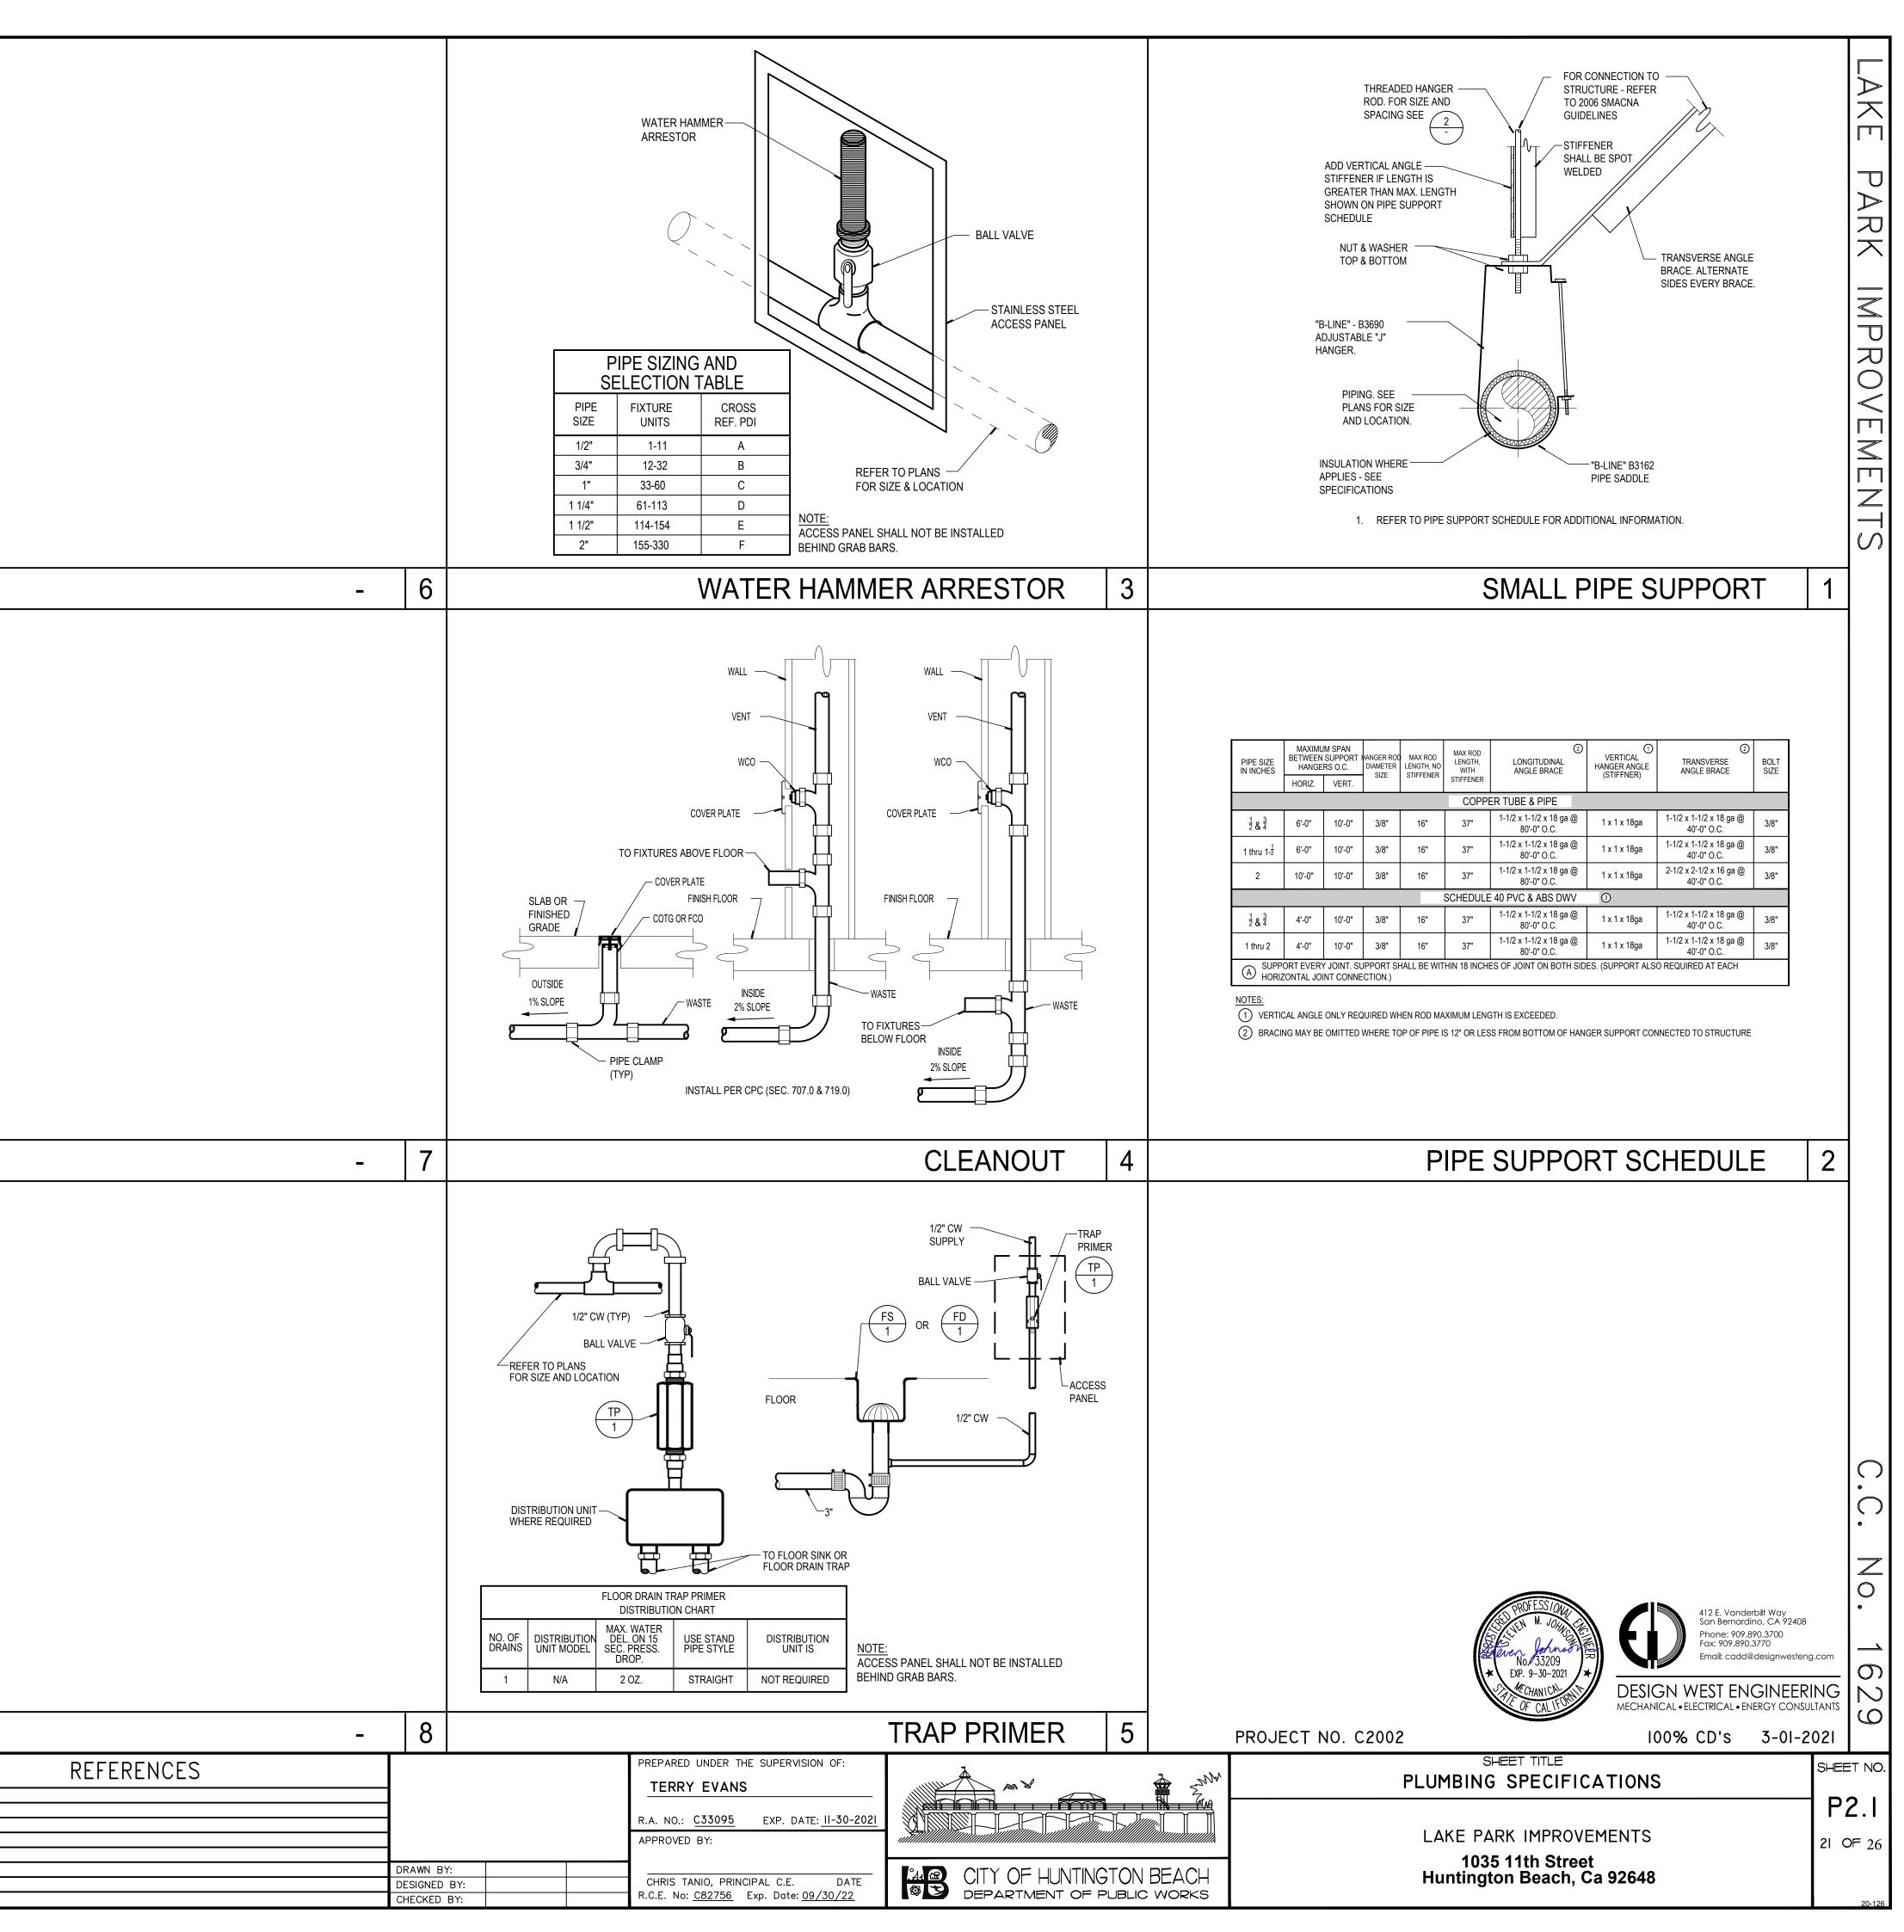
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TWO	WORKING	DAYS	BEFORE	YOU	DI

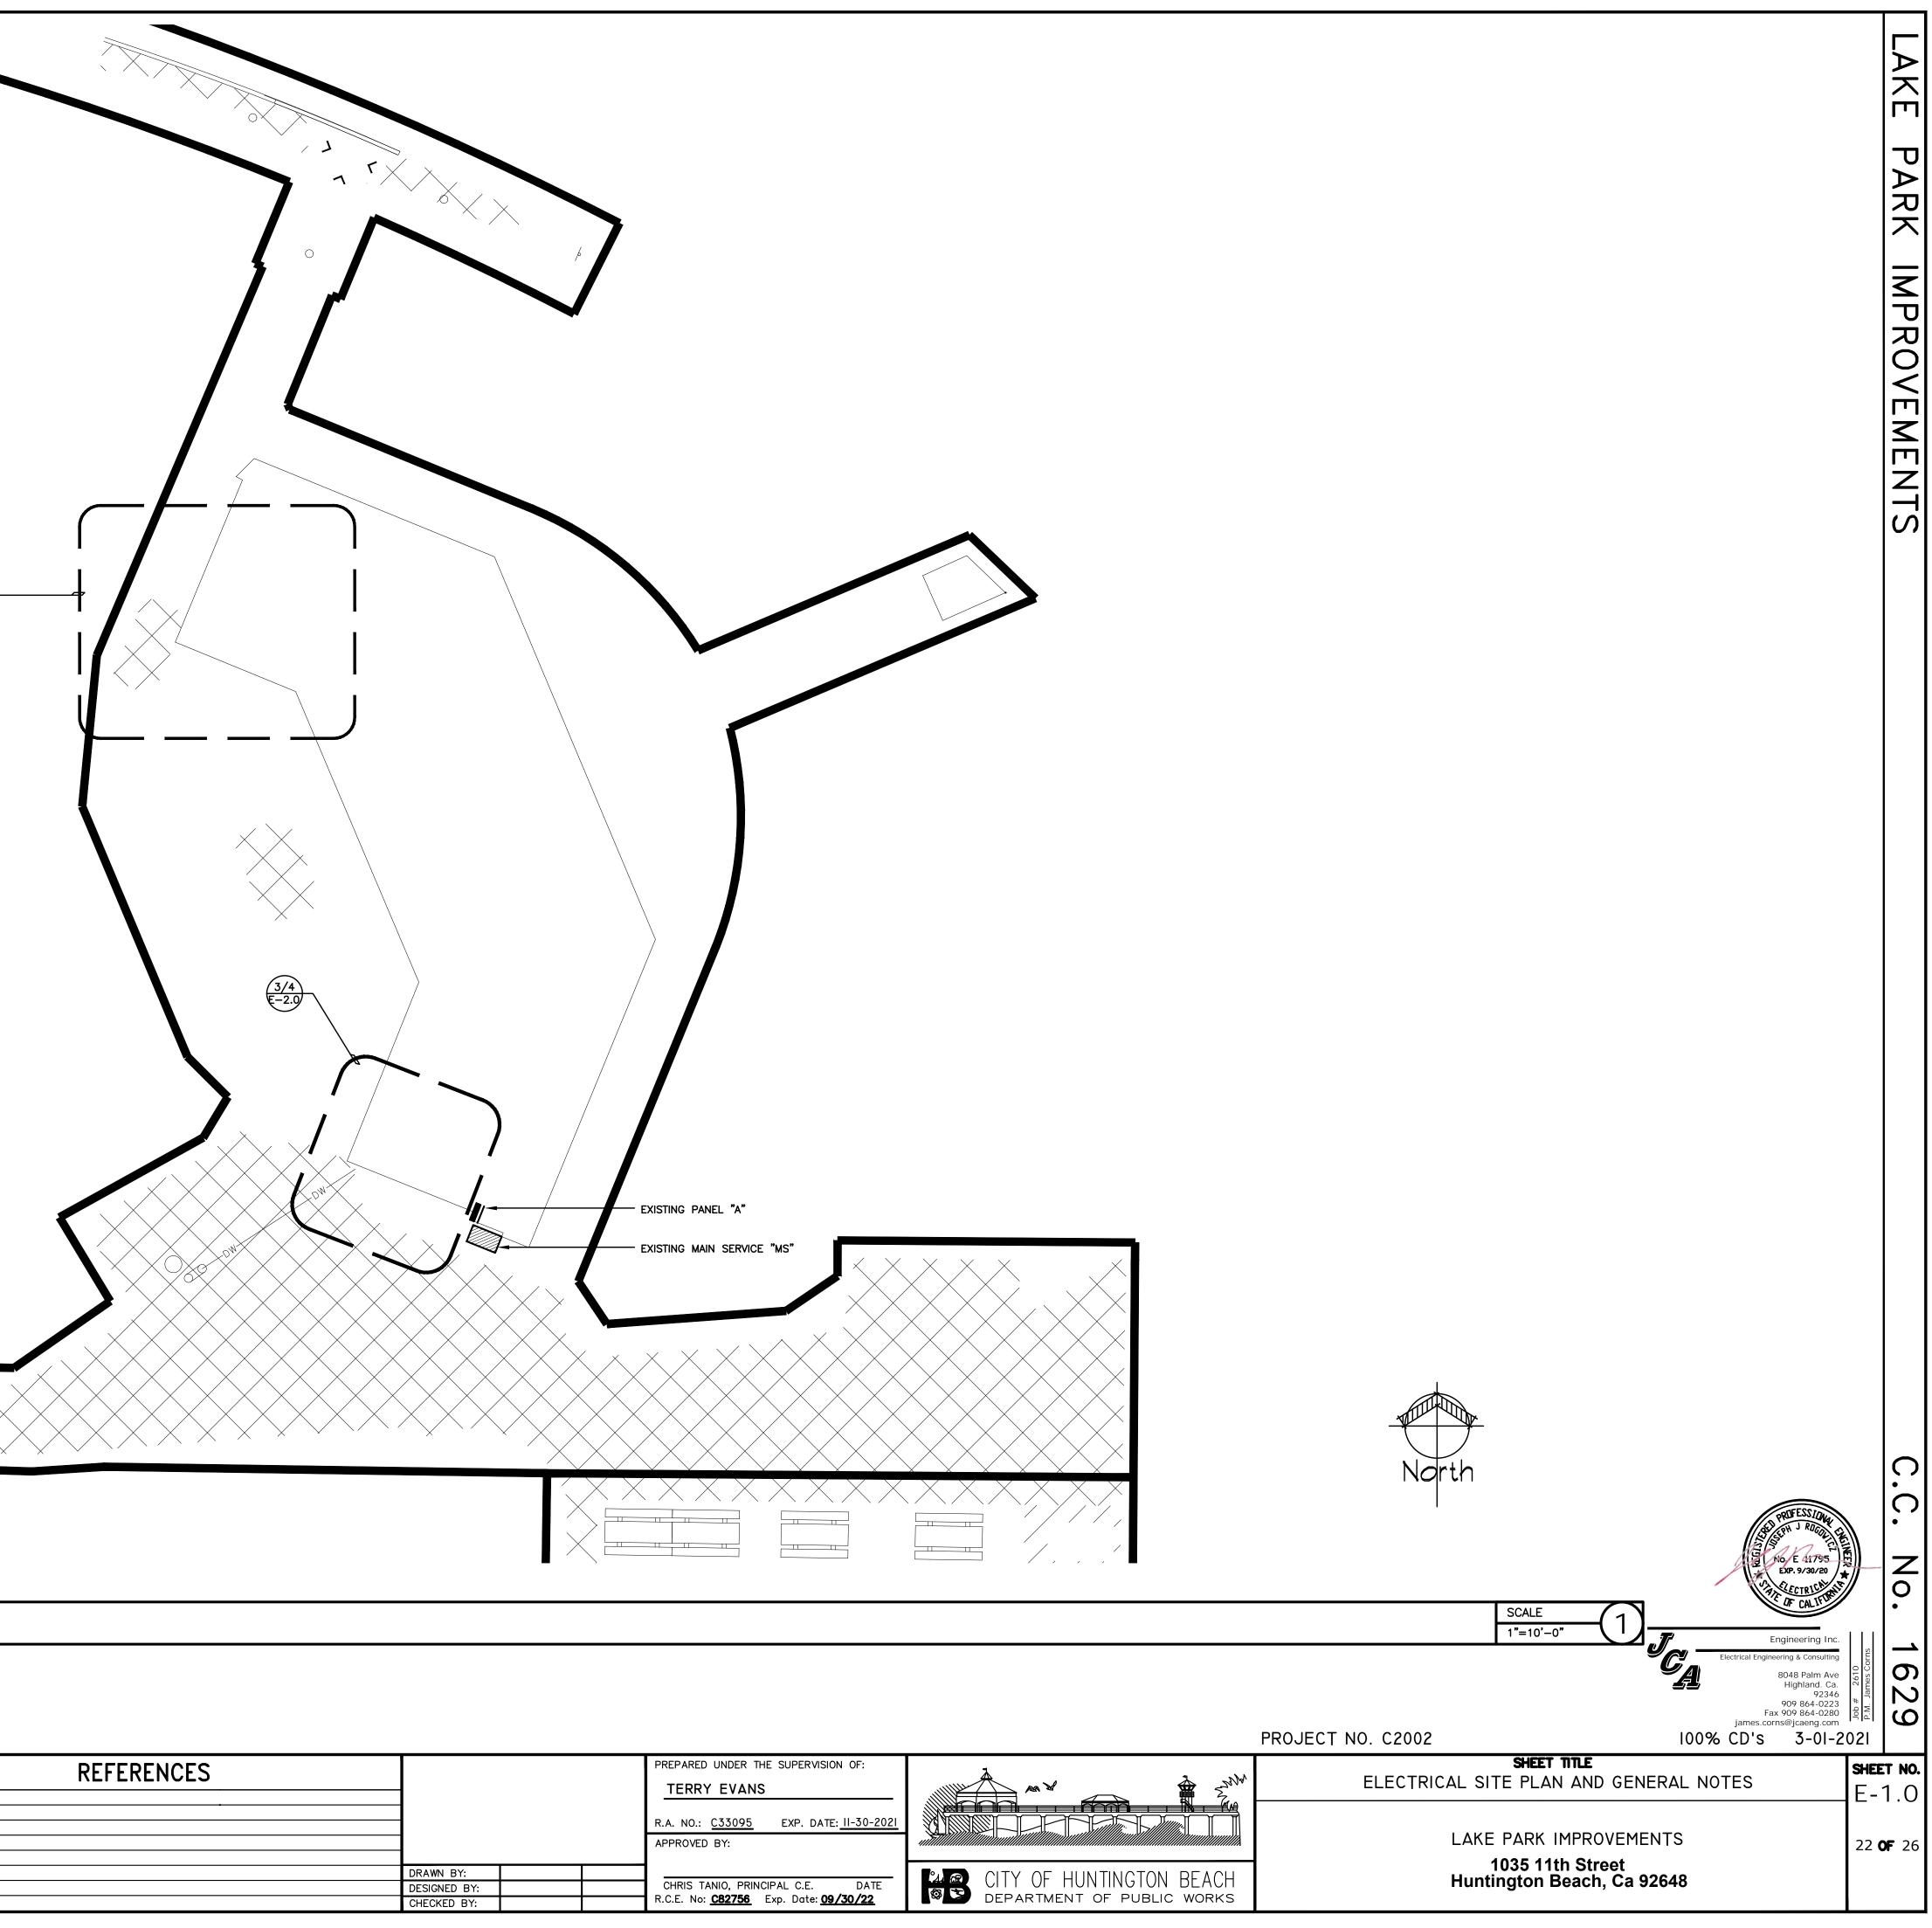



		DEMOLITION NOTES:	ELECTRICAL SYMBOLS LIST
EXISTING MAIN SERVICE "MS" 120/240V. 3# 4W		Image: stating existing existing flush mounted light fixture and provide new junction box in attic maintain circuit Image: stating existing flush mounted light fixture and provide new junction box in attic maintain circuit Image: stating existing flush mounted light fixture and provide new junction box in attic maintain circuit Image: stating existing flush mounted light fixture and provide new junction box in attic maintain circuit Image: stating existing flush mounted light fixture and provide new junction box in attic maintain circuit Image: stating existing flush mounted light fixture and provide new junction box in attic maintain circuit Image: stating existing flush mounted light fixture and provide new junction box in attic maintain circuit Image: stating existing flush mounted light fixture and provide new junction box in attic maintain circuit Image: stating existing flush mounted light fixture attice	SURFACE MOUNTED LE.D. LIGHT FIXTURE - REFER TO FIXTURE SCHEDULE. JUNCTION BOX, ACCESSIBLE AND MOUNTED FOR THE APPLICATION DENOTED ON PLANS. JUNCTION BOX, WALL MOUNTED. FIELD VERIFY MOUNTING HEIGHT PRIOR TO ROUGH-IN. SURFACE MOUNTED ELECTRICAL PANELBOARD OR LOAD CENTER. REFER TO PANEL SCHEDULE. FUSED DISCONNECT SWITCH - HP RATED WITH FUSES PER EQUIPMENT MANUFACTURER AND WEATHERPROOF AS REQUIRED. H GROUND CONNECTION, SIZE AS INDICATED OR AS REQUIRED. CELLING MOUNTED LIGHTING MOTION SENSOR SINGLE POLE WALL SWITCH, +48" A.F.F. TO TOP, SUBSCRIPTS AT SYMBOL INDICATE THE FOLLOWING. M - MOTOR STARTING SWITCH A-1.3.5 H A-1.3.5 H A-1.
			C CONDUIT E/G EQUIPMENT GROUND (GREEN)
	North	North	U.O.N. UNLESS OTHERWISE NOTED 2 PLAN NOTE REFERENCE. 4 REVISION REFERENCE.
			MH MOUNTING HEIGHT
SINGLE LINE DIAGRAM	DEMOLITION FLOOR PLAN	B DEMOLITION FLOOR PLAN SCALE (1 3/16"=1'-0"	
<section-header> LIGHTING FLYURE SCHEDULE MANUFACTURES ARE LISE OF NAMING ONE OR MORE MANUFACTURES, WITHINON, WHERE THREE OR MORE MANUFACTURES ARE LISE OF NAMING ONE OR MORE MANUFACTURES, WITHINON, WHERE THREE OR MORE MANUFACTURES, WITHINON, SUBSTITUTION, WHERE THREE OR MORE MANUFACTURES, WITHIN 35 DAYS FROM THE DATE OF THE NOTICE TO PROCEED WILL ONLY BE CONSIDERED IN ACCORDANCE WITH DMISION 1.0F THESE CONTRACT OSHALL INCLUED ONLY SPECIFIED PRODUCTS IN BID. REQUEST FOR SUBSTITUTION, WITHIN 35 DAYS FROM THE DATE OF THE NOTICE TO PROCEED WILL ONLY BE CONSIDERED IN ACCORDANCE WITH DMISION 1.0F THESE CONTRACT OCUMENTS. MILL INCLUED ONLY SPECIFIED PRODUCTS IN BID. REQUEST FOR SUBSTITUTION, ONLY AND THE DATE OF THE NOTICE TO PROCEED WILL ONLY BE CONSIDERED IN ACCORDANCE WITH DMISION 1.0F THESE CONTRACT DOLUMENTS. INCLUENT ONLY AND THE FOLLOWING THE OTHER ONLY THE ONL</section-header>	UNISEX RESTROOM 102 4 53 7 7 7 7 7 7 7 7 7 7 7 7 7 7 7 7 7 7	UNISEX RESTROOM IN ATTIC SPACE EXTEND EXISTING CIRCUIT (A-11)TO NEW LIGHT FIXTURE	
	North	North	PRIFESSIONE State PRIFESSIONE
	ELECTRICAL FLOOR PLAN	B ELECTRICAL FLOOR PLAN	PROJECT NO. C2002
Underground Service Alert REVISIONS	REFERENCES	PREPARED UNDER THE SUPERVISION OF:	SHEET TITLE DEMOLITION PLANS, FLOOR PLANS AND SINGLE LINE DIAGRAM E-2.0
Call: TOLL FREE		TERRY EVANS R.A. NO.: C33095 EXP. DATE: 11-30-2021 APPROVED BY:	LANL FARM IMPROVEMENTS 23 OF 26
1-800-422-4133 Two working days before you dig	DRAWN BY: DESIGNED BY: CHECKED BY:	CHRIS TANIO, PRINCIPAL C.E. DATE R.C.E. No: <u>C82756</u> Exp. Date: <u>09/30/22</u> CITY OF HUNTINGTON BEACH	1035 11th Street Huntington Beach, Ca 92648

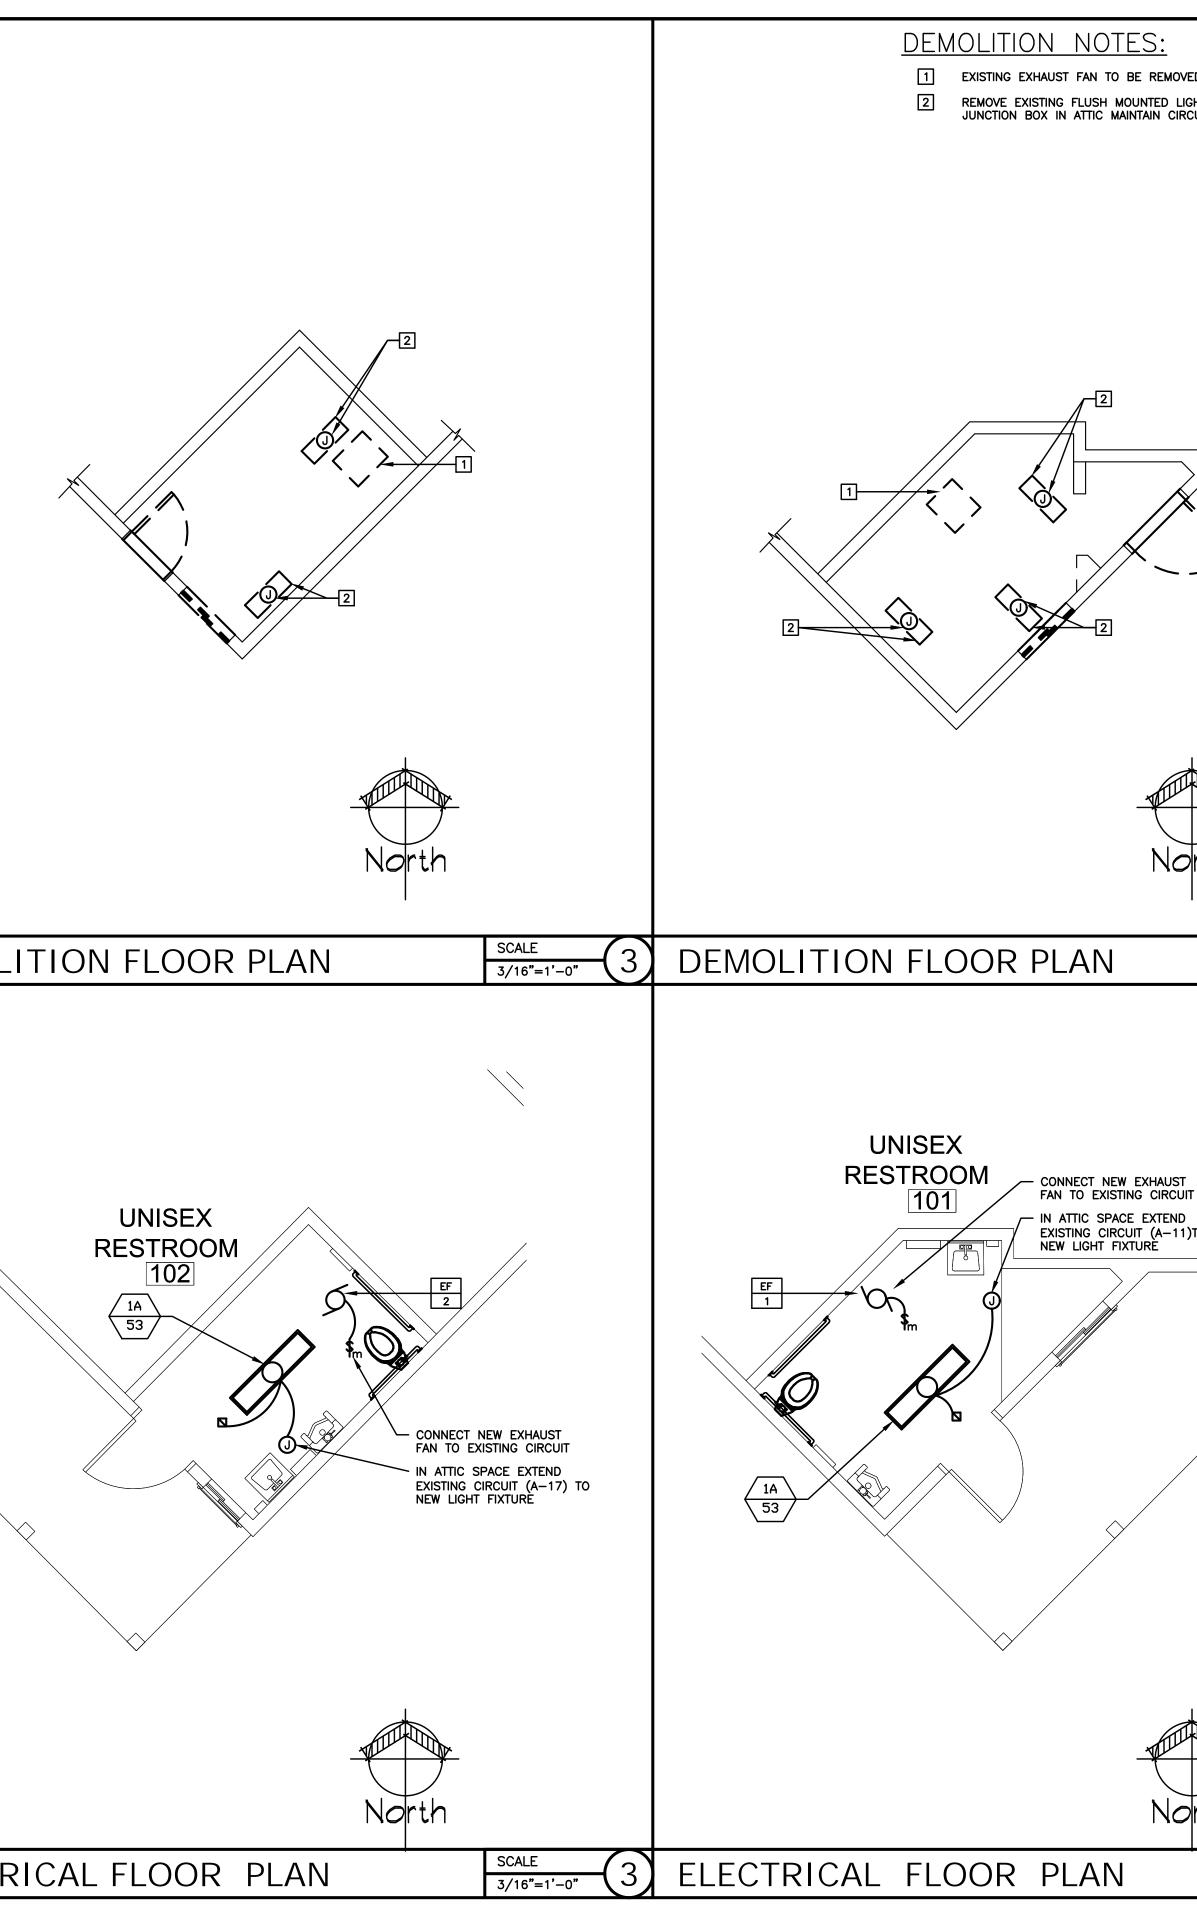

		19			
		PLANT	ING LEG	SEND:	
Ó	PLANTING SPECIFICATIONS PRIOR TO EXCAVATING OR BORING, NOTIFY DIG ALERT TO FIELD MARK EXISTING	SHRUBS		_	
I 1	PRIOR TO EXCAVATING OR BORING, NOTIFY DIG ALERT TO FIELD MARK EXISTING UTILITIES. PROTECT IN PLACE, IF FIELD CONFLICT EXISTS, NOTIFY THE PUBLIC WORKS INSPECTOR. PROCEED WITH WORK ONLY AFTER NEW DIRECTIONS HAVE BEEN GIVEN BY THE PUBLIC WORKS INSPECTOR.		COMMON NAME Strelitzia Re		SIZE
2	EXCAVATE PLANT HOLE TO SIZE AND DEPTH SHOWN.		Bird of Para		5 ga
3	EXCAVATE AND CONSTRUCT DRAINAGE SUMP PER TREE/PAUM SUMP STANDARD	\otimes	Dieties Bicol Fortnight Lil		5 ga
~	FLAN NG. 716	\bullet	Rhaphiolepi	s Indica orn "Ballerina"	5 ga
(\mathbf{f})	TO ANOTHER 2' LONG X 2' WIDE FIELE OF DEEP ROOF DARREN PANELING TO ANOTHER 2' LONG X 2' WIDE FIELE WITH THE MANUFACTURERS JOINER STRIP TO FORM ONE CONTINUOUS 10' LENGTH, DEND 10 " LENGTH OF ROOT BARRIER	GROUND		on Danenna	
	TOSETHER INTO CONFIGURATION AS SHOWN AROUND ROOTBALL AND CONNECT ENDS			E	SIZE
	EDCE OF CONCRETE PAYING. DO NOT USE ROOT BARRIER WITH PALMS UNLESS		Rosmarinus	'Huntington Carpet'	1 GA
6	INSTALL 6" PERFORATED ABS. PLASTIC SOR 35 DRAIN PIPE IN ALTERNATE CORNERS		Trailing Rose	emary	
	VERTICALLY AND FILL WITH 3/4" ORUSHED DRAIN ROCK. PERFORATIONS SHALL BE A MINIMUM OF 1/2" IN DIAMETER IN THREE LOCATIONS AROUND THE CIDELINGEGENICE		Sod - To be s	selected by City	
6	FOR TREES, BACKFUL PLANT HOLE APPROXIMATELY 6" TO 12" DEEP WITH PREPARED				
0	BACKFILL AS SPECIFIED IN THE CITY OF HUNTINGTON BEACH LANDSCAPE SPECIFICATIONS. FILL THE REMAINDER OF THE HOLE WITH WATER TO SETTLE. FOR PALMS, BACKFILL WITH PURE CLEAN COARSE SAND. COMPACT SAND WITH A		Install 2" laye	er of mulch in all pla	nting areas - n
	FOR MALMS, BACKFILL WITH PURE CLEAN COARSE SAND. COMPACT SAND WITH A "BUSHWACKER" AND WATER TO CREATE A SOUD BASE FOR THE PALM.		 Limit of Work Intractor is responsed. 	onsible for all quantiti	es
Ø	AFTER BACKFUL HAS SUFFICIENTLY SETTLED AND DRIED AS DIRECTED BY THE PUBLIC WORKS INSPECTOR, INSTALL THE TREE ROOTBALL WITH THE TOP LEVEL AND			-	
	1" ABOVE THE BOTTOM OF THE ADJACENT SIDEWALK. FOR PALMS, BACKFILL WITH				
Â	SATISFACTION OF THE PUBLIC WORKS INSPECTOR.	158	SV2		
(8)	TO SETTLE				
9	STAKE TREE PER STANDARD PLAN NO. 714. ALL PALMS IN MEDIAN ISLANDS AND PALMS WITH 10' OF BROWN TRUNK OR GREATER TO BE STAKE ANCHORED WITH		SPH.		
	PALM QUAD PODS PER STANDARD PLAN NO. 713. PALMS WITH LESS THAN 10" OF DROWN TRUCK AND NOT IN MEDIAN ISLANDS SHALL BE STAKED WITH A 10" LONG,		No.		
	2. DIAMBLER COMPLEX NAMIANAIL INLATED LODGE POLE PINE STAKE, DRIVEN A MINIMUM OF 3' INTO THE CROUND AND 12" BELOW THE BOTTOM OF THE PLANT HOLE. THE TO PAILIN WITH "OPA-STRAIDUR" DILBERO THE THE COAT TO TO THE		N. DICE		
	SIZE AS REQUIRED TO ENGINALE STAKE AND PALM LOOSELY. ATTACH TO STAKE				
	PROTECTOR SUCH AS ARBORGARD OR APPROVED EQUAL.	Bird of	zia Reginae f <i>Paradise</i>	\otimes	Dieties Bicolor Fortnight Lily
A	ARTERIAL PALM/TREEWELL PLANTING SPECIFICATIONS				
APPR	OVED CITY OF HUNTINGTON BEACH STANDARD			1244 Martin	
J <u>.</u>	DEPARTMENT OF PUBLIC WORKS 715 2013 3 OF 4	A STATE	Stre V	SALAN	
				No employ	
	SPECIFICATION STD. PLN. 715 4				ly,
			Rosmarinus 'H <i>Trailing Rosen</i>	luntington Carpet' nary	
				NG LEO	GENL
		n 5 6 7	• • •		
	RI ANTINO ODEOIEIOATIONO OONTINUED	C			
	PLANTING SPECIFICATIONS CONTINUED		ALL PLANTINGS MU ANSI A300 PART I REFERENCE SECTIO	ST FOLLOW B. GREEN BOOK	Ha.
					N.
C	AFTER BACKFILL HAS SUFFICIENTLY SETTLED AND DRIED, BRING BACKFILL TO GRADE SHOWN.			o percolate upon initial L have	<u>I</u>
	PRIOR TO DELIVERY, AUL TREES, INCLUDING PALMS, PLANTS, SHRUBS, ETC. SHALL BE APPROVED BY THE CITY.	5	N TREE.	TO PER	6
	STALL DE APPRUNEU BY IME GILY:		easin shrue or te see standard 714	ECTLY SHAL	
(B)	NOTE: WHEN PLANTING TREES ON STATE HICHWAYS REFER TO STATE DIVISION OF HICHWAYS LANDSGAPING SPECIFICATIONS AS WELL AS CITY SPECIFICATIONS.		STAN	(NOT AROUND TRUNK FLARE) ALL PITS WITH WATER AND ALLOW THOROUCHLY WATERED IN DIRECTLY INURSERY STOCK AND SHAI ND IQULTIXARS OF EACH.	W
	O ONE-HUNDRED (100) FEET BACK OF BECINNING OURB RETURNS ON		ER BAS	RUNK (Viered Viered Viered Feach Fioc	
	(2) TWENTY FIVE (25) FEET BACK OF BEGINNING OURD RETURNS AT		CATTON	WITH WATE WITH WATE URSERY JARS OF JEFTH	
	- INTERSECTIONS.		SPECIFI	OT AR SROUG CULTIN	Ð
	(3) FIFTEEN (15) FEET FROM LICHT STANDARDS.		WATER BASIN 5" MINIMUM DEPTH BEHIND OR AROUND TREEWELL/WATER BASIN SHR BACKFILL PER CITY OF HUNTINGTON BEACH LANDSCARE SPECIFICATIONS, SEE STAND SCARFY SIDESI AND BOTTOM OF PLANTING PIT. EXISTING 2:1 MAXIMUM SLOPE. SET TRUNK FLARE HEICHT TO %" ÅBOVE FINISH GRÅDE, UNDISTURBED MATUR SOIL UNDISTURBED MATUR SOIL SLIGHTLY SCARIET AND CUT ROOTS ALONG ROOTBALL. SLUGHL, AND MATERIAL APPROVED BY THE CITY OF HE	NC) (NC	
	() EIGHT (8) FEET FROM FIRE HYDRANTS.		r Arou Lands T. T. Ish Gr Votball The Ci	D PLA	EVEL ARE/
	(6) SIX (6) FEET FROM WATER METERS. (IN THE INTEREST OF PUBLIC SAFETY		IND OF EACH I TING P. VE FIN NG RO	PROVE KFILL IL BE NUS, S	5 N
	OR WHEN THERE IS A VARIATION IN THE LOCATION OF TREES, AS	TREES	H BEH TON B PLAN R ABO TS ALC	ER AP	
	CHECKED AND MAY BE MODIFIED DY THE PARK, TREE AND LANDSCAPE		T TO STATE	LICH (F INT AN INT AN INT AN ENTIFIC	N. 9 🐔
		S CHRI	A DE BOTT DE BOTT DE BOTT DE BOTT NUM SI HETCHA NUM SI NUM	IP MU PLAN IS RUA IS 2 IS 2 IS 2 IS 2 IS 2 IS 2 IS 2 IS 2	
		ROXED	N 5" W R CUTY ES ANC MAXIN MAXIN MAXIN MAXIN MAXIN N MATIN N MATIN N MATIN N MATIN	37" THICK WOOD CHIP MULCH (FER APPROVED PLANS) NOTE: FRIOR TO FLANT OR TREE PLACEMENT, FILL INTO THE SUBGRADE. FLANT AND BACKFILL MUST BE FLANTING. ALL PLANTS & TREES SHALL BE GRADE "A PLANT TAGS (LABELS) IDENTIFYING GENUS, SPECIES A REPTH OF ROOTBALL	
			RUNK - RONK - VICE	ICK WO THE SU ING, AI OF TAGS	
			WATE BACKE SCARI S	-3" THI NOTE: INTO T PLANT PLANT	
		e			je d
				9 SLOPE A	REAS
			5 2 8		
-	ARTERIAL PALM/TREEWELL PLANTING SPECIFICATIONS			SHRU	ib plantin
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			PPROVED:	t A	CITY OF
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APPRO	OVED: CITY OF HUNTINGTON BEACH DEPARTMENT OF PUBLIC WORKS 2013 OTH ENGINEER STANDARD PLAN 715 4 OF 4				DEPART
rgro	OVED: CITY OF HUNTINGTON BEACH STANDARD DEPARTMENT OF PUBLIC WORKS 715 715 2013 2013 4 OF 4 715 SPECIFICATION STD. PLN. 715 5 ound Service Alert REVISIONS		RUB		DEPART
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GIZE SPACING WUCOLS IV DETAIL QUANTITY is gal. 4' MED $3,4,85$ 28 ea. .4 is gal. 3' MED $3,4,85$ 9 ea. .4 is gal. 3' LOW $3,4,85$ 36 ea. .2	32 0 to 12 th Street
GIZE SPACING WUCOLS IV DETAIL QUANTITY GAL 4' LOW 3,4,&5 37 ea. .2 (590 s.f.) 1,575 s.f. Bid Alt.#1 - 290 s.f.	LANDSCAPE MH
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ZX WIDTH OF ROOTBALL	35.00 LANDSCAPE
TING DF HUNTINGTON BEACH ARTMENT OF PUBLIC WORKS 2013 1 OF 1	Tener 36.00 11 th Street
STD. PLN. 712 3	
REFERENCES	PREPARED UNDER THE SUPERVISION OF: TERRY EVANS R.A. NO.: C33095 EXP. DATE: 11-30-2021 APPROVED BY:
	DRAWN BY: CHRIS TANIO, PRINCIPAL C.E. DATE DESIGNED BY: CHRIS TANIO, PRINCIPAL C.E. DATE CHECKED BY: R.C.E. No: C82756 Exp. Date: 09/30/22



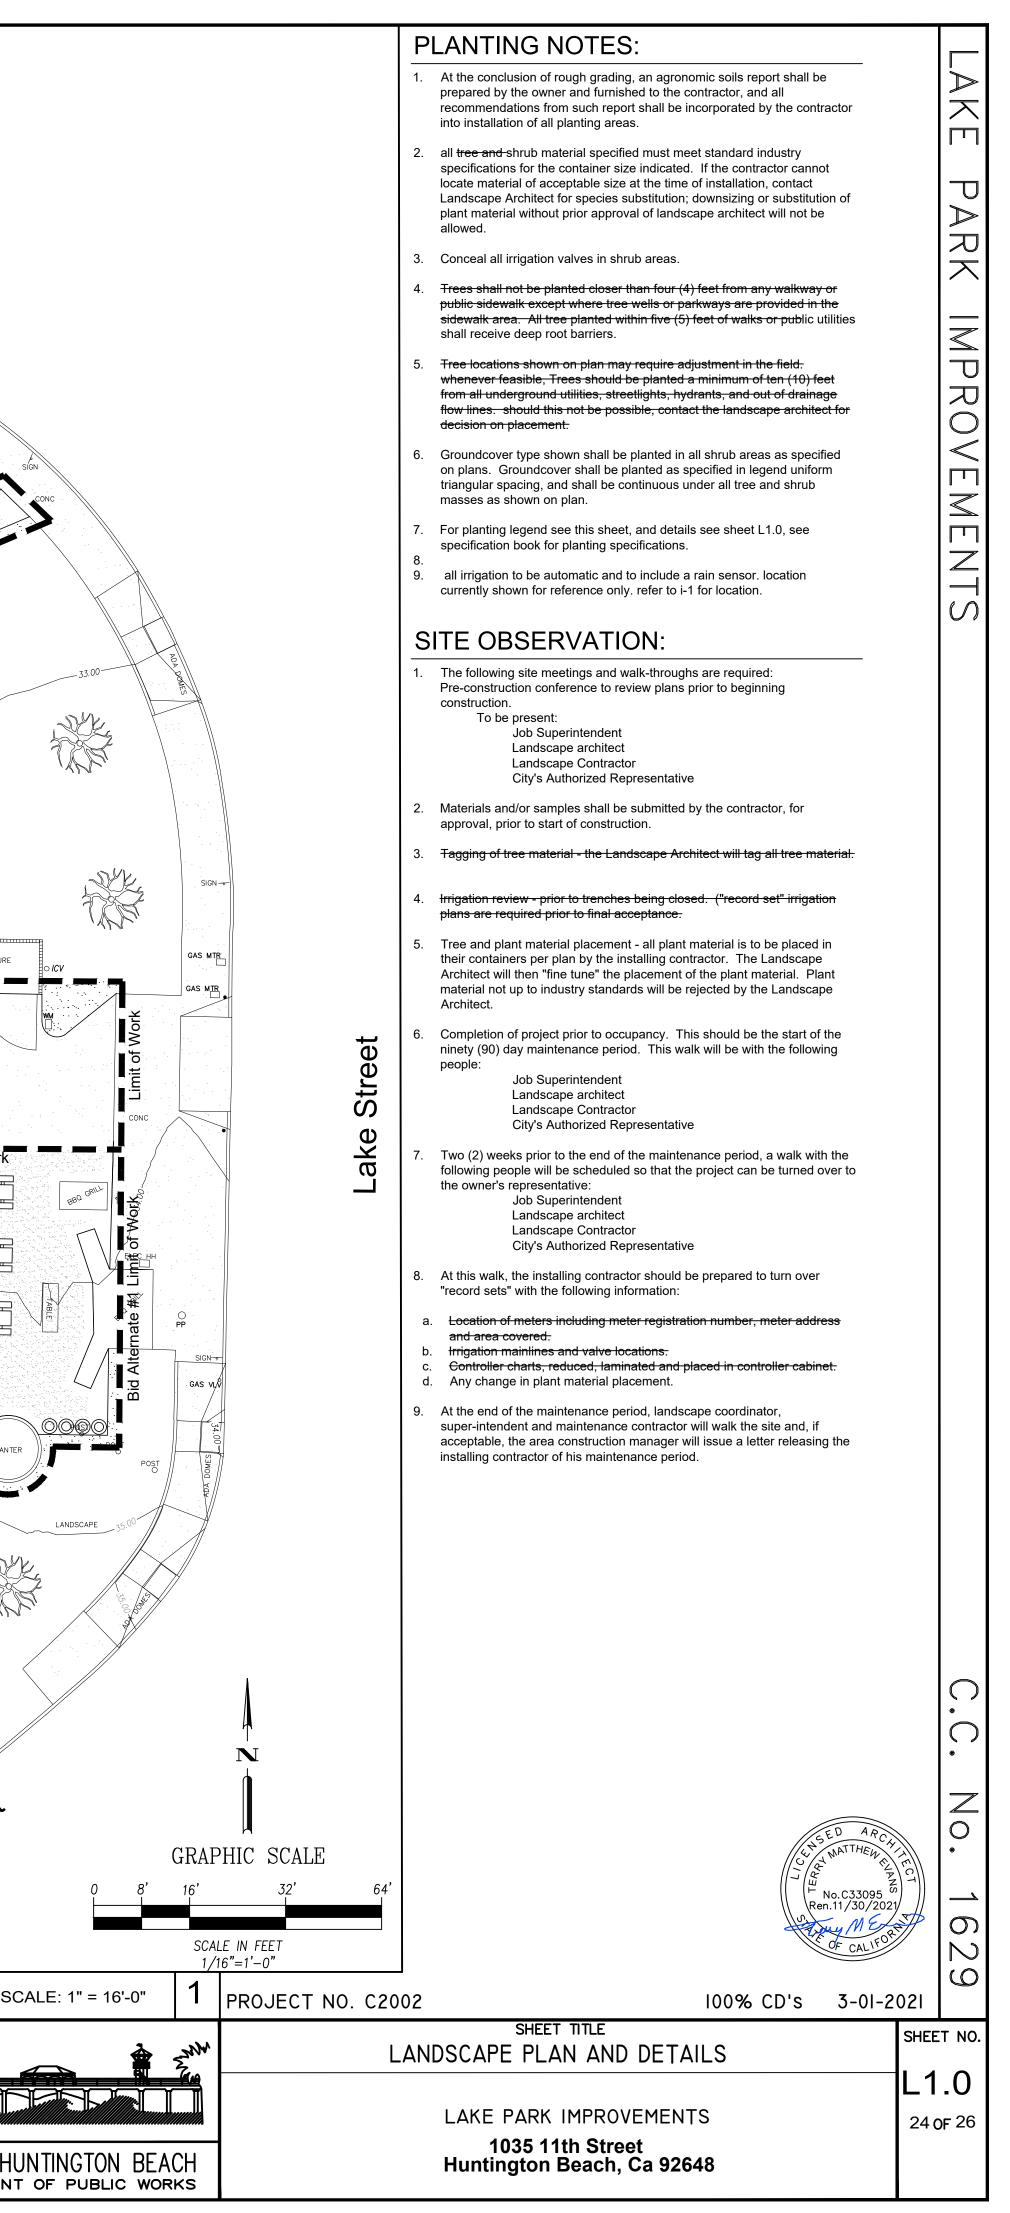
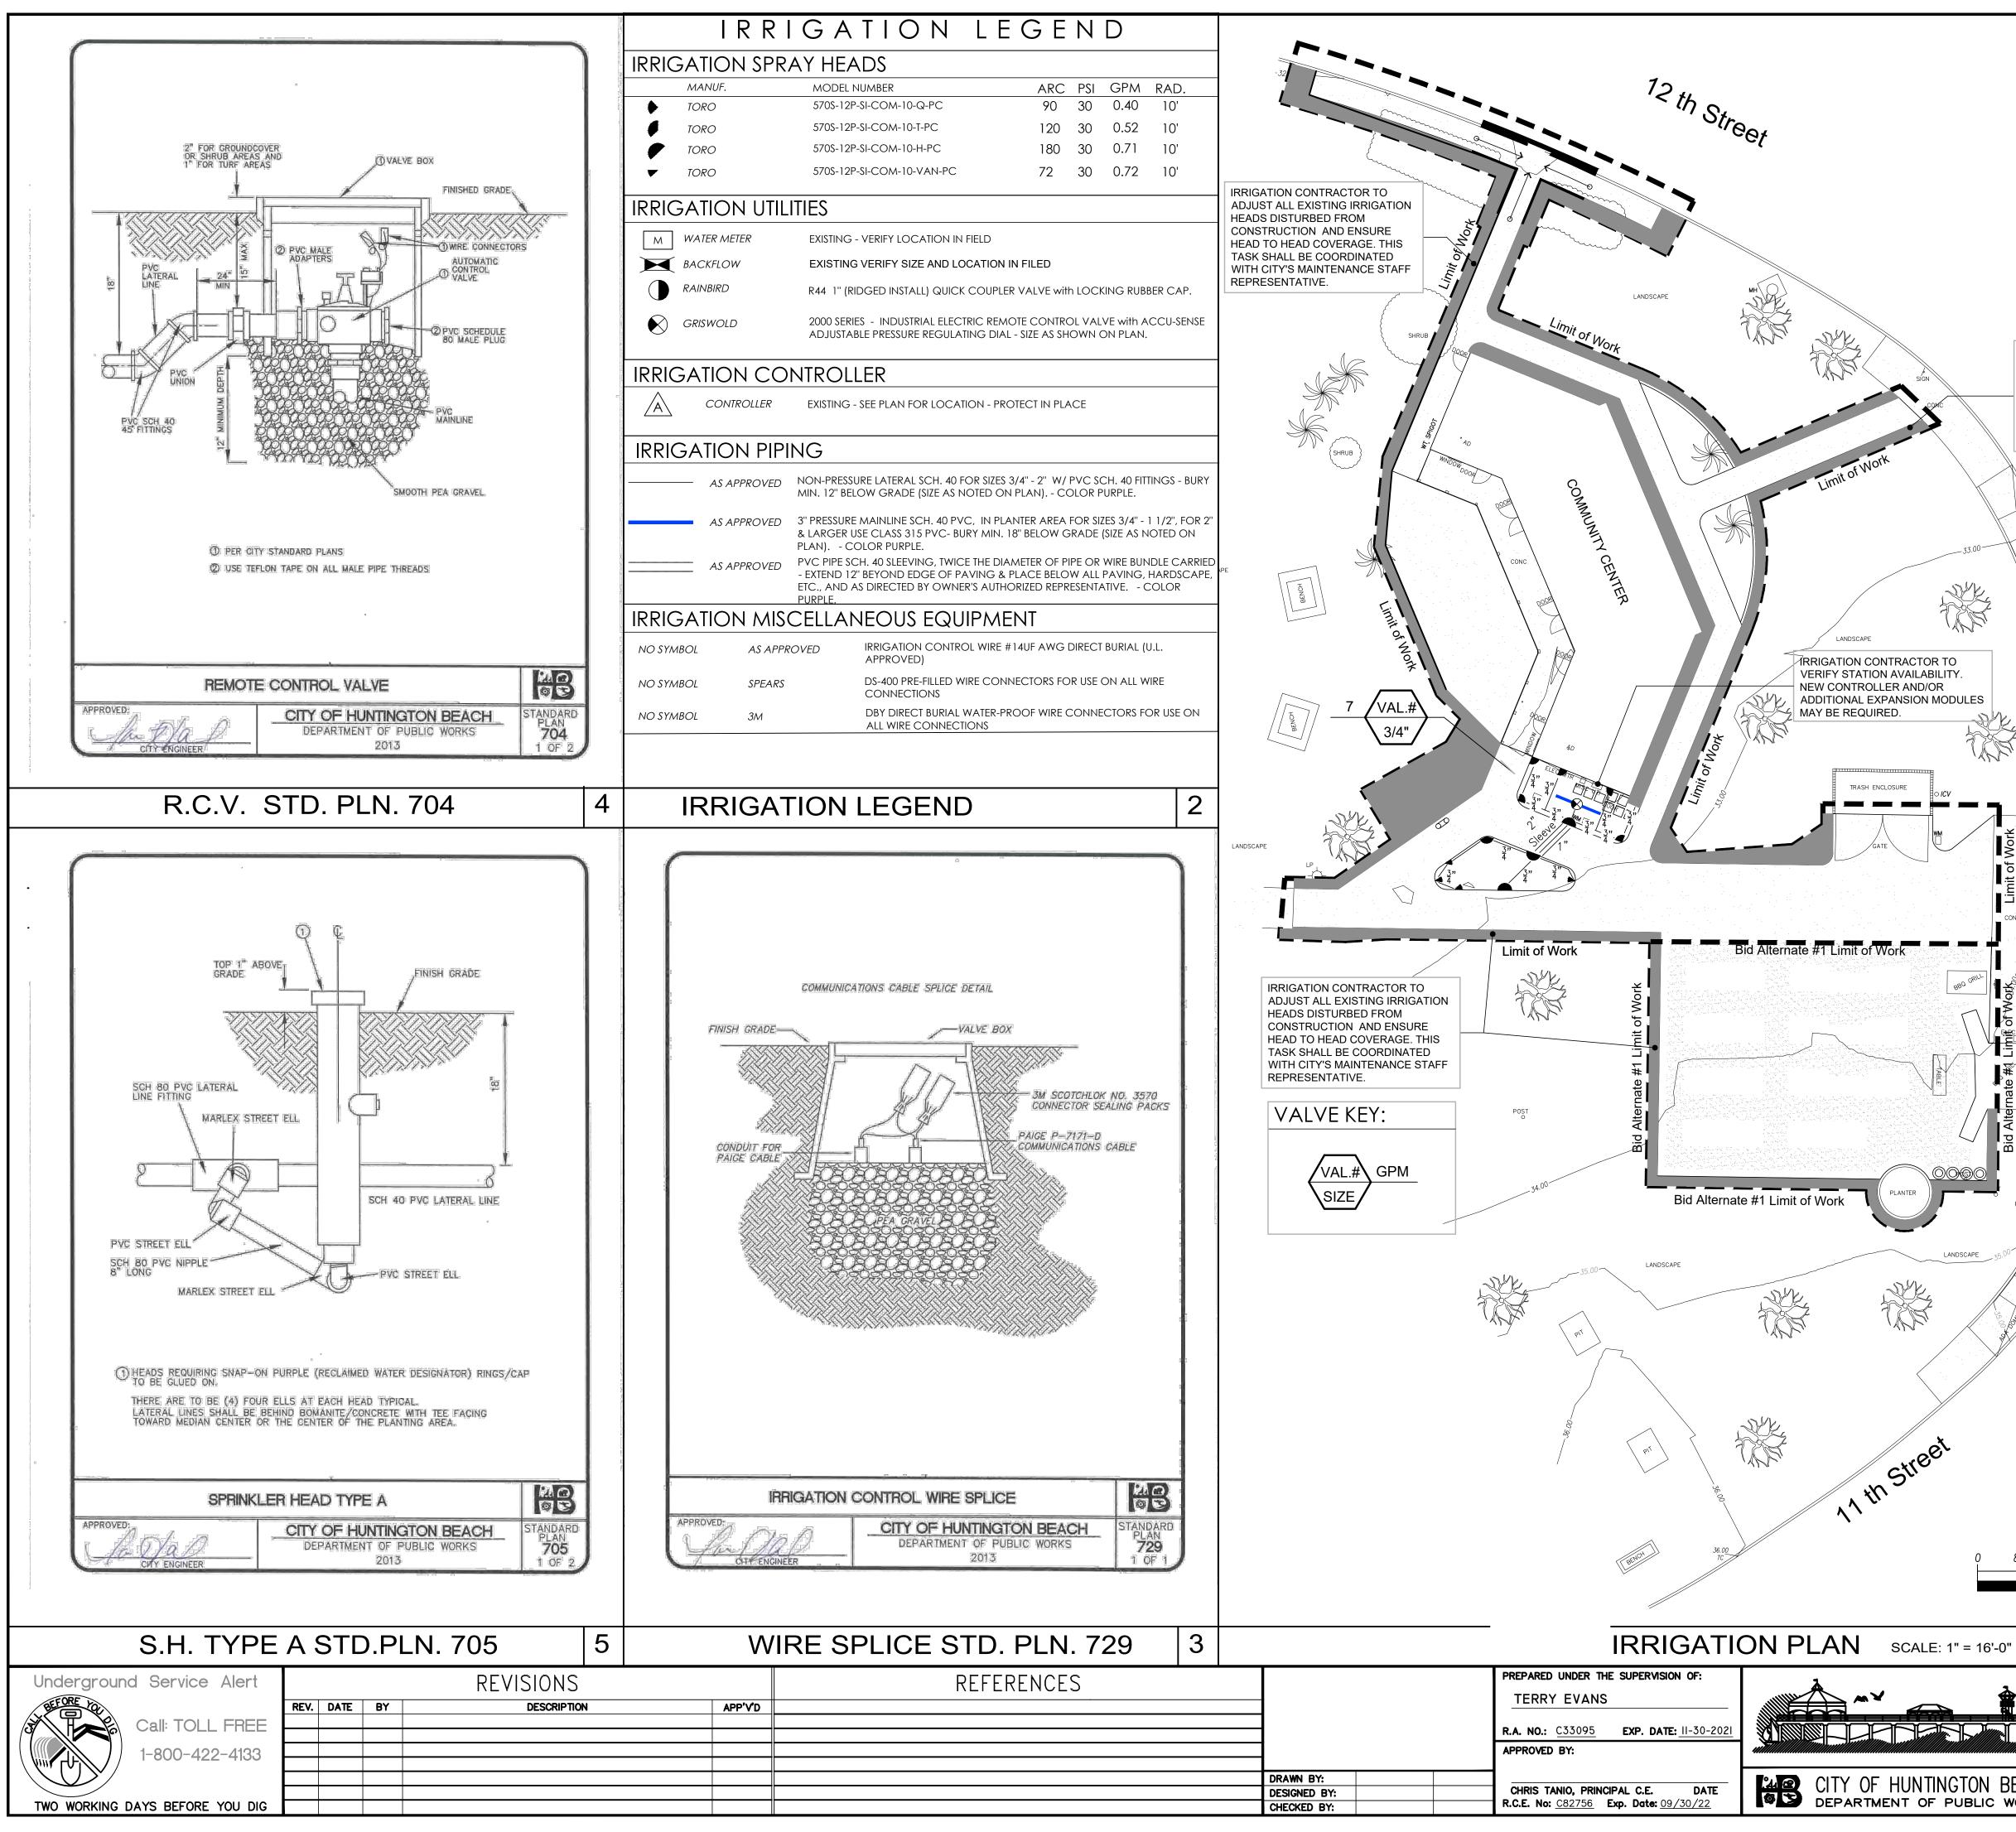
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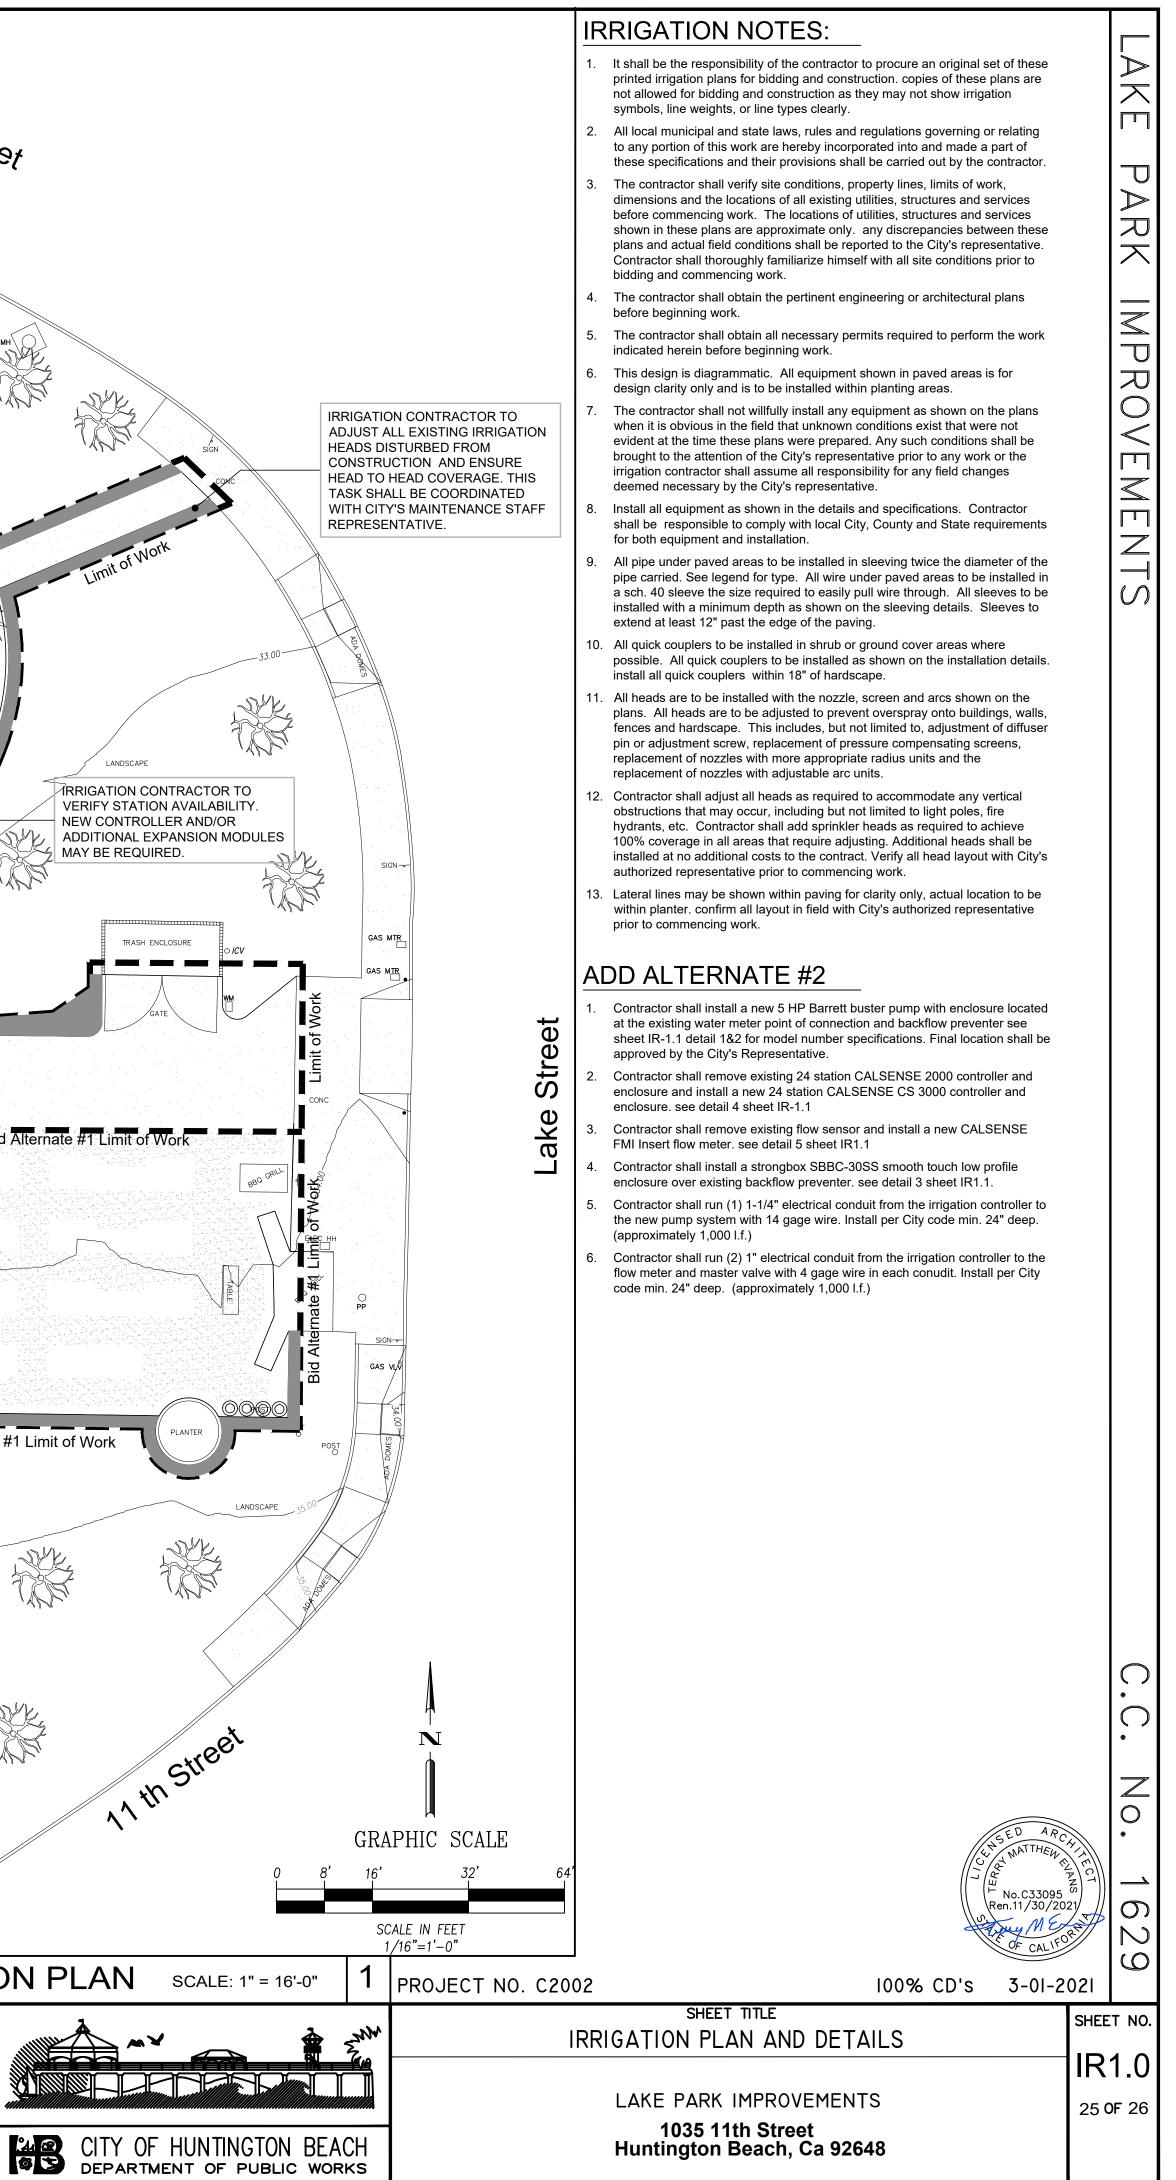
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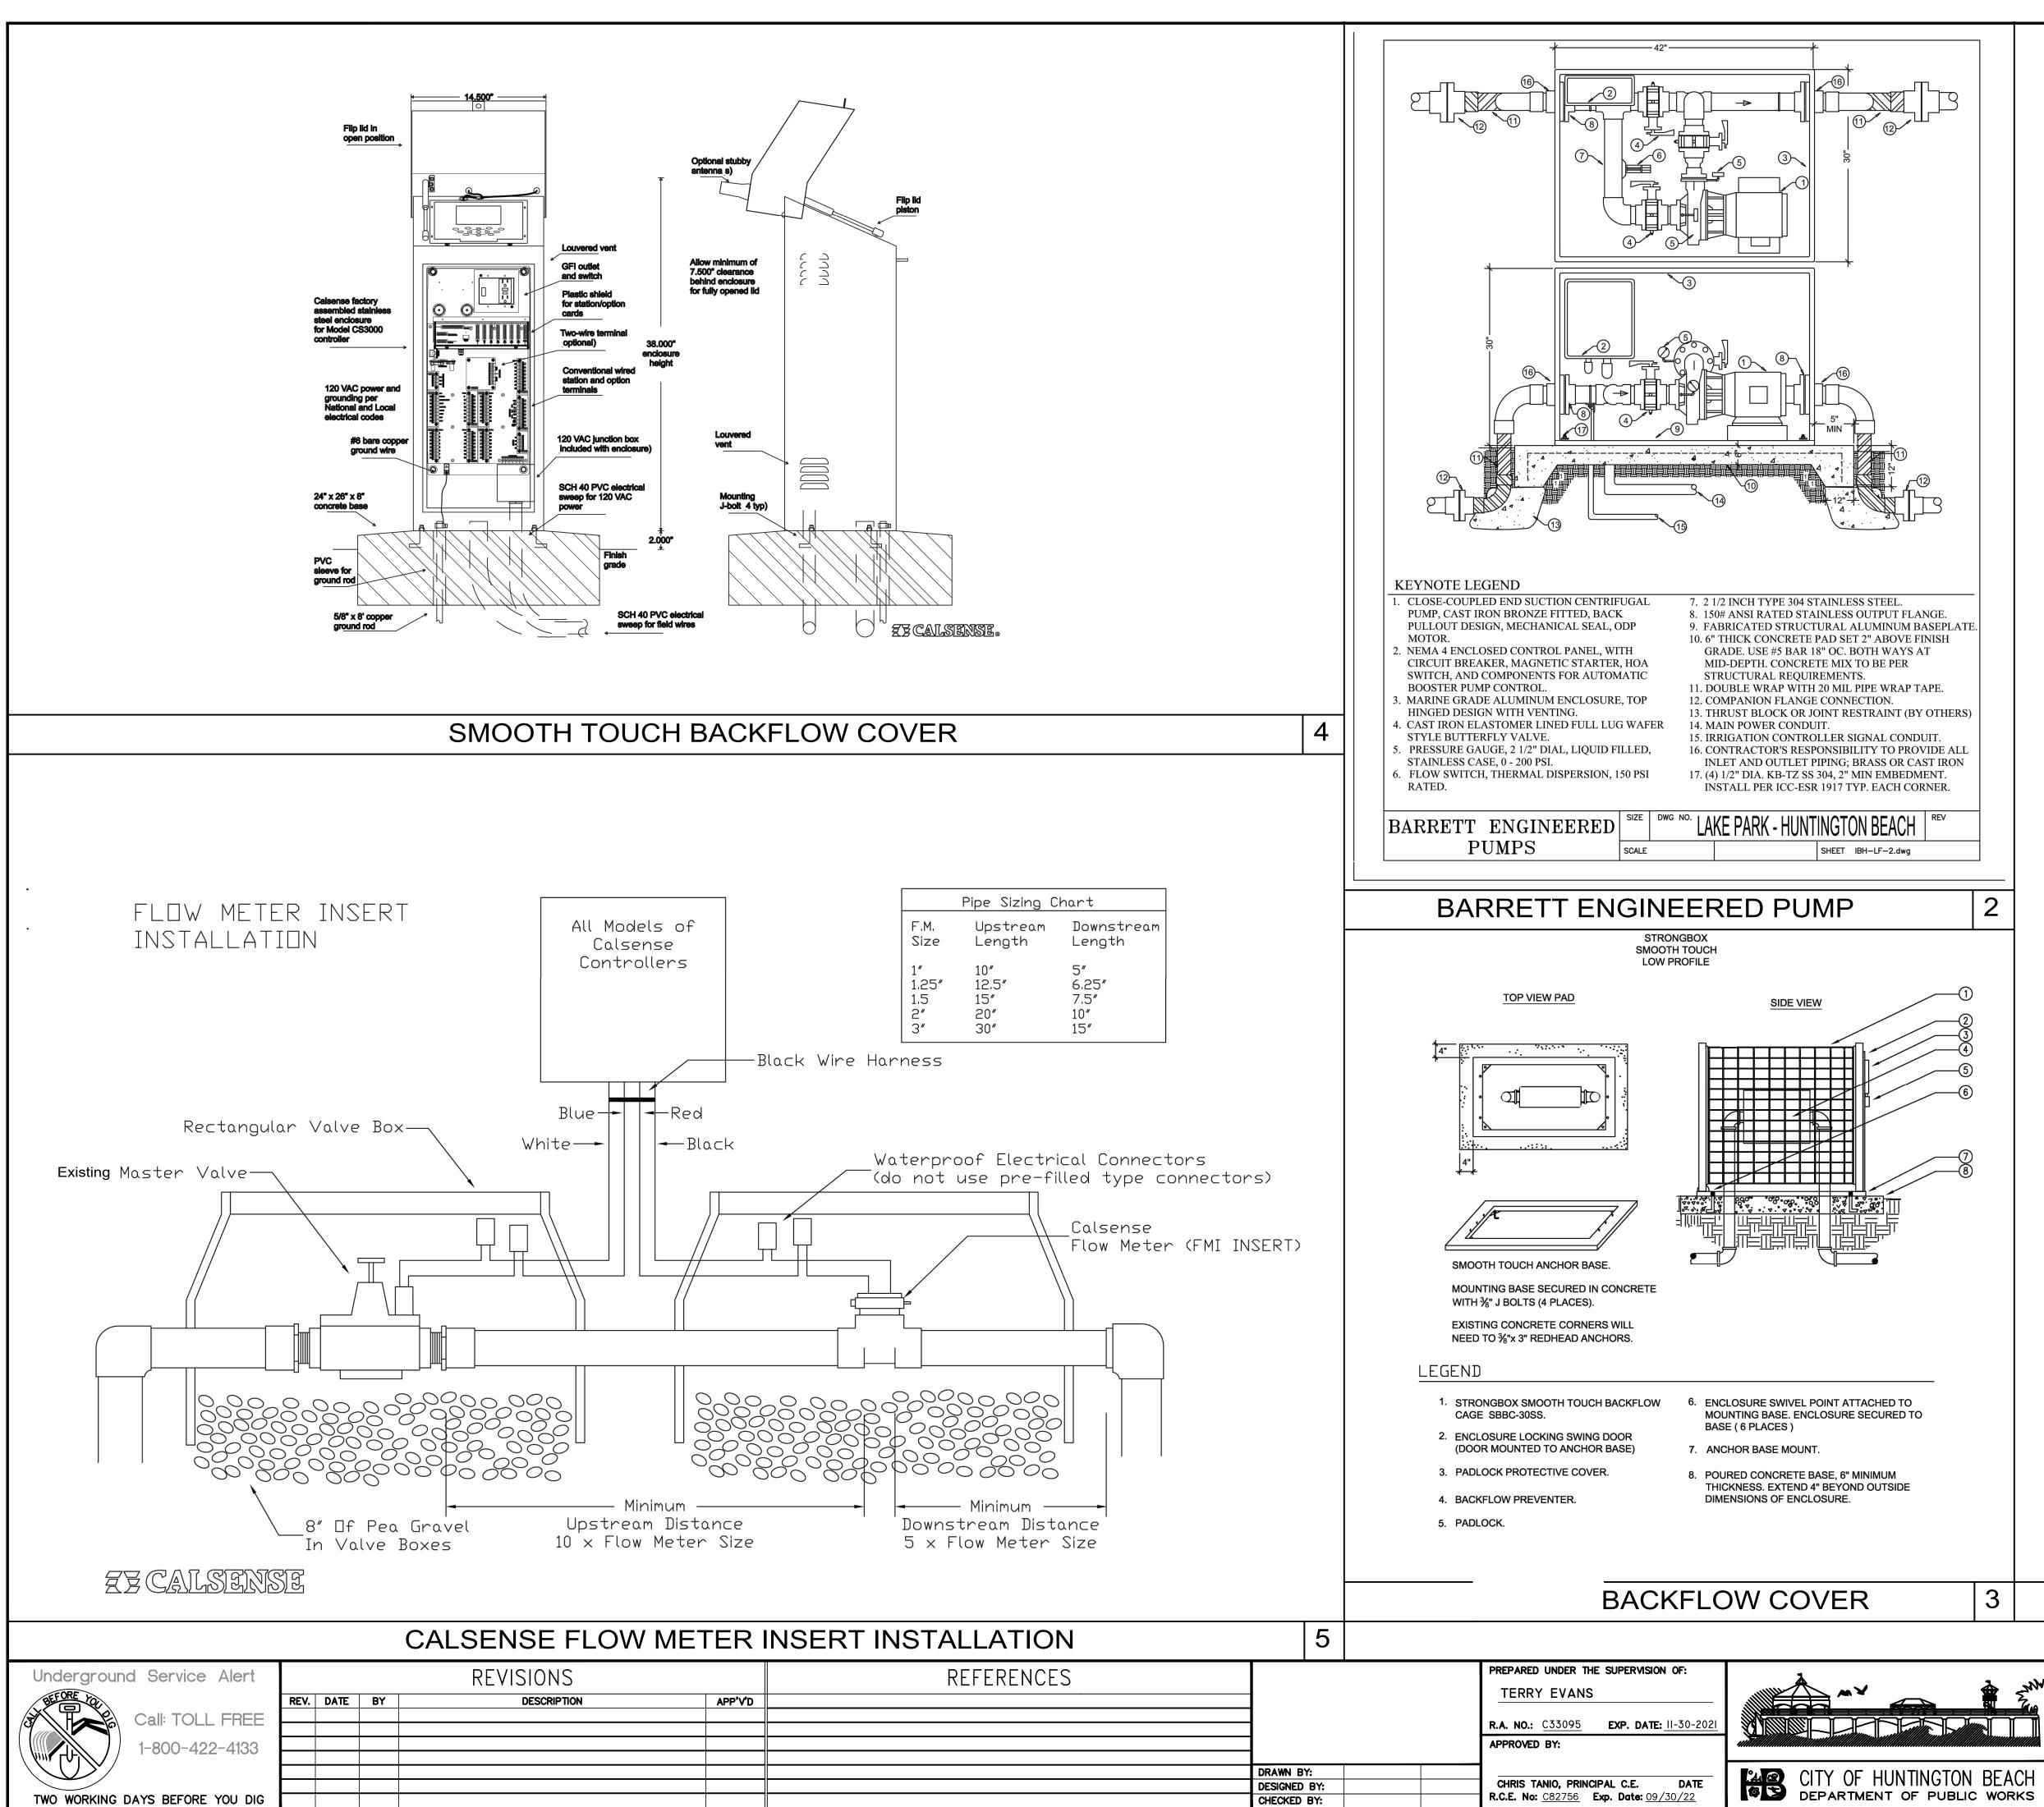
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LANDSCAPE

MAY BE REQUIRED.

TRASH ENCLOSURE





	BARRETT ENGINEERED PUMPS Specialists in pumps and pumping systems	LAKE
EL. UT FLANGE. NUM BASEPLATE. BOVE FINISH VAP TAPE. NIT (BY OTHERS) CONDUIT. O PROVIDE ALL OR CAST IRON MBEDMENT. CH REV -2.dwg 2 2 2 2 2 3 4 5 6 7 8	<text><section-header><section-header><section-header><section-header><section-header><list-item><list-item><list-item><list-item><list-item><list-item><list-item><list-item><list-item><list-item><list-item><list-item><list-item><list-item><list-item><list-item><list-item><list-item><list-item><list-item><list-item><list-item><list-item><list-item><list-item><list-item></list-item></list-item></list-item></list-item></list-item></list-item></list-item></list-item></list-item></list-item></list-item></list-item></list-item></list-item></list-item></list-item></list-item></list-item></list-item></list-item></list-item></list-item></list-item></list-item></list-item></list-item></section-header></section-header></section-header></section-header></section-header></text>	PARK IMPROVEMENTS
ED TO RED TO JM "SIDE	SED ARC V SED ARC V SED ARC NATTHEW NATTHEW NO.C33095 Ren.11/30/2021 OF CALIFORM	C.C. No.
3	BOOSTER PUMP ASSEMBLY	1 1 9
	PROJECT NO. C2002 I00% CD's 3-01-20 SHEET TITLE	021
A ANN	IRRIGATION PUMP DETAILS	SHEET NO.
UNTINGTON BEACH	LAKE PARK IMPROVEMENTS 1035 11th Street Huntington Beach, Ca 92648	IR1.1 26 OF 26