

\ EAST ELEVATION

COMPOSITION SHINGLE ROOF BY: GAF ROOFING 'TIMBERLINE 40' ICC-ES **ESR-1475 OR EQUAL EXTERIOR PLASTER** WITH CONTROL 9 SHOWER <12> DORMER _____ SLIDING WINDOW CONTROL JOINT (26) TRASH BIN FLOOR LINE TRIM 32 WOODEN STAIRS OCCURS,SEE SHEET 2X BLOCKING

ELEVATIONS & SECTIONS KEY NOTES (1) STANDING SEAM METAL (50) DRYER VENT

(51) -42" HIGH FENCE (OPTIONAL FUTURE A.C. CONDENSER CONNECTION COVER PLATE

(53) PROPERTY LINE

STORAGE ARE PROVIDE

ENCLOSED USABLE SPACE

REQUIRES 1 LAYER OF 1 /2"

GYP. BOARD ON ENCLOSED

SHELF BRACE AS NECESSARY

UNDER STAIRWAY

SIDE. (CRC R 302.7)

6X12 MIN BEAM, SEE

FIXTURE BY ELECTRIC

WHERE THE OPENING OF

LOCATED MORE THAN 72"

ABOVE FIN. GRADE, THE LOWEST PART OF THE

CLEAR OPENING OF THE

SURFACE OF THE ROOM.

(61) UNIT 6" HIGH NUMBERS (4"

SEE SITE PLAN FOR

ADDRESSES.

WINDOW SHALL BE MIN. 24" ABOVE THE FIN. FLOOR

PROVIDE ADDRESS AT EACH

MIN) CONTRASTING COLOR,

NOTE: BUILDING ADDRESS

SHALL BE PROVIDED ON

THE BUILDING IN SUCH A

THE STREET PER CRC

SECTION 319.1.

62 -R21 2X6 STUD WALL

POSITION AS TO BE PLAINLY

VISIBLE AND LEGIBLE FROM

DOOR IN CLOSED POSITION. ii. GLAZING ON A WALL

PERPENDICULAR TO THE

WITHIN 24" OF THE HINGE

SIDE OF AN IN-SWINGING

iii. ALL GLAZING WITHIN 36"

OF THE WALKING SURFACE

LANDINGS AND ANY GLAZING

LESS THAN 36" ABOVE THE WALKING SURFACE WITHIN

60" HORIZONTALLY OF THE

BOTTOM TREAD OF A

(70) RECESS TRIM BOARD OVER

73 5 FT WIDE OPEN TRELLIS

aspectLED, AL-SC-UD,

EXTERIOR WALL SCONE, BY

WOODEN FENCE & GATE

AC UNIT BEYOND SHOWN

STAIRWAY.

67 14X TRIM BOARD

65 DUTCH DOOR

66 LATTICE

(68) 14X36 TRIM

69 7X18 TRIM

2X3 STUD

⟨71⟩ MEDALLION

⟨72⟩ Z-FLASHING

PLANE OF DOOR IN A CLOSED POSITION AND

OF STAIRWAY AND

DOOR.

OPERABLE WINDOW IS

(60) THE SILL PORTION OF AN

-BARN LIGHT OR EQUAL

STRUCTURAL

59 GOOSE NECK LIGHT

(54) FAUX COLUMNS JOINTS PER CODE SECTIONAL OVERHEAD 7.75" MAX THRESHOLD HT. @ GARAGE DOOR

GARAGE DOOR SURFACE MTD LIGHT FIXTURE

56 -2.5' X 5' X 16' = 200 C.F. METAL GUTTER (OPTIONAL) √7 > —12X30 TRIM W/ LIGHT ——

(8) -SKYLIGHT ---

ENTRY DOOR, 3'-0" X 8'-0" THERMA-TRU FIBERGLASS DOOR WITH 6" WIDE ENTRY DOOR TRIM

FRENCH DOOR

<13⟩ WINDOW TRIM

(14) 2 x 6 RAKE FASCIA, TYP.

6X8 TRELLIS AND PROTECTING BEAM

<16 METAL DOWNSPOUT (17) BATTEN BOARD SIDING

(18) WOOD TRIM

(19) KNEE BRACE WINDOW - SINGLE

HUNG

<22> SLIDING DOORS

<23 METAL FLASHING

EXTERIOR DOOR WITH LOUVER

<27 COLUMN / POST

28 1X HEADER TRIM

(OPTIONAL) 30 FIXED WINDOW

(31) WEEP SCREED

INSULATION WHERE

ROOF DIAPHRAGM

SHEATHING

4X4 HEAVY TIMBER @ 12" 0.C. ±

(37) CONCRETE FOOTING

PAINTED 5/8" TYPE 'X' GYP BD 39 6' HIGH FENCE

(40) FAUX VENT ----

VINYL WEEP PER CODE VINYL WEEP SCREED

42 12" ROOF EAVE

<43 CONCRETE SLAB

44 42" HIGH GUARDRAIL O'HAGIN'S ATTIC VENT 45 WHERE OCCURS, SEE

ROOF PLAN LINE OF 6'-0" HIGH PRIVACY FENCE

77 WOODEN TRELLIS 30" X 30" MIN ATTIC ACCESS WITH 30" MIN **HEADROOM CRC R807.1** WITH WEATHER STRIPS TO PREVENT BACK DRAFT 79 DASHED, LG LMU36CHV 80 BOLLARD

(48) KITCHEN HOOD VENT 49 WATER HEATER VENT



Neil Stanton Palmer ARCHITECTS / Jack K. Bryant ENGINEERS 2601 Airport Drive, Suite 310, Torrance, CA 90505 Telephone: (310) 326-9111 Fax: (310) 325-0271

BUILT CUSTOM HOMES, LLC (714) 587 2565

7852 RONALD DRIVE HUNTINGTON BEACH, CALIFORNIA 92647

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SUBMITTALS

| 63 | STUCCO UNDER RAKE | MARK | DATE | DESCRIPTION |
|----------------------------|---|------|------------|---------------------------|
| $\stackrel{\circ}{\wedge}$ | ALL GLAZING SHALL BE | | 07-08-2019 | INITIAL PLANNING REVIEW |
| 64 | TEMPERED (CRC R308.4) | | 07-22-2019 | PLANNING APPLICATION |
| | i. ALL GLAZING WHERE THE | | 11-26-2019 | PLANNING APP RE-SUBMITTAI |
| | NEAREST EXPOSED EDGE OF THE GLASS IS WITHIN 24" | | | |
| | OF EITHER VERTICAL EDGE | | | |
| | OF A DOOR IN PLANE OF THE | | | |

REVISIONS

| MARK | DATE | DESCRIPTION |
|------|------|-------------|
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Stamp DO NOT SCALE THE DRAWINGS. SCALES INDICATED ARE FOR RELATIVE SCALE ONLY. DIMENSIONS SHALL GOVERN OVER SCALE.

02-1124-001 Job No.: CADD File: K:\02-1124-001 7852 RONALD AVENUE\CAD\PLANNING SET\A-3 ELEVATIONS.DWG 11-01-2018 Project Start Date: VL Drawn By:


KP

MOUNTED @ 7'-6" A.F.F., AS NOTED Scale: (75) ELECTRICAL PANEL Drawing Title

Checked By:

√76 TEL & CABLE PANELS


ELEVATIONS

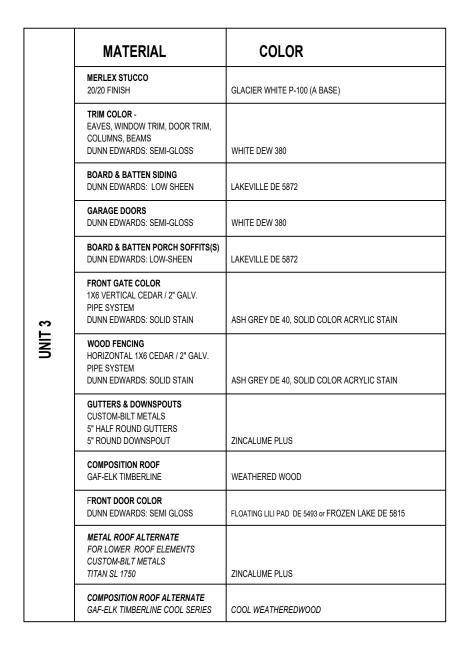

| 33 3A 38 20 53 53 55 |
|--|
| 12 8 |
| 5,75 |
| F.F. (49.80') |
| CAT.84') HIGHEST POINT AT STREET CURB 37 |


| | 33 44 2 53 53 53 |
|-------------------------|---------------------------------------|
| | |
| | 12 8 |
| F.F. (49.80') | |
| POINT AT STREET CURB | 3 UNIT 3 SECTIONS SCALE: 1/8" = 1'-0" |


| | MATERIAL | COLOR | | | |
|--------|---|--|--|--|--|
| | MERLEX STUCCO 20/20 FINISH | IRONSTONE P-810 (B BASE) | | | |
| | TRIM COLOR - EAVES, WINDOW TRIM, DOOR TRIM, COLUMNS, BEAMS DUNN EDWARDS: SEMI-GLOSS | WHITE DEW 380 | | | |
| | BOARD & BATTEN SIDING DUNN EDWARDS: LOW SHEEN | WHITE DEW 380 | | | |
| | GARAGE DOORS DUNN EDWARDS: SEMI-GLOSS | SHAGGY BARKED DEC 771 | | | |
| | BOARD & BATTEN PORCH SOFFITS(S) DUNN EDWARDS: LOW-SHEEN | WHITE DEW 380 | | | |
| .5 | FRONT GATE COLOR 1X6 VERTICAL CEDAR / 2" GALV. PIPE SYSTEM DUNN EDWARDS: SOLID STAIN | ASH GREY DE 40, SOLID COLOR ACRYLIC STAIN | | | |
| UNIT 2 | WOOD FENCING HORIZONTAL 1X6 CEDAR / 2" GALV. PIPE SYSTEM DUNN EDWARDS: SOLID STAIN | ASH GREY DE 40, SOLID COLOR ACRYLIC STAIN | | | |
| | GUTTERS & DOWNSPOUTS CUSTOM-BILT METALS 5" HALF ROUND GUTTERS 5" ROUND DOWNSPOUT | ZINCALUME PLUS | | | |
| | COMPOSITION ROOF GAF-ELK TIMBERLINE | WEATHERED WOOD | | | |
| | FRONT DOOR COLOR DUNN EDWARDS: SEMI GLOSS | ASPEN YELLOW DEC 732 or SYCAMORE STAND DEC 781 | | | |
| | METAL ROOF ALTERNATE FOR LOWER ROOF ELEMENTS CUSTOM-BILT METALS TITAN SL 1750 | ZINCALUME PLUS | | | |
| | COMPOSITION ROOF ALTERNATE GAF-ELK TIMBERLINE COOL SERIES | COOL WEATHEREDWOOD | | | |

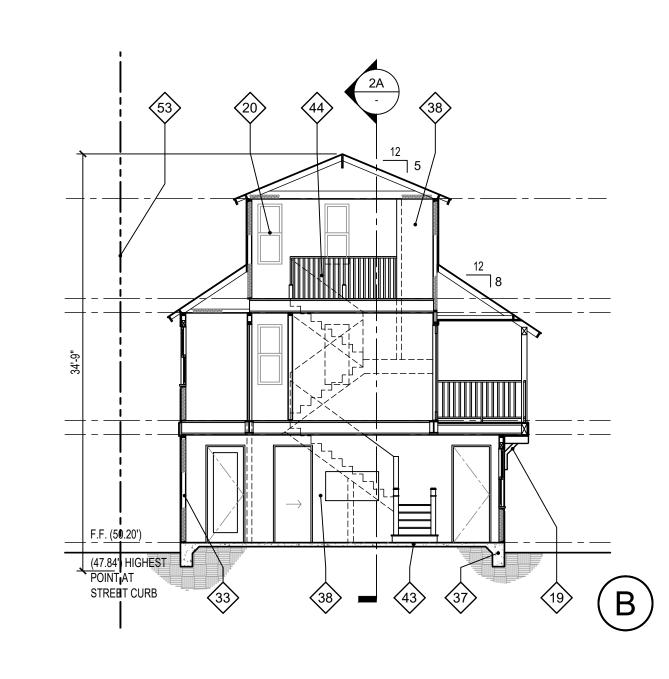

| SCALE: 1/8" = 1'-0" |
|---|
| 3 2 2 2 2 3 4 4 3 3 8 |
| |
| |
| F.F. (50.20') |
| (47.84') HIGHEST POINT AT STREET CURB |
| UNIT 2 SECTIONS SCALE: 1/8" = 1'-0" |

| | MATERIAL | COLOR |
|--------|---|---|
| | MERLEX STUCCO 20/20 FINISH | GLACIER WHITE P-100 (A BASE) |
| | TRIM COLOR - EAVES, WINDOW TRIM, DOOR TRIM, COLUMNS, BEAMS DUNN EDWARDS: SEMI-GLOSS | WHITE DEW 380 |
| | BOARD & BATTEN SIDING DUNN EDWARDS: LOW SHEEN | CANADIAN BLUE DE 6340 |
| | GARAGE DOORS DUNN EDWARDS: SEMI-GLOSS | WHITE DEW 380 |
| | BOARD & BATTEN PORCH SOFFITS(S) DUNN EDWARDS: LOW-SHEEN | CANADIAN BLUE DE 6340 |
| _ | FRONT GATE COLOR 1X6 VERTICAL CEDAR / 2" GALV. PIPE SYSTEM DUNN EDWARDS: SOLID STAIN | ASH GREY DE 40, SOLID COLOR ACRYLIC STAIN |
| UNIT 1 | WOOD FENCING HORIZONTAL 1X6 CEDAR / 2" GALV. PIPE SYSTEM DUNN EDWARDS: SOLID STAIN | ASH GREY DE 40, SOLID COLOR ACRYLIC STAIN |
| | GUTTERS & DOWNSPOUTS CUSTOM-BILT METALS 5" HALF ROUND GUTTERS 5" ROUND DOWNSPOUT | ZINCALUME PLUS |
| | COMPOSITION ROOF GAF-ELK TIMBERLINE | WEATHERED WOOD |
| | FRONT DOOR COLOR DUNN EDWARDS: SEMI GLOSS | BLACK DEA 187 or RED INK DEA 151 |
| | METAL ROOF ALTERNATE FOR LOWER ROOF ELEMENTS CUSTOM-BILT METALS TITAN SL 1750 | ZINCALUME PLUS |
| | COMPOSITION ROOF ALTERNATE GAF-ELK TIMBERLINE COOL SERIES | COOL WEATHEREDWOOD |

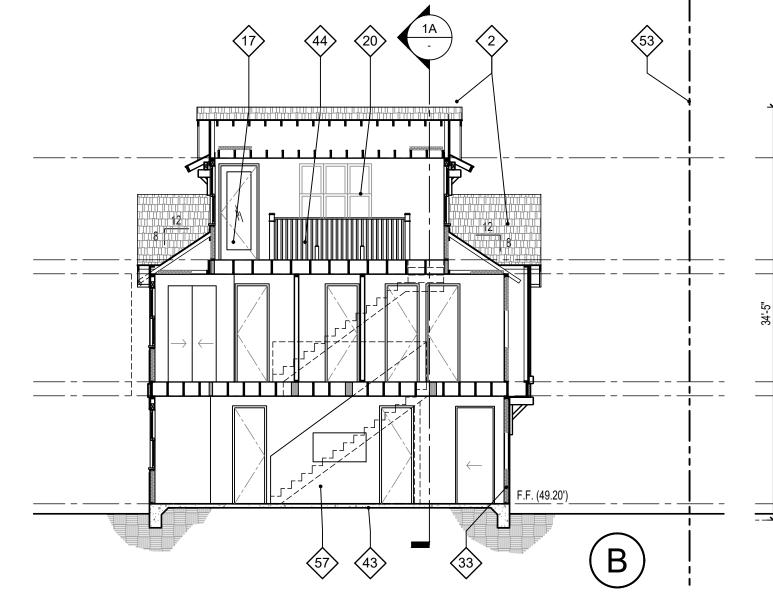

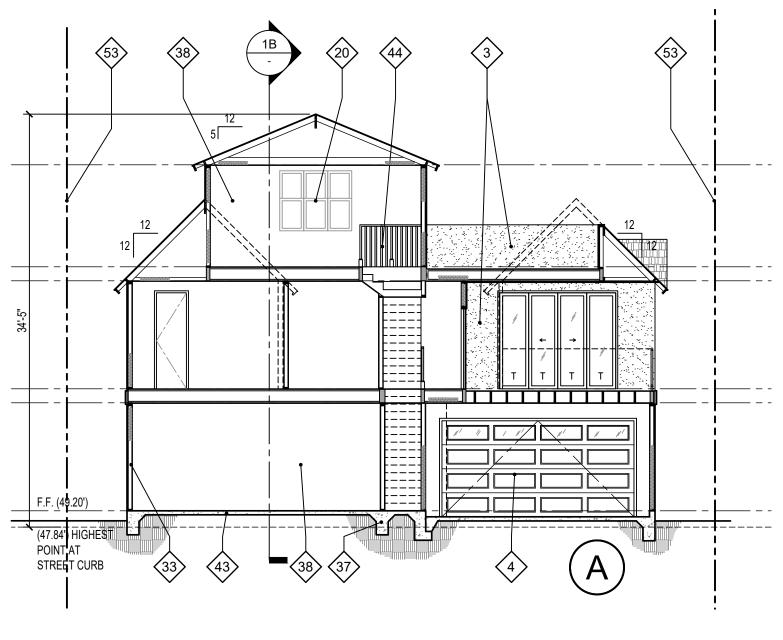

UNIT 1 SECTIONS

ELEVATIONS & SECTIONS KEY NOTES

1 STANDING SEAM METAL 50 DRYER VENT

(51) -42" HIGH FENCE (OPTIONAL **COMPOSITION SHINGLE ROOF BY: GAF ROOFING**

'TIMBERLINE 40' ICC-ES ESR-1475 OR EQUAL (53) PROPERTY LINE EXTERIOR PLASTER

WITH CONTROL JOINTS PER CODE SECTIONAL OVERHEAD

GARAGE DOOR SURFACE MTD LIGHT **FIXTURE**

METAL GUTTER (OPTIONAL) ⟨7⟩ -12X30 TRIM W/ LIGHT —

(8) -SKYLIGHT ---9 SHOWER

ENTRY DOOR, 3'-0" X 8'-0" THERMA-TRU FIBERGLASS DOOR WITH 6" WIDE ENTRY DOOR TRIM

FRENCH DOOR

<13⟩ WINDOW TRIM

<12> DORMER _____

(14) 2 x 6 RAKE FASCIA, TYP. 6X8 TRELLIS AND

PROTECTING BEAM <16 METAL DOWNSPOUT

(17) BATTEN BOARD SIDING

(18) WOOD TRIM

(19) KNEE BRACE WINDOW - SINGLE

HUNG SLIDING WINDOW

<22> SLIDING DOORS

(23) METAL FLASHING

EXTERIOR DOOR WITH LOUVER CONTROL JOINT

26 TRASH BIN

<27 COLUMN / POST

28 1X HEADER TRIM FLOOR LINE TRIM

(OPTIONAL) 30 FIXED WINDOW

31) WEEP SCREED

32 WOODEN STAIRS

INSULATION WHERE OCCURS, SEE SHEET

ROOF DIAPHRAGM SHEATHING

35 2X BLOCKING

4X4 HEAVY TIMBER @ 12" 0.C. ±

(37) CONCRETE FOOTING

PAINTED 5/8" TYPE 'X' GYP BD (39) 6' HIGH FENCE

<40> FAUX VENT ----

VINYL WEEP PER CODE VINYL WEEP SCREED

42 12" ROOF EAVE <43 CONCRETE SLAB

<44> 42" HIGH GUARDRAIL O'HAGIN'S ATTIC VENT

45 WHERE OCCURS, SEE **ROOF PLAN** LINE OF 6'-0" HIGH PRIVACY FENCE

30" X 30" MIN ATTIC ACCESS WITH 30" MIN HEADROOM CRC R807.1 WITH WEATHER STRIPS TO PREVENT BACK DRAFT 79 DASHED, LG LMU36CHV

48 KITCHEN HOOD VENT 49 WATER HEATER VENT

(54) -FAUX COLUMNS

7.75" MAX THRESHOLD HT.

-2.5' X 5' X 16' = 200 C.F.

STORAGE ARE PROVIDE

ENCLOSED USABLE SPACE

REQUIRES 1 LAYER OF 1 /2"

GYP. BOARD ON ENCLOSED

SHELF BRACE AS

UNDER STAIRWAY

SIDE. (CRC R 302.7)

6X12 MIN BEAM, SEE

BARN LIGHT OR EQUAL

LOWEST PART OF THE

CLEAR OPENING OF THE

SURFACE OF THE ROOM.

THE BUILDING IN SUCH A

THE STREET PER CRC

POSITION AS TO BE PLAINLY

VISIBLE AND LEGIBLE FROM

DOOR IN CLOSED POSITION. ii. GLAZING ON A WALL

PERPENDICULAR TO THE

ADDRESSES.

SECTION 319.1.

WINDOW SHALL BE MIN. 24" ABOVE THE FIN. FLOOR

STRUCTURAL

(59) -GOOSE NECK LIGHT

-NECESSARY --

@ GARAGE DOOR

FUTURE A.C. CONDENSER

CONNECTION COVER PLATE



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BUILT CUSTOM HOMES, LLC (714) 587 2565

-FIXTURE BY ELECTRIC

WHERE THE OPENING OF (60) THE SILL PORTION OF AN OPERABLE WINDOW IS 7852 RONALD DRIVE **LOCATED MORE THAN 72"** HUNTINGTON BEACH, CALIFORNIA ABOVE FIN. GRADE, THE

PROVIDE ADDRESS AT EACH 61 UNIT 6" HIGH NUMBERS (4" MIN) CONTRASTING COLOR, THESE DOCUMENTS ARE CONFIDENTIAL AND PROPRIETARY TO BRYANT, PALMER, SOTO, INC SEE SITE PLAN FOR AND SHALL NOT BE USED, DISCLOSED, REVISED, OR REPRODUCED IN WHOLE OR IN PART WITHOUT THE PRIOR WRITTEN CONSENT OF SAID ARCHITECT. THIS IS AN UNPUBLISHED WORK PROTECTED BY THE FEDERAL COPYRIGHT LAWS AND NO UNAUTHORIZED COPYING, ADAPTATION, NOTE: BUILDING ADDRESS DISTRIBUTION, OR DISPLAY IS PERMITTED. ALL DIMENSIONS AND CONDITIONS SHALL BE SHALL BE PROVIDED ON VERIFIED AT THE PROJECT SITE BY THE CONTRACTOR. THESE DOCUMENTS SHALL NOT BE

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| 62> | -R21 2X6 STUD WALL | SUBN | /ITTA |
|-----|--------------------|------|-------|
| | | | |

| 63 | STUCCO UNDER RAKE | MARK | DATE | DESCRIPTION |
|----|---|------|------------|--------------------------|
| | ALL GLAZING SHALL BE | | 07-08-2019 | INITIAL PLANNING REVIEW |
| 64 | TEMPERED (CRC R308.4) | | 07-22-2019 | PLANNING APPLICATION |
| | i. ALL GLAZING WHERE THE | | 11-26-2019 | PLANNING APP RE-SUBMITTA |
| | NEAREST EXPOSED EDGE OF THE GLASS IS WITHIN 24" | | | |
| | OF EITHER VERTICAL EDGE | | | |
| | OF A DOOR IN PLANE OF THE | | | |

REVISIONS

DO NOT SCALE THE DRAWINGS.

SCALES INDICATED ARE FOR RELATIVE SCALE ONLY.

DIMENSIONS SHALL GOVERN

OVER SCALE.

Project Start Date:

Job No.:

Drawn By:

Checked By:

Scale:

| PERPENDICULAR TO THE | | | |
|--|------|------|-------------|
| PLANE OF DOOR IN A CLOSED POSITION AND | MARK | DATE | DESCRIPTION |
| WITHIN 24" OF THE HINGE | | - | - |
| SIDE OF AN IN-SWINGING DOOR. | | | |
| iii. ALL GLAZING WITHIN 36" | | | |
| OF THE WALKING SURFACE | | | |
| OF STAIRWAY AND LANDINGS AND ANY GLAZING | | | |
| LESS THAN 36" ABOVE THE | | | |
| WALKING SURFACE WITHIN 60" HORIZONTALLY OF THE | | | |
| BOTTOM TREAD OF A | | | |
| STAIRWAY. | | | |
| DUTCH DOOR | | | |
| LATTICE | | | |
| | | | |

Stamp

65 DUTCH DOOR

66 LATTICE

(67) 14X TRIM BOARD (68) 14X36 TRIM

(69) 7X18 TRIM

(70) RECESS TRIM BOARD OVER 2X3 STUD ⟨71⟩ MEDALLION

⟨72⟩ Z-FLASHING ⟨73⟩ 5 FT WIDE OPEN TRELLIS

EXTERIOR WALL SCONE, BY aspectLED, AL-SC-UD, MOUNTED @ 7'-6" A.F.F.,

(75) ELECTRICAL PANEL √76 TEL & CABLE PANELS

77 WOODEN TRELLIS 78 WOODEN FENCE & GATE AC UNIT BEYOND SHOWN

Drawing Title

SECTIONS

02-1124-001


11-01-2018

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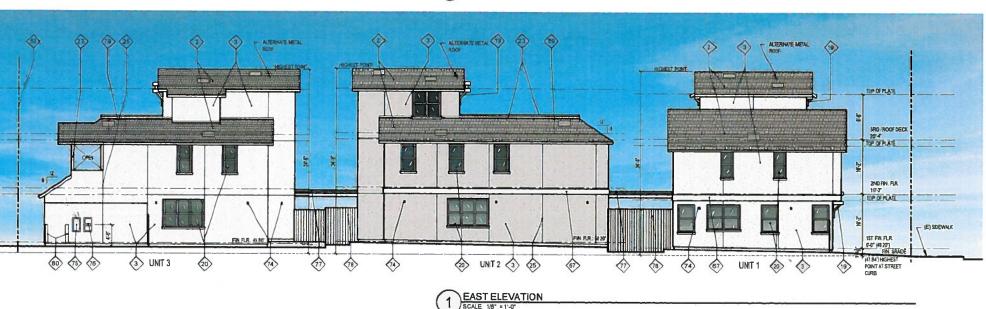
KP

AS NOTED

CADD File: K:\02-1124-001 7852 RONALD AVENUE\CAD\PLANNING SET\A-4 SECTIONS.DWG

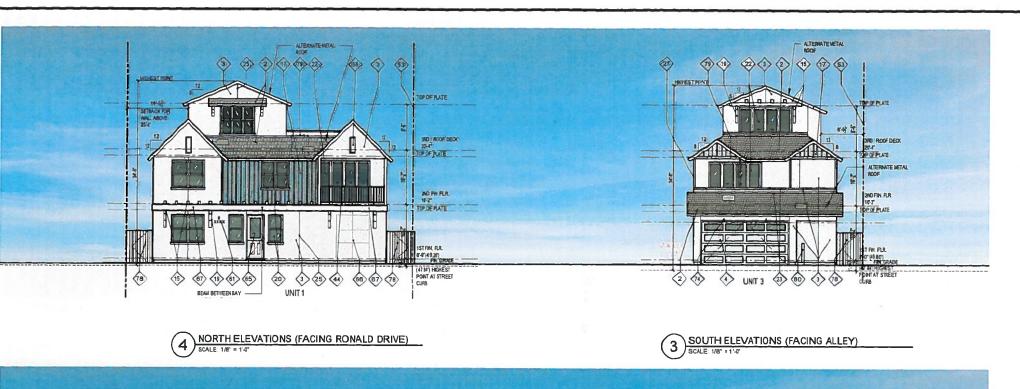

(53) (1) (23) (1) () () TOP OFPLATE SRD (ROOF DECK TOP OF MATE 2ND FIN FUR 10° OFPLATE 19 44 (1) (5) (8) (8) (8) (2) (2) (3) (7) (8) (8) (8) (4) 000 (4) (2) (9) UNIT 2 22 27> 20 25>



2 WEST ELEVATION (FACING DRIVEWAY)

ELEVATIONS & SECTIONS KEY NOTES

FUTURE A C. CONDENSER

PROPERTY LINE

@ GARAGE DOOR

SHELF BRACEAS

6X12 MIN REAM SEE

COOSE NECKLIGHT

FIXTURE BY ELECTRIC

BARNLIGHT OR EQUAL

WHERE THE OPENING OF THE SILL PORTION OF AN

LOCATED MORE THAN 72"
ABOVE FIN GRADE, THE
LOWEST PART OF THE

CLEAR OPENING OF THE WINDOW SHALL BE MIN. 24'
ABOVE THE FIN. FLOOR
SURFACE OF THE ROOM.

PROVIDE ADDRESS AT EACH UNIT 6" HIGH NUMBERS (4" MIN) CONTRASTING COLOR SEE SITE PLAN FOR

NOTE BUILDING ADDRESS

SHALL BE PROVIDED ON THE BUILDING IN SUCH A

POSITION AS TO BE PLAINL

VISIBLE AND LEGIBLE FROM

THE STREET PER CRC

STUCCO UNDER RAKE

ALL GLAZING SHALL BE TEMPERED (CRC R308.4)

I.ALL GLAZING WHERE THE NEAREST EXPOSED EDGE OF THE GLASSIS WITHIN 24

OF EITHER VERTICAL EDGE

OF A DOOR IN PLANE OF TH

DOOR IN CLOSED POSITION II.GLAZING ON A WALL PERPENDICULAR TO THE

65 DUTCH DOOR

70 RECESS TRIM BOARD OVER

73 5 FT WIDE OPEN TRELLIS

ELECTRICAL PANEL TEL & CABLE PANELS

WOODEN TRELLIS

WOODEN FENCE & GATE

EXTERIOR WALL SCONE, BY

aspectLED AL-SC-UD. MOUNTED @ 7-6" A.F.F.

66 LATTICE

68 14X36 TRIM

69 7X18 TRIM

71 MEDALLION

72 Z-FLASHING

2X3 STUD

PLANE OF DOOR IN A CLOSED POSITION AND WITHIN 24" OF THE HINGE SIDE OF AN IN-SWINGING

ADDRESSES.

62 R21 2X6 STUD WALL

63

64

OPERABLE WINDOW IS

(58)

CONNECTION COVER PLATE

7.75" MAX THRESHOLD HT.

-2.5' X 5' X 16' = 200 G.F. -STORAGE ARE PROVIDE

ENCLOSED USABLE SPACE UNDER STAIRWAY REQUIRES 1 LAYER OF 1 /2"

GYP BOARD ON ENGLOSE SIDE. (CRC R 302.7)

- STANDING SEAM METAL SO DRYER VENT
 - COMPOSITION SHINGLE ROOF BY: GAF ROOFING TIMBERLINE 40' ICC-ES ESR-1475 OR EQUAL 51) 42" HIGH FENCE (OPTIONAL
 - EXTERIOR PLASTER WITH CONTROL JOINTS PER CODE
- SECTIONAL OVERHEAD GARAGEDOOR
- SURFACE MTD LIGHT FIXTURE $\langle 5 \rangle$
- 6 METAL GUTTER (OPTIONAL) 7 - 12×30 TRIM W LIGHT -
- 8 -SKYLIGHT-
- 9 SHOWER
- ENTRY DOOR, 3"-0" X 8'-0" THERMATRUFIBERGLASS DOOR WITH & WIDE ENTRY DOOR TRIM
- 11) FRENCHDOOR
- 12 -DORMER-
- (13) WINDOWTRIM 2 x 6 RAKE FASCIA, TYP.
- 6X8 TRELLIS AND PROTECTING BEAM **(15)**
- 16 METAL DOWNSPOUT
- \$ BATTEN BOARD SIDING
- **(18)** WOOD TRIM
- (19) KNEE BRACE WINDOW - SINGLE 20
- 21) SLIDING WINDOW
- 22 SLIDING DOORS
- (23) METAL FLASHING EXTERIOR DOOR WITH LOUVER 24
- 25 CONTROLJOINT
- 26 TRASH BIN
- 27 COLUMN/POST 28 IX HEADER TRIM
- FLOOR LINE TRIM (OPTIONAL) 29
- 30 FIXED WINDOW
- 31) WEEP SCREED
- 32 WOODENSTAIRS
- INSULATION WHERE OCCURS SEE SHEET T-24 33
- ROOF DIAPHRAGM SHEATHING
- 2X BLOCKING
- 4X4 HEAVY TIMBER @ 12" O.C. ± 36 37 CONCRETE FOOTING
- PAINTED 5/8" TYPE 'X'
- 39 6'HIGH FENCE 40 FAUXVENT
- VINYL WEEP SCREED PER CODE
- 42 12" ROOF EAVE 43 CONCRETE SLAB
- 44 42" HIGH GUARDRAIL
- O'HAGIN'S ATTIC VENT WHERE OCCURS, SEE ROOF PLAN LINE OF 6'-0" HIGH PRIVACY FENCE 46
- 30" X 30" MIN ATTIC ACCESS WITH 30" MIN HEADROOM CRC R807.1 WITH WEATHER STRIPS TO PREVENT BACK DRAFT 79 DASHED, LG LMU36CHV
- 48 KITCHEN HOOD VENT 80 BOLLARD
- 49 WATER HEATER VENT

BPS

Bryant Palmer Soto Inc.

BUILT CUSTOM HOMES, LLC (714) 587 2565

7852 RONALD DRIVE HUNTINGTON BEACH, CALIFORNIA 92647

THE DOLMENTS ARE COMPODING, MO PROPRETART TO BEHINT, PLUER, 5010, INC.
AKE SHALL HOT BE USED INSIDERED, REVIEWED, BY REPROJUCTIO IN HIGH ON IN PAIR
WHICH THE PROS RECORDED LY HAS AN ORMETTE. THE AS IN HAVENING HOME
PRESENTION OR REPORT OF PERIORIES, LIDURISHONS HOME ORTHORISES CHAPTER,
AMPLICE SHE HE PROJECT SHE BY THE CONTRACTOR. THE DOCUMENTS SHALL BY
USER SHE BOSS FOR CONSTRUCTION HALESS SPECIFICALLY WAVED, THEROOR FOR
CONSTRUCTION.

SUBMITTALS

| MARK | DATE | DESCRIPTION |
|------|------------|---------------------------|
| | 07-08-2019 | NITIAL PLANNING REVIEW |
| | 07-22-2019 | PLANNING APPLICATION |
| | 11-26-2019 | PLANNING APP RE-SUBMITTAL |
| | | |
| | | |
| | 9 | |

REVISIONS

| CLOSED POSITION AND | MARK | DATE | DESCRIPTION | |
|--|----------|------|-------------|--|
| WITHIN 24" OF THE HINGE | | | | |
| SIDE OF AN IN-SWINGING | | - | | |
| DOOR. iii ALL GLAZING WITHIN 36" | | + | | |
| OF THE WALKING SURFACE | | - | | |
| OF STAIRWAY AND | | - | | |
| LANDINGS AND ANY GLAZING | | | | |
| LESS THAN 36' ABOVE THE | | | | |
| WALKING SURFACE WITHIN 60" HORIZONTALLY OF THE | | | | |
| BOTTOM TREAD OF A | | | | |
| STAIRWAY. | | _ | | |
| DUTCH DOOR | | + | | |
| 55751125511 | | + | | |
| LATTICE | _ | - | - | |
| 14X TRIM BOARD | \vdash | | Stamp | |
| THE TRIBUTIONS | | | Starrip | |

DO NOT SCALE THE DRAWINGS SCALES INDICATED ARE FOR RELATIVE SCALE ONLY DIMENSIONS SHALL GOVERN OVER SCALE.

02-1124-001 Job No :: CADD File; K WII 1744-441 7612 RONALD AVENUE/CADPLANANCE SETA I ELEVATIONS DING roject Start Date 11-01-2018 Drawn By VI. ΚP Checked By: AS NOTED Scale:

ELEVATIONS

A-3

(10) ALLEY VIEW




6 ALLEY VIEW





STREET VIEW
NEIGHBOR TO THE WEST

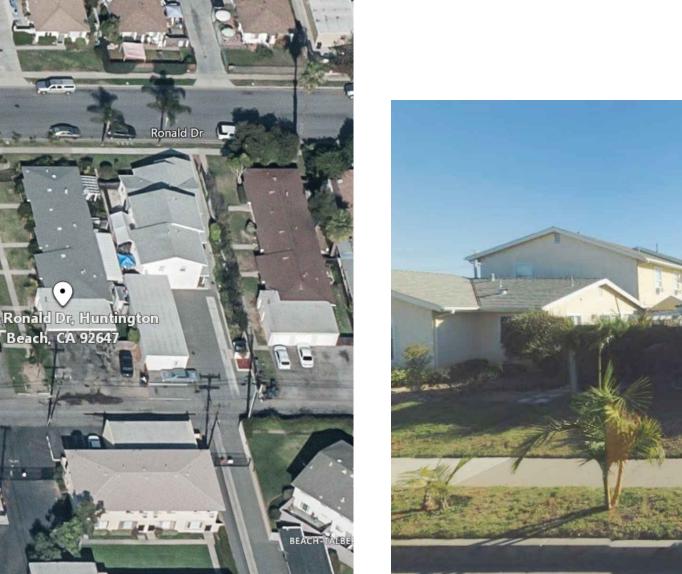

AERIAL VIEW
REAR TOP VIEW



STREET VIEW
FRONT VIEW TO SITE



8 ALLEY VIEW



AERIAL VIEW
ROOF TOP VIEW

7 ALLEY VIEW



STREET VIEW
NIEGHBOR TO THE EAST

Bryant Palmer Soto Inc.

Neil Stanton Palmer ARCHITECTS / Jack K. Bryant ENGINEERS 2601 Airport Drive, Suite 310, Torrance, CA 90505 Telephone: (310) 326-9111 Fax: (310) 325-0271

BUILT CUSTOM HOMES, LLC (714) 587 2565

7852 RONALD DRIVE HUNTINGTON BEACH, CALIFORNIA 92647

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| SUBMITTALS | | | | | |
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| //ARK | DATE | DESCRIPTION | | | |

| R | MARK | DATE | DESCRIPTION |
|-----|------|------------|---------------------------|
| | | 07-08-2019 | INITIAL PLANNING REVIEW |
| E . | | 07-22-2019 | PLANNING APPLICATION |
| œ. | | 11-26-2019 | PLANNING APP RE-SUBMITTAL |
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REVISIONS

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| DO NOT SCALE THE DRAWINGS. | |
| SCALES INDICATED ARE FOR | |
| RELATIVE SCALE ONLY. | |
| DIMENSIONS SHALL GOVERN | |
| OVER SCALE. | |
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11-01-2018 Checked By: AS NOTED

Drawing Title


SITE VIEWS

PRE RADING П 6 N 6

FOR CONDOMINIUM PURPOSES PURPOSE: CREATE 1 PARCEL

ROBIN HAMERS, RCE 31720

DATE OF PREPARATION: MAY 2019

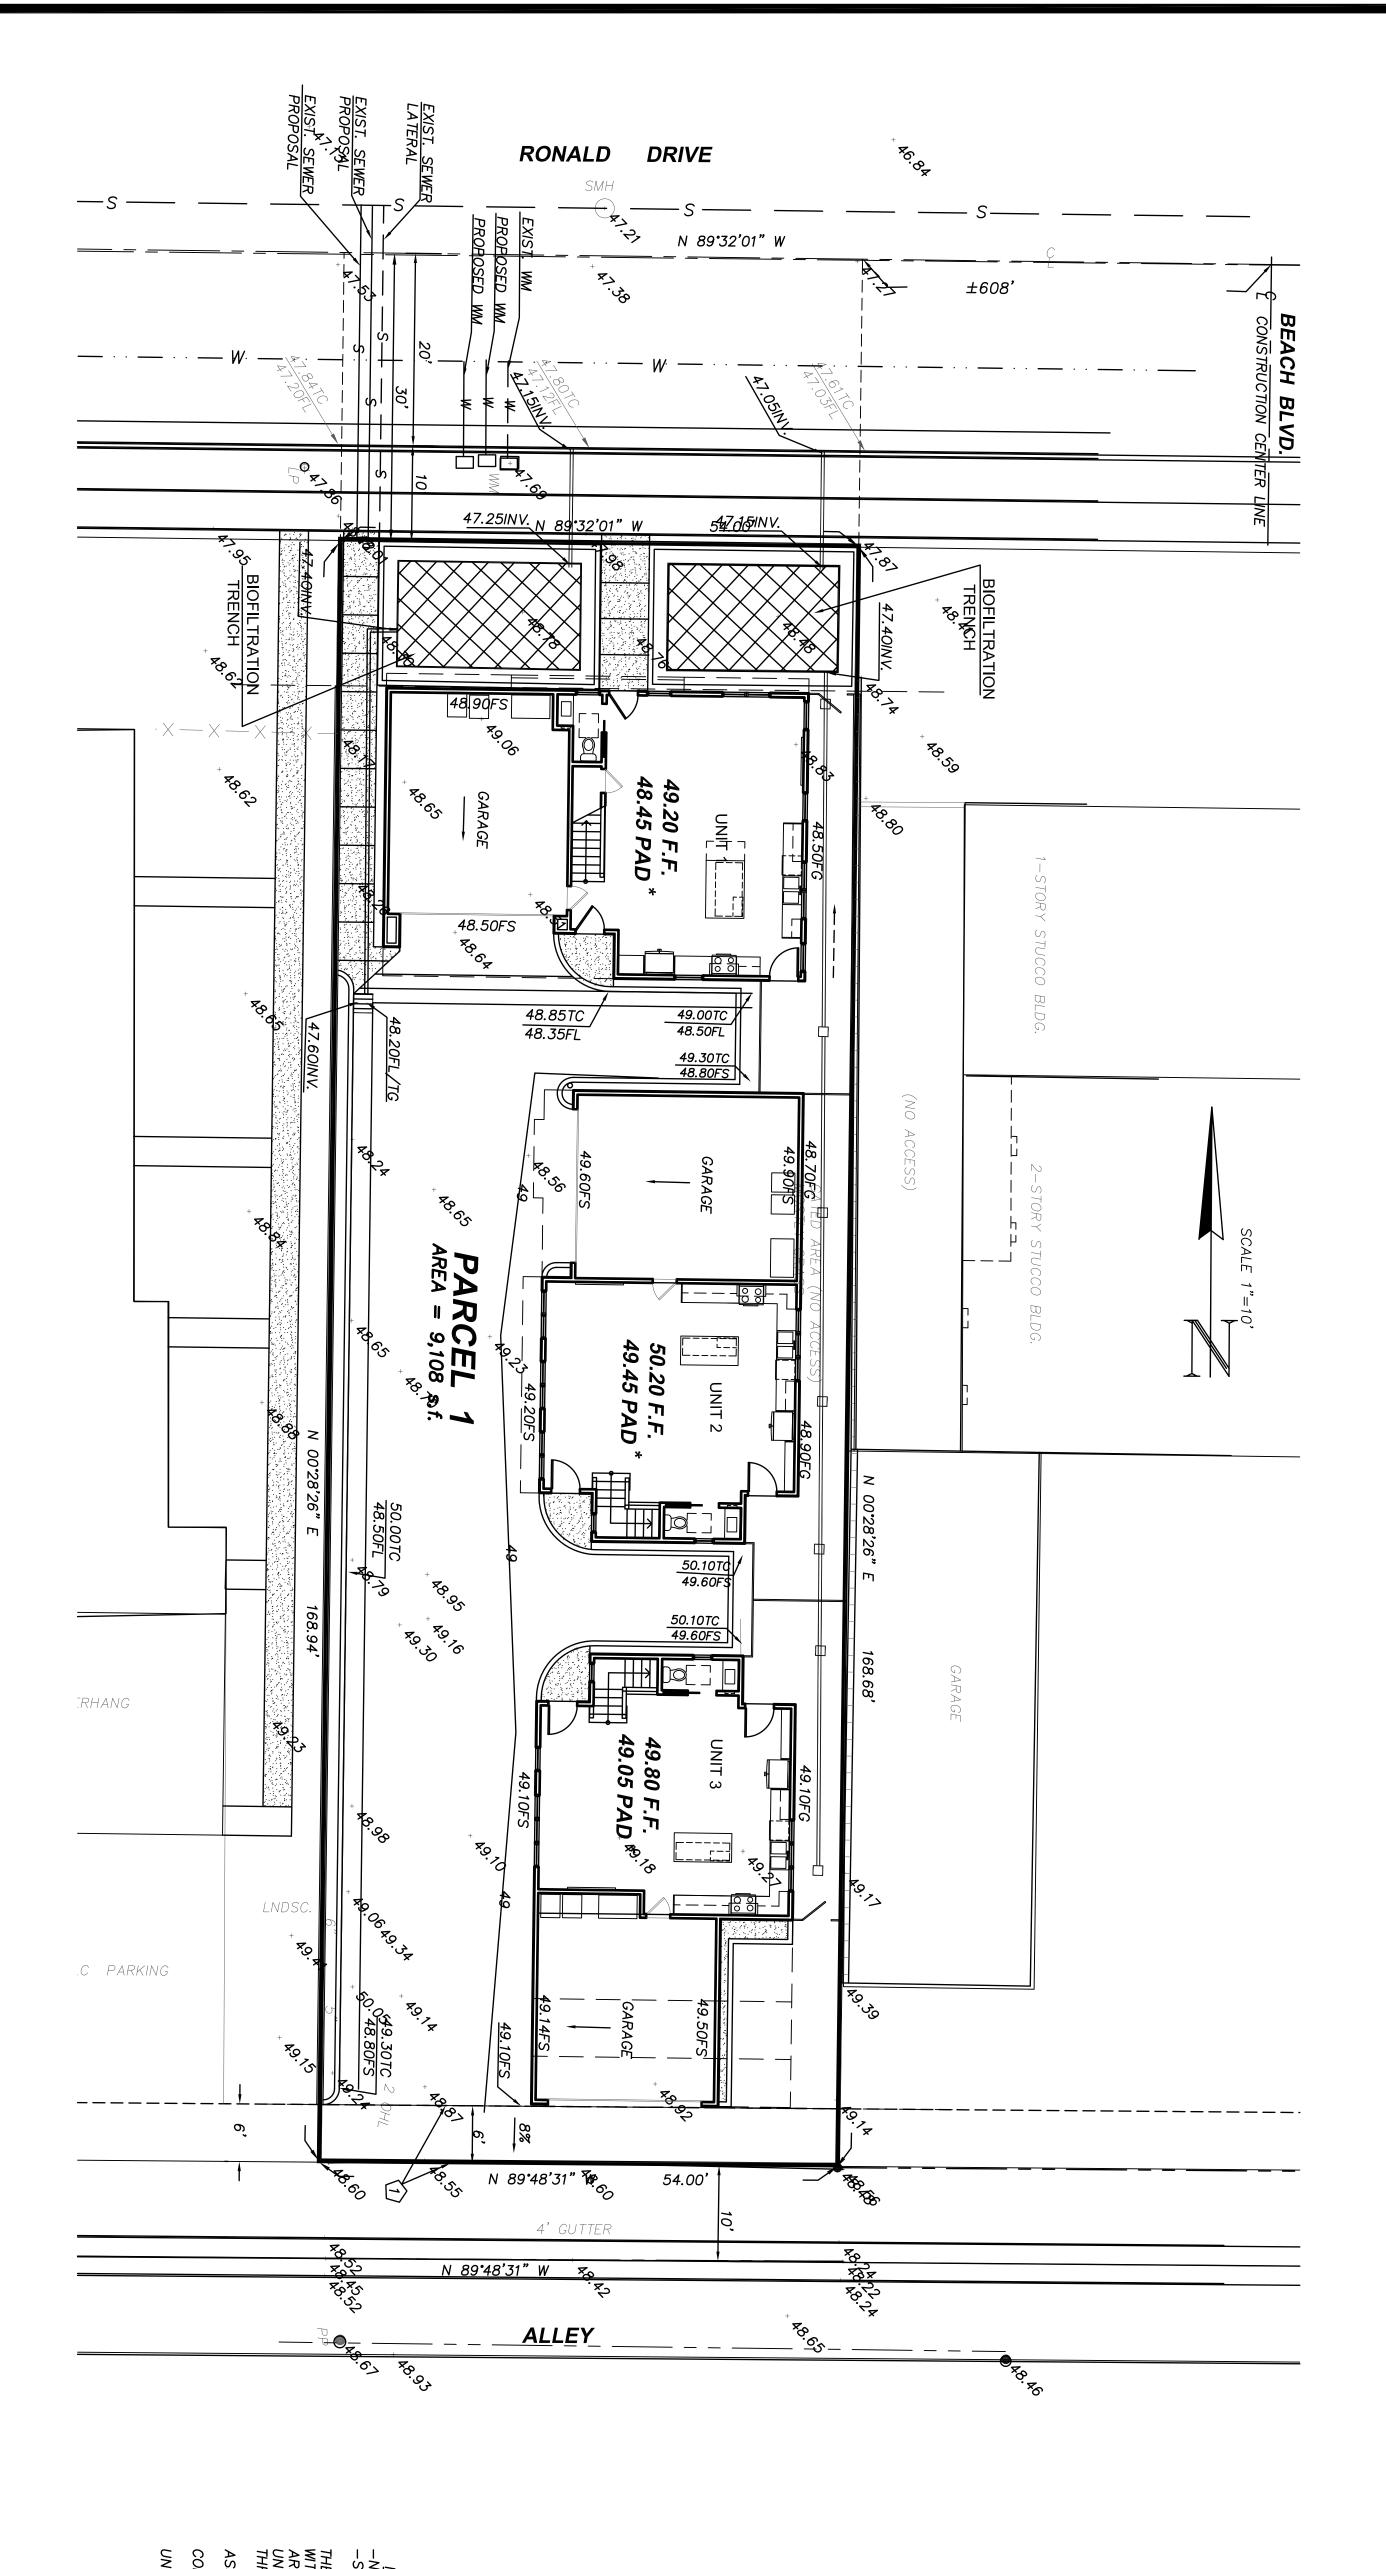

SITE ADDRESS:
7852 RONALD DR.
HUNTINGTON BEACH, CA 92647
A.P.N. 165-302-12 AREA SUMMARY

TOTAL AREA = 9,108 S.F.(0.209 ac.) GROSS

PURPOSE STATEMENT

THE PURPOSE IS TO CREATE 1 PARCEL FOR 3 CONDOMINIUMS

ALL EXISTING BUILDINGS TO BE REMOVED

OWNER

BRETT M. ROTH 7950 YORKTOWN AVE., UNIT 1 HUNTINGTON BEACH, CA 92648

ROTH 11th STREET, LLC 7950 YORKTOWN AVE., UNIT 1 HUNTINGTON BEACH, CA 92648 SUBDIVIDER:

ROBIN B. HAMERS AND ASSOC., INC. 234 E. 17TH STREET, SUITE 205 COSTA MESA, CA. 92627 (949) 548-1192 ROPESSIONAL ROPESS NO. RCE 31720 CIVIL OF CALIFO

ENGINEER:

BASIS OF BEARING

THE BEARINGS SHOWN HEREON ARE BASED UPON THE BEARING BETWEEN HORIZONTAL CONTROL STATION GPS 5071R1 AND STATION GPS 5072R1 BEING N89°48'04"W PER RECORDS ON FILE IN THE OFFICE OF THE COUNTY SURVEYOR OF ORANGE COUNTY, CALIFORNIA.

LEGAL DESCRIPTION:

LOT 12 OF TRACT NO. 3478, IN THE CITY OF HUNTINGTON BEACH, COUNTY OF ORANGE, STATE OF CALIFORNIA,, AS PER MAP RECORDED IN BOOK 141, PAGE(S) 31 AND 32, OF MISCELLANEOUS MAPS IN THE OFFICE OF THE COUNTY RECORDER OF SAID COUNTY.


ZONE X, OUTSIDE THE 100 YEAR FLOOD BOUNDARIES FLOOD ZONE

EASEMENTS


(1) EASEMENT TO SOUTHERN CALIFORNIA EDISON COMPANY FOR PUBLIC UTILITIES PER DEED 5665/205 O.R.

THERE WILL BE THREE CONDOMINIUMS AND AN ASSOCIATION IN ACCORDANCE WITH A CONDOMINIUM PLAN AND CC&RS THAT WILL BE PREPARED. BUYERS ARE ACQUIRING A UNIT, WHICH IS THE AREA INSIDE THE UNITS UP TO THE UNFINISHED SURFACE OF THE WALLS, FLOORS, AND CEILINGS. THERE WILL BE THREE MAJOR COMPONENTS: NOTES: -NO EXISTING WATERCOURSES ON SITE -SITE IS NOT SUBJECTED TO OVERFLOW OR INUNDATION

ASSOCIATION PROPERTY - WILL BE ALL REAL PROPERTY IN THE DEVELOPMENT EXCEPT FOR THE UNITS AND THE COMMON AREA.
COMMON AREA - WILL BE VOLUMES OF AIR SPACE OWNED BY THE OWNERS
AS TENANTS IN COMMON
UNITS - THE AREA INSIDE THE UNIT BOUNDED BY THE UNFINISHED WALLS,
FLOORS, AND CEILING.

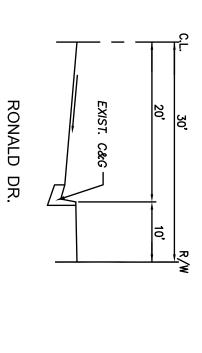

TYPICAL STREET SECTION
NTS

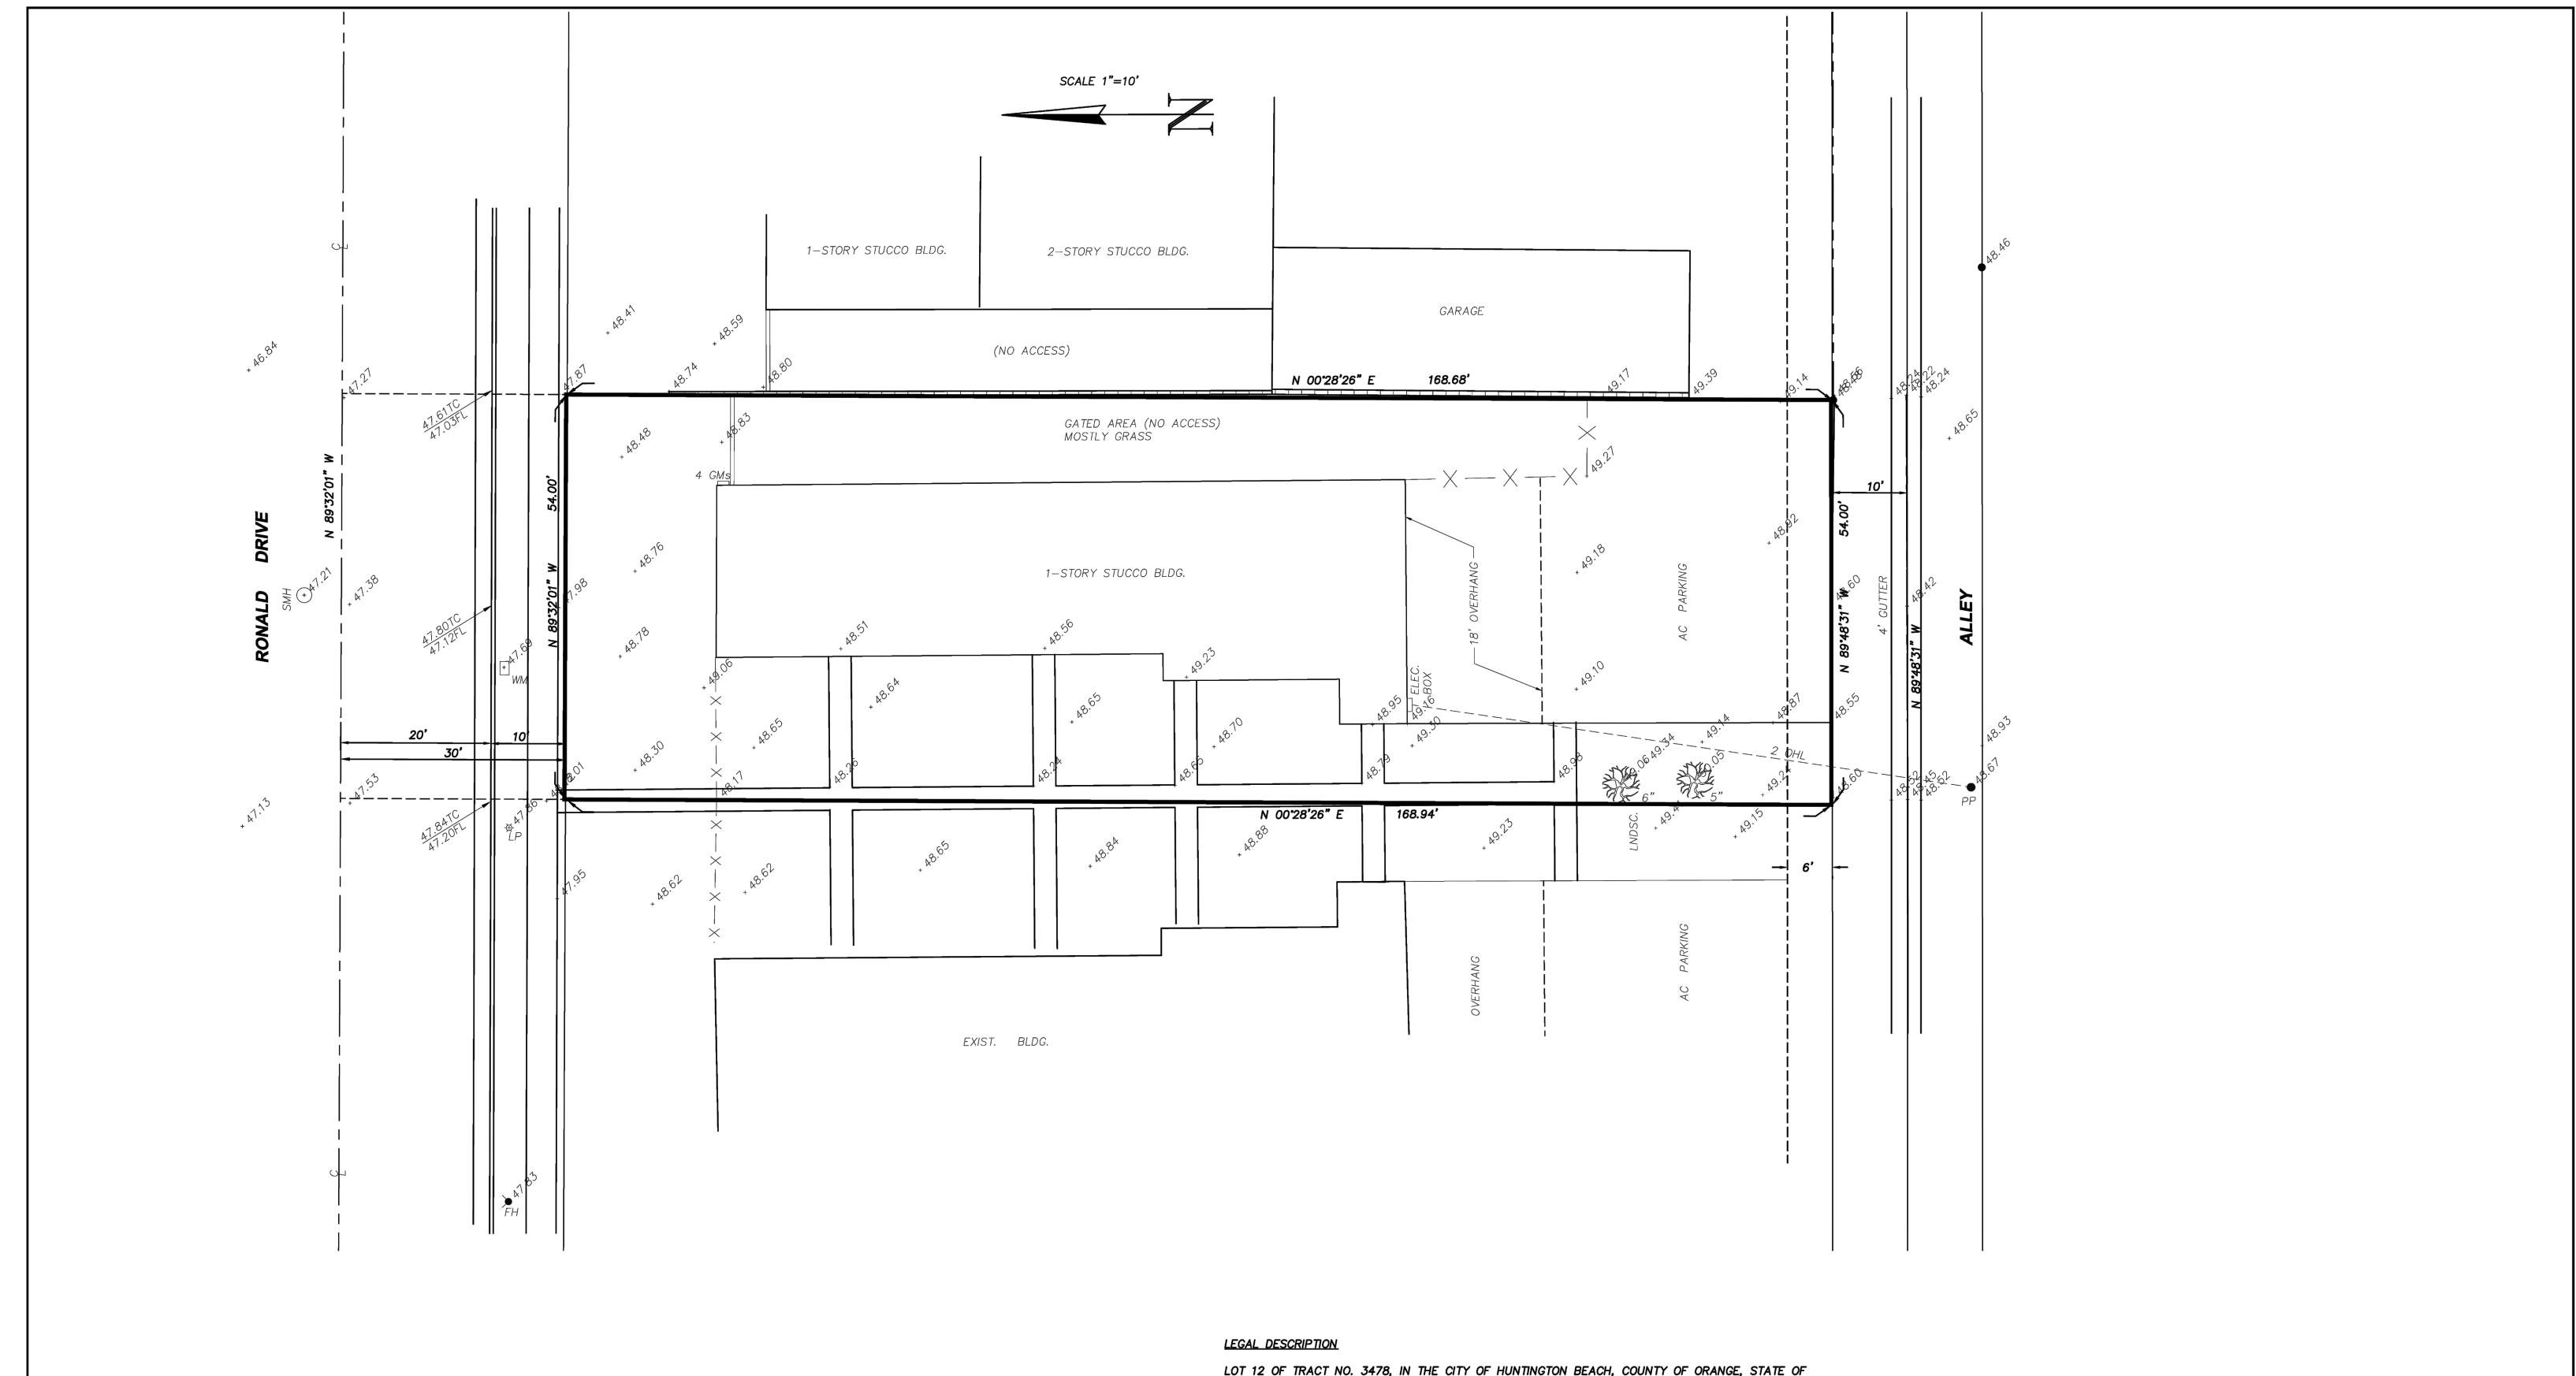

LOT 12 OF TRACT NO. 3478, IN THE CITY OF HUNTINGTON BEACH, COUNTY OF ORANGE, STATE OF CALIFORNIA,, AS PER MAP RECORDED IN BOOK 141, PAGE(S) 31 AND 32, OF MISCELLANEOUS MAPS IN THE OFFICE OF THE COUNTY RECORDER OF SAID COUNTY.

SHEET NO.

APN: 165-302-12

<u>LEGEND:</u>

(A) EASEMENT FOR PUBLIC UTILITIES TO SOUTHERN CALIFORNIA EDISON COMPANY DATED MARCH 22, 1961 PER BOOK 5665, PAGE 205, OF OFFICIAL RECORDS

REFERENCES PREPARED UNDER THE SUPERVISION OF: Underground Service Alert **REVISIONS** TOPOGRAPHIC SURVEY REV. DATE BY APP'√D Call: TOLL FREE R.C.E. NO.: _ EXP. DATE:_ REVIEWED BY: 1-800-422-4133 7852 RONALD DRIVE RG 01/18/19 YT 01/18/19 CITY OF HUNTINGTON BEACH DEPARTMENT OF PUBLIC WORKS HUNTINGTON BEACH, CA HUNTINGTON BEACH DEPT. OF PUBLIC WORKS TWO WORKING DAYS BEFORE YOU DIG CHECKED BY:

BENCHMARK HB-202-71

DESCRIBED BY OCS 2004 — FOUND 3 3\4" OCS ALUMINUM BENCHMARK
DISK STAMPED "HB-202- 71", SET IN THE SOUTHEASTERLY CORNER OF A
6 FT. BY 7 FT. CONCRETE CATCH BASIN. MONUMENT IS LOCATED IN THE
NORTHWESTERLY CORNER OF THE INTERSECTION OF BEACH BOULEVARD AND
TALBERT AVENUE, 62 FT. WESTERLY OF THE CENTERLINE OF BEACH
BOULEVARD AND 89.5 FT. NORTHERLY OF THE CENTERLINE OF TALBERT.
MONUMENT IS SET LEVEL WITH THE SIDEWALK.

ELEV. 46.3668 (NAVD88) 2005 LEVELED