

### **KEYNOTES**

- 1 PROPOSED SUBARU P50 PYLON SIGN- 20'-3" HIGH
- 2 10'-0" X 10'-0" LINE OF SIGHT TRIANGLE TO REMAIN CLEAR OF OBSTRUCTIONS
- 3 CALTRANS LINE OF SIGHT
- 4 EXISTING VW PYLON SIGN

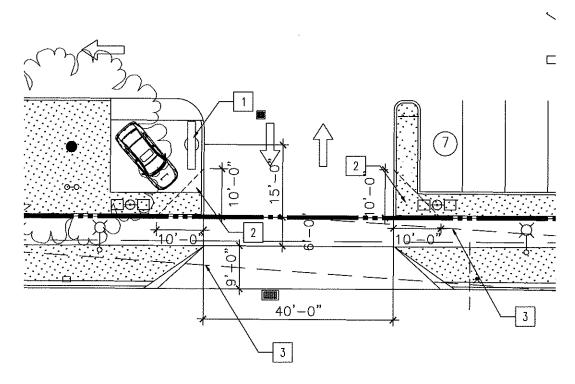

DETAIL 2 ENGLARGED SITE PLAN 1"=10'-0"

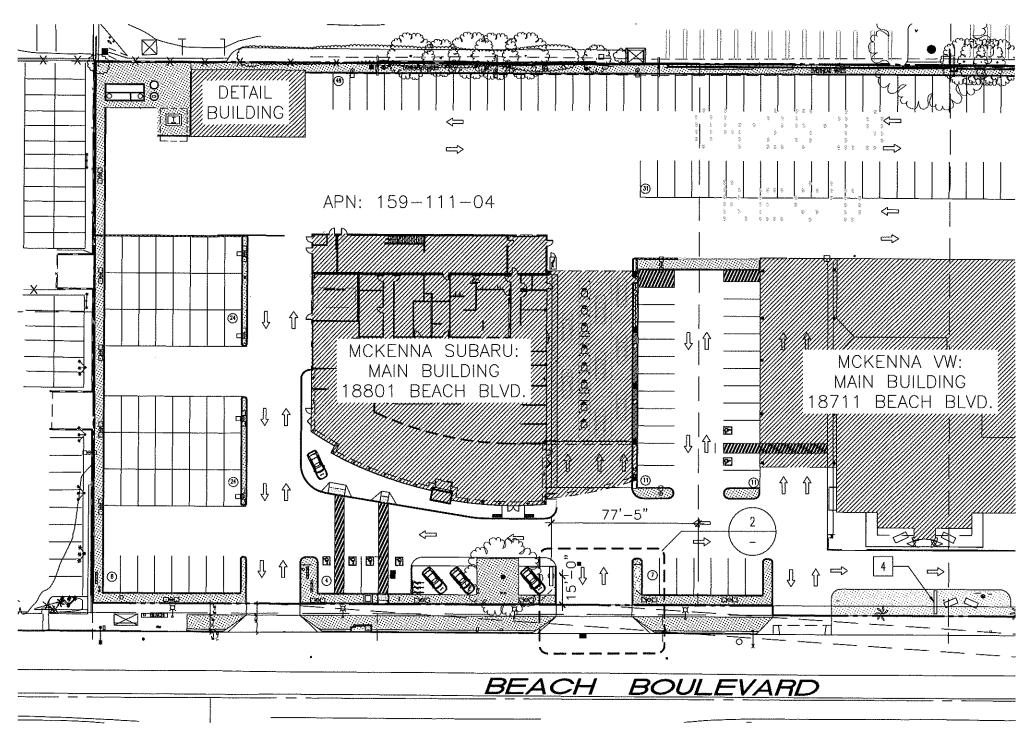

OVERALL SITE PLAN
1"=50'-0"






# SUBARU SIGN VARIANCE

18801 BEACH BOULEVARD HUNTINGTON BEACH, CA April 23, 2019

F:\16\16A042 - Huntington Beach - McKenn Subaru\CD\x16A042 - Site Plan.dwg

The piers, these, emergements and developed sciency to represented by the deserting and overald by, and are the property of SCKS GROUP, and were created and developed sciency for use on, and its connection with this specific project, and what such is retained.



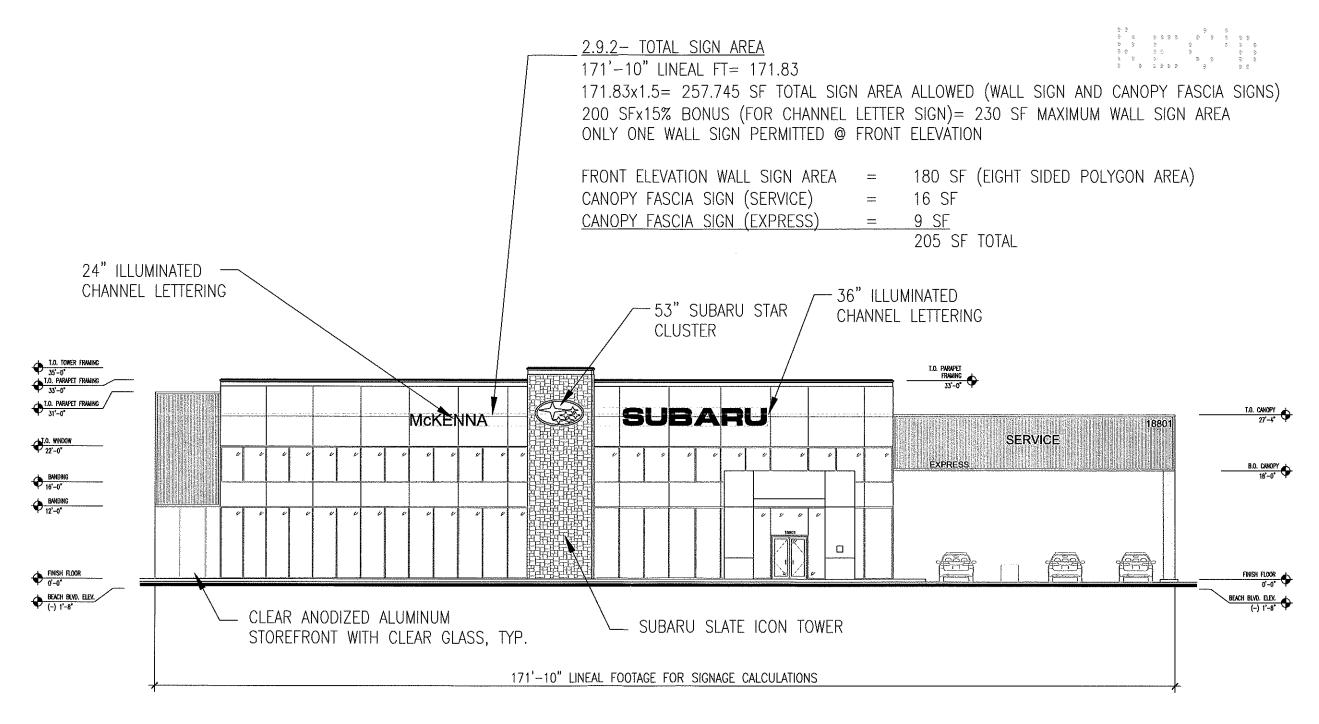



## SUBARU SIGN VARIANCE


18801 BEACH BOULEVARD HUNTINGTON BEACH, CA


## **ELEVATION**

Scale: 1/16" = 1'-0" April 23, 2019


F:\16\16A042 - Huntington Beach - McKenna Subaru\CD\x16A042 - Elevations.dwg

the parts, mass, arrangements and usegue instead or represented by the among any owned by, and are the property or or GROUP, and were created and developed beinly for case on, and in connection with this specific project, and fair to suck, in white part, for any curroups for which have were not originally intereded without written commission from IRCHE\_GROUP 9 2017.

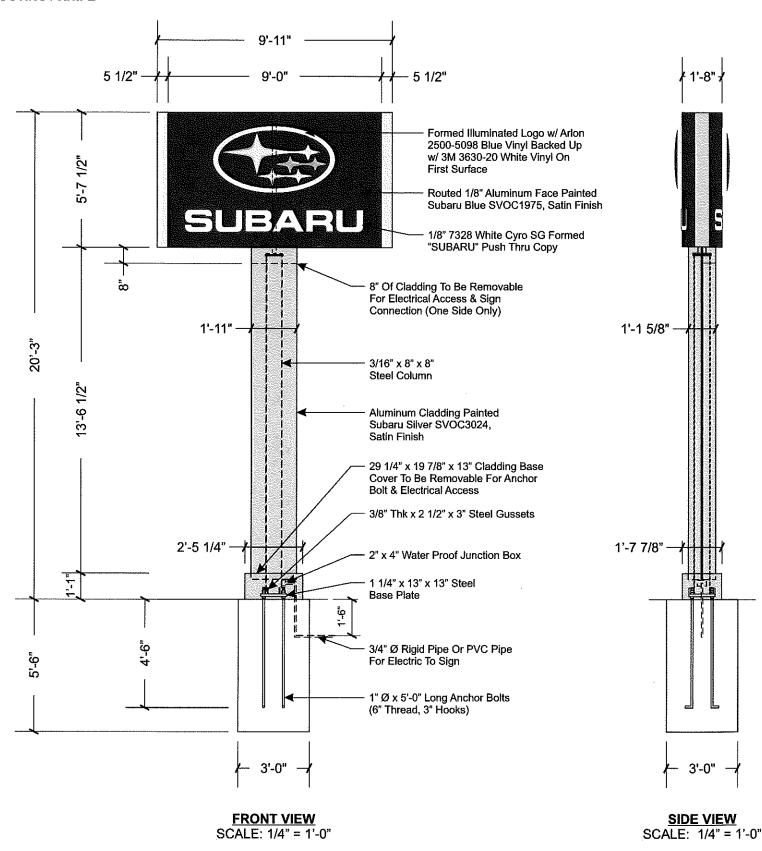

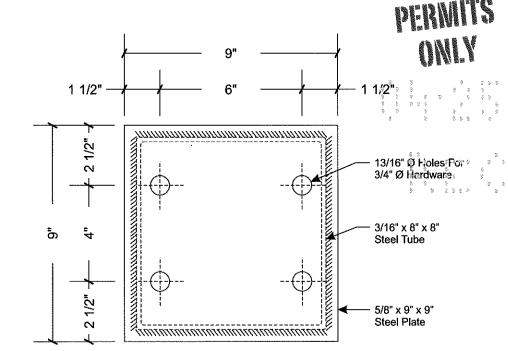

#### **MATCH PLATE DETAIL** SCALE: 3" = 1'-0"

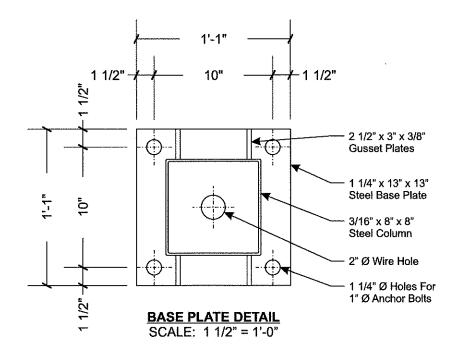

By Others.

Qty

**HARDWARE LIST** 

Hardware

3/4" Ø x 3" Lg Hex Bolts w/ Nuts

& (2) Flat (1) Lock Washer Per Bolt

1" Ø x 5'-0" Lg Bolt

6" Thread / 3" Hook

(3) Nuts (2) Flat Washers Per Bolt

Description

Match Plate

Hardware

Anchor Bolt

Note: Unless Otherwise Noted

- All Hardware to be SAE J429 - Grade 2

- All Anchor Bolt Washers to be F844

- All Anchor Bolts to be ANC F1554-GR55 - Grade 55

- All Anchor Boit Nuts to be Heavy Hex Nuts A563A

Where Allowed By Local Codes.

3. Sign Shall Be U.L. Listed.

4. Soil Assumed To Be Medium Clay, Or Better, With Minimum Soil Bearing Capacity Of 2,500 PSF.

**Electrical Load** 1.74 Amps @ 120 Volts

**Electrical Regimts** 

(1) 20 Amp/120 Volt Circuits

6. Reinforcing Steel Shall Be ASTM A615 GR-40.

7. Structural Steel Shall Be ASTM A36.

8. All Welds Shall Conform To A.W.S Standards.

FHILADELPHIASIGN

BRINGINGSTHE WORLD'S BRANDS TO LIFE

707 West Spring Garden Street Palmyra, New Jersey 08065

Phone: 856.829.1460 Fax: 856.829.8549 www.philadelphiasign.com

CUSTOMER:

**SUBARU** 

JOB NUMBER:

SIGN TYPE: P50 Pylon

LOCATION:

DATE:

3-2-18

DRAWN BY: RAB

REVISION:

Date: Number:

SHEET:

1 of 3

ENG DEPT

DWG NUMBER:

B77560

**ENGINEER SEAL:** 

**STANDARD PYLON NOTES:** 

1. Sufficient Primary Circuit In Vicinity Of Sign

2. Final Primary Hook-up By Sign Installer,

5. Concrete 2,500 PSI @ 28 Days.

THIS IS AN ORIGINAL UNPUBLISHED DRAWING CREATED BY PSCO. IT IS SUBMITTED FOR YOUR PERSONAL USE IN CONJUNCTION WITH A PROJECT BEING PLANNED FOR YOU BY PSCO. IT IS NOT TO BE SHOWN TO ANYONE OUTSIDE YOUR ORGANIZATION NOR IS IT TO BE USED, COPIED, REPRODUCED, OR EXHIBITED IN ANY FASHION.

MAX DESIGN WIND SPEED 90 MPH


EXPOSURE C

Note: This sign is intended to be installed in accordance with the requirements of Article 600 of the National Electrical Code and/or other applicable local codes. This includes proper grounding and bonding of the sign.







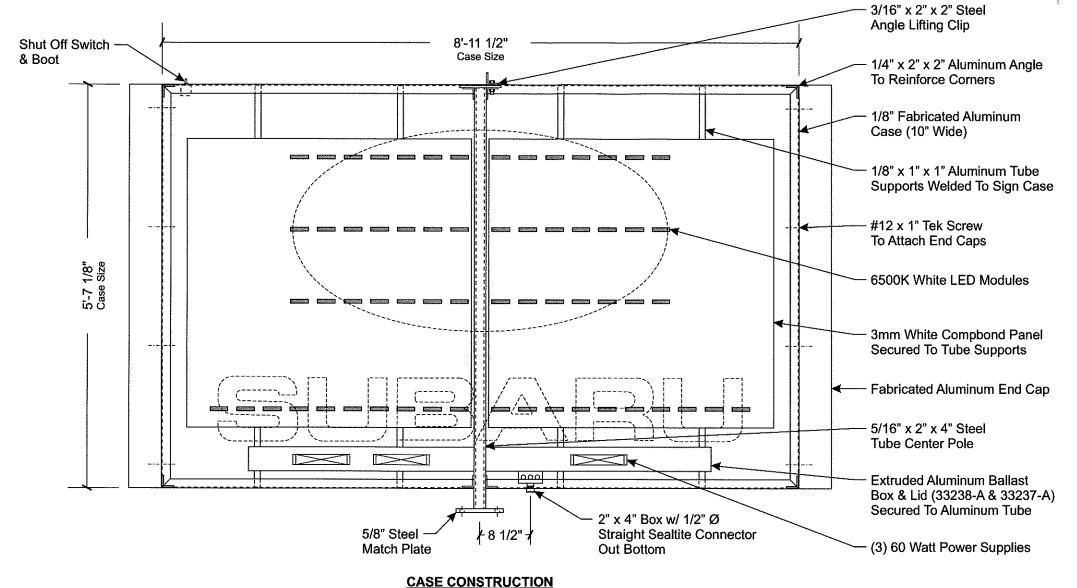

SCALE: 3/4" = 1'-0"

PHILADELPHIASIGN

707 West Spring Garden Street Palmyra, New Jersey 08065

Phone: 856.829.1460 ≅ลx៖ 856.829.8549 ซูพซึ้ง.philadelphlasign.com

CUSTOMER:

SUBARU

JOB NUMBER:

SIGN TYPE: P50 Pylon

LOCATION:

DATE:

3-2-18

DRAWN BY:

REVISION:

Number: Date:

SHEET:

ENG DEPT

2 of 3

DWG NUMBER:

B77560


ENGINEER SEAL:

MAX DESIGN WIND SPEED 90 MPH EXPOSURE C

THIS IS AN ORIGINAL UNPUBLISHED DRAWING CREATED BY PSCO. IT IS SUBMITTED FOR YOUR PERSONAL USE IN CONJUNCTION WITH A PROJECT BEING PLANNED FOR YOU BY PSCO. IT IS NOT TO BE SHOWN TO ANYONE OUTSIDE YOUR ORGANIZATION NOR IS IT TO BE USED, COPIED, REPRODUCED, OR EXHIBITED IN ANY FASHION.

Note: This sign is intended to be installed in accordance with the requirements of Article 600 of the National Electrical Code and/or other applicable local codes. This includes proper grounding and bonding of the sign.

**ENGINEERING** SHOP VINYL / LAYOUT **ROUTING / KNIFE** 

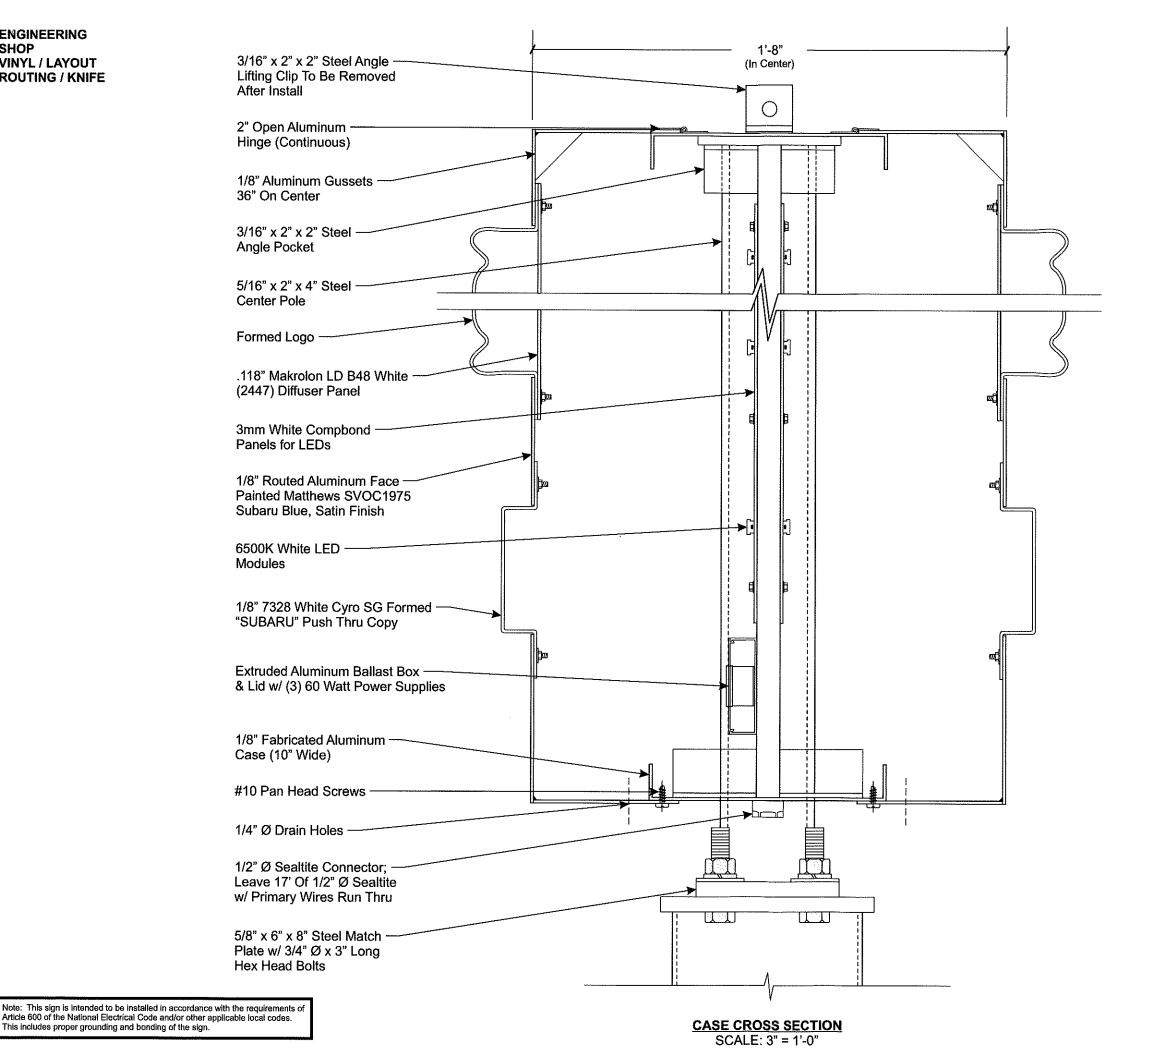







PHILADELPHIASIGN RINGINS THE WORLD'S BRANDS TO LIFE

707 West Spring Garden Street Palmyra, New Jersey 08065

Phone: 856.829.1460 Far: 856.829.8549 www.philadelphiasign.com

CUSTOMER:

**SUBARU** 

JOB NUMBER:

SIGN TYPE: P50 Pylon

LOCATION:

DATE:

3-2-18

DRAWN BY: RAB

REVISION:

Number: Date:

ENG DEPT

SHEET:

3 of 3

DWG NUMBER:

B77560

**ENGINEER SEAL:** 

MAX DESIGN WIND SPEED 90 MPH EXPOSURE C

THIS IS AN ORIGINAL UNPUBLISHED DRAWING CREATED BY PSCO. IT IS SUBMITTED FOR YOUR PERSONAL USE IN CONJUNCTION WITH A PROJECT BEING PLANNED FOR YOU BY PSCO. IT IS NOT TO BE SHOWN TO ANYONE OUTSIDE YOUR ORGANIZATION NOR IS IT TO BE USED, COPIED, REPRODUCED, OR EXHIBITED IN ANY FASHION