
#### **DEFERED APPROVAL SUBMITTAL:**

- 1. CONTRACTOR TO PROVIDE & SUBMIT DESIGN/DOCUMENTATION FOR FUTURE SOLAR PANELS FOR
- THE ADU AS REQ'D PER LOCAL CODE REQUIREMENT (110.10). 2. ROOFTOP-MOUNTED PV PANEL SYSTEM SHALL BE DESIGNED & INSTALLED PER R324 & CEC (R907)
- 3. PV SYSTEM SHALL BE INSTALLED PRIOR TO FINAL APPROVAL FOR THE ADU.
- 4. FIRE/ALARM SYSTEM. SEE "FIRE CODE GENERAL NOTES" FOR MORE DETAIL.

#### FIRE CODE GENERAL NOTES

- 1. CONTRACTOR SHALL PROVIDE PLANS FOR THE INSTALLATION OR MODIFICATION OF THE

- C. CARBON MONOXIDE ALARM: ALL CARBON MONOXIDE DETECTOR SHALL BE UL2034/2075
- 1. THERE IS NO HAZADOUS MATERIAL STORAGE IN THIS PROJECT.
- 2. CONTRACTOR SHALL PROMPTLY COMMUNICATE WITH THE OWNER/ARCHITECT IF RECOGNIZE
- POTENTIAL HAZADOUS MATERIAL STORAGE EXIST IN THE PROJECT.

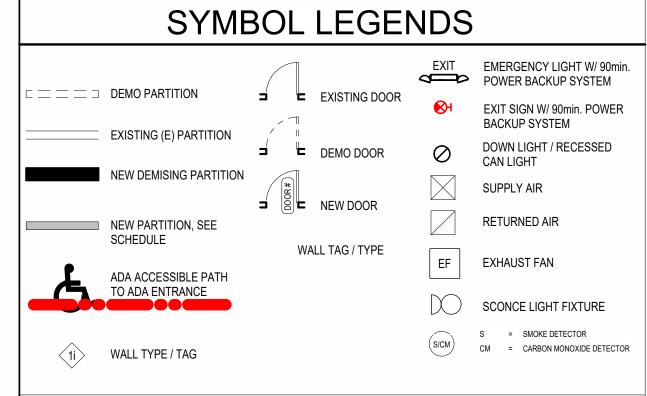

### 

ABBREVIATIONS			
ACT	ACOUSTICAL CEILING TILE	LL	LANDLORD
ADA	AMERICANS WITH DISABILITIES ACT	LAM	LAMINATE
AFF	ABOVE FINISHED FLOOR	LAV	LAVATORY
AHJ	AUTHORITIES HAVING JURISDICTION	LF	LINEAR FEET
ALUM	ALUMINUM		MANUFACTURER
ANSI	AMERICAN NATIONAL STANDARDS INSTITUTE	MAS	MASONRY
AP	AMERICAN PRODUCTS	MAX	MAXIMUM
ASTM	AMERICAN SOCIETY FOR TESTING & MATERIALS	MECH	
APPROX BD	APPROXIMATE BOARD	MGR MO	MANAGER MASONRY OPENING
BLKG	BLOCKING	MIN	MINIMUM
BLDG	BUILDING	MTL	METAL
B.O.	BOTTOM OF	MISC	MISCELLANEOUS
CM	CARBON MONOXIDE ALARM	MTD	MOUNTED
CJ	CONTROL/CONSTRUCTION JOINT	NA	NOT APPLICABLE
CL	CEILING	NCBC	NORTH CAROLINA BLDG CODE
CLR	CLEAR	NFPA	NATIONAL FIRE PROTECTION ASSOC
CMU	CONCRETE MASONRY UNIT	NIC	NOT IN CONTRACT
COL	COLUMN	NIS	NOT IN SCOPE OF WORK
CONC	CONCRETE	NTS	NOT TO SCALE
CONST	CONSTRUCTION	OC	ON CENTER
CONT	CONTINUOUS	OD	OUTSIDE DIAMETER
CT	CERAMIC TILE	OPP	OPPOSITE
DBL	DOUBLE	P	PHOTOCELL
DIA	DIAMETER	PL	PLASTIC LAMINATE
DIM DN	DIMENSION DOWN	PLBG PR	PLUMBING PAIR
DN	DOWN SPOUT		BPREFABRICATED
DTL	DETAIL		PREFINISHED
DWG	DRAWING	PROJ	PROJECT
E	EXISTING	PT	PAINT
EA	EACH	PWD	PLYWOOD
EJ	EXPANSION JOINT EXP.	QTY	QUANTITY
EF	EXHAUST FAN	R	RADIUS
ELEC	ELECTRICAL	S	SMOKE DETECTOR
ELEV	ELEVATION	RD	ROOF DRAIN
<b>EMER</b>	EMERGENCY	REF	REFERENCE
EP	ELECTRICAL PANEL	REINF	
EQ	EQUAL	REQD	REQUIRED
EQUIP	EQUIPMENT	REV	REVISION
EWC	EACH WAY	RM	ROOM
EWC EXIST	ELECTRIC WATER COOLER EXISTING	RO SECT	ROUGH OPENING SECTION
EXIST	EXTERIOR	SF	SQUARE FOOT
FC	FLOOR COVERING	SIM	SIMILAR
FD	FLOOR DRAIN	SPEC	SPECIFICATION
FE	FIRE EXTINGUISHER	SQ	SQUARE
FFE	FINISHED FLOOR ELEVATION	SS	STAINLESS STEEL
FRP	FIBERGLASS REINFORCED PANEL	STD	STANDARD
FRT	FIRE RETARDANT TREATED	STL	STEEL
FIN	FINISH	STRUC	<b>T</b> STRUCTURAL
FLR	FLOOR	SUSP	SUSPENDED
FR	FIRE RATED	TD	TRENCH DRAIN
FT	FOOT	TG	TEMPERED GLASS
FURN	FURNISH	T.O.	TOP OF
GA	GALVANIZED	TYP	TYPICAL
GALV	GALVANIZED CENERAL CONTRACTOR	UNO	UNLESS NOTED OTHERWISE
GC	GENERAL CONTRACTOR	UL	UNDERWRITER'S LABORATORY
GFCI	GROUND FAULT CIRCUIT INTERUPT	VCT	VINYL COMPOSITION TILE

VERIFY IN FIELD

VWC VINYL WALLCOVERING

WALL COVERING

WATER PROOF

DESCRIPTION

WCO WALL CLEANOUT

**WB** WALL BASE

WITH

WT WALL TILE


WITHOUT


**WD** WOOD


VACANCY SENSOR

# 16471 MALDEN RESIDENCE - NEW HOUSE




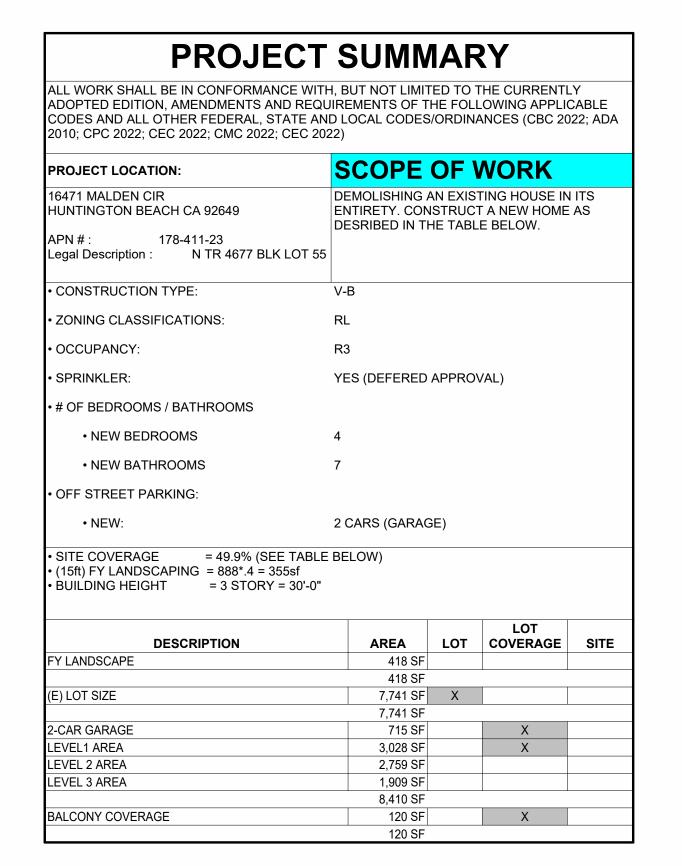

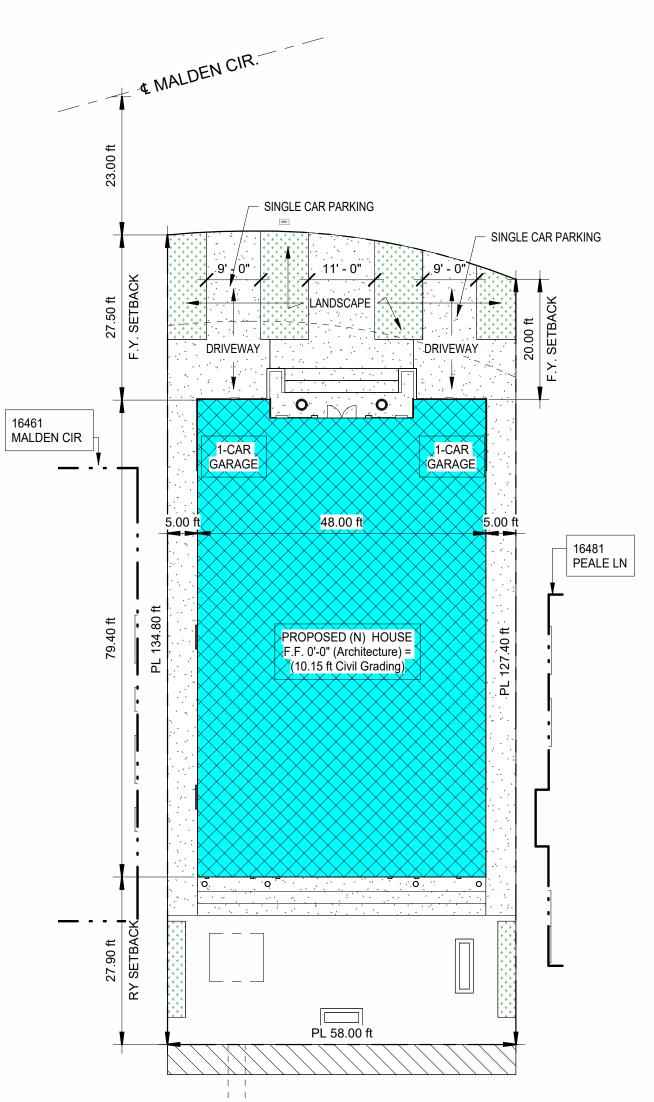

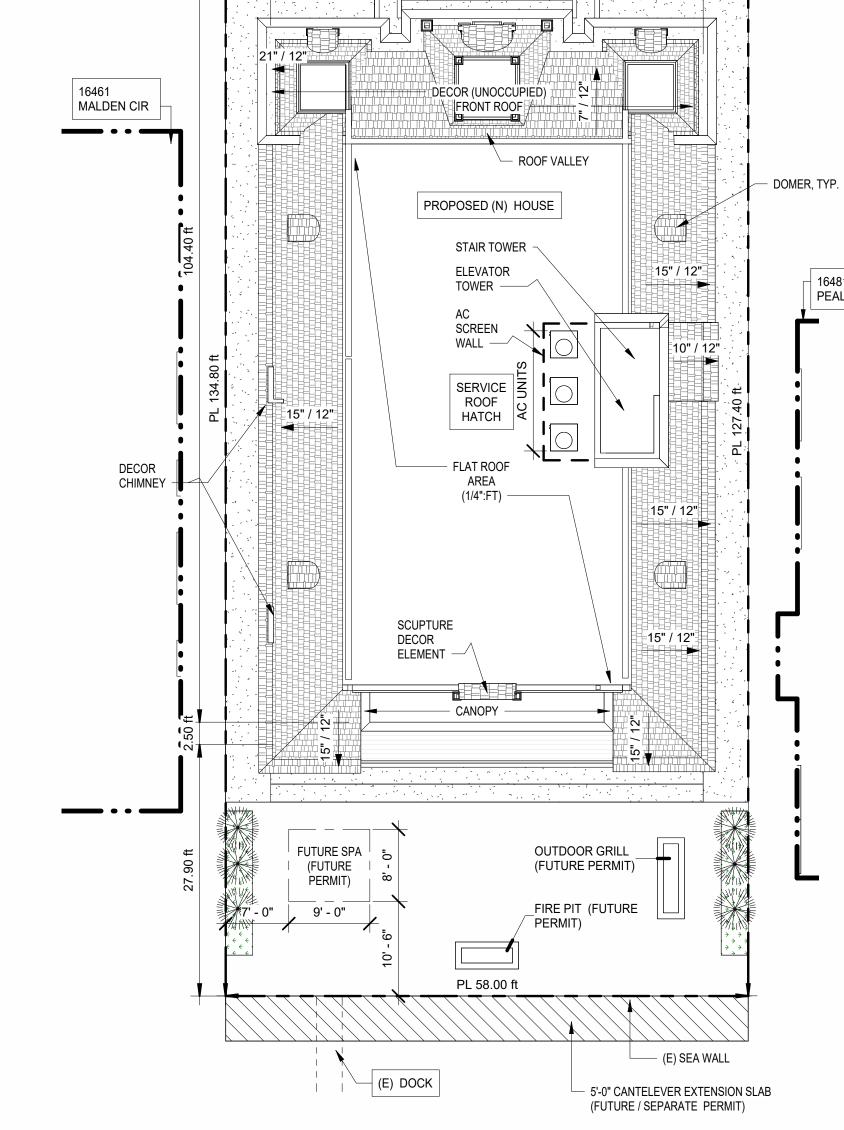

MALDEN CIR.

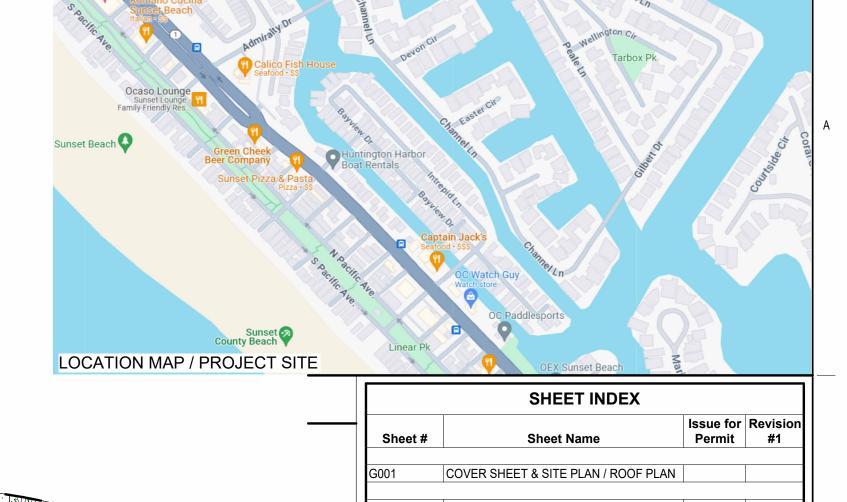

PROJECT LOCATION

## **GENERAL NOTES**

PEALE LN

REFLECTED CEILING PLANS BUILDING ELEVATIONS

PROVIDED INFORMATION, AND IS USED FOR REFERENCE PURPOSES ONLY. IT IS INFORMATION FROM LICENSED PROFESSIONAL SURVEYING OR CIVIL ENGINEER. FAMILIARIZE THEMSELVES WITH THE ACTUAL JOB CONDITIONS. . CONTRACTOR TO VERIFY ALL DIMENSIONS PRIOR TO CONSTRUCTION. IF ANY DIMENSIONS FROM THE PLAN ARE CONTRADICTORY TO FIELD CONDITIONS, CONTACT THE ARCHITECT IMMEDIATELY. FAILURE TO CONTACT THE ARCHITECT WILL RESULT IN THE GENERAL CONTRACTOR ABSORBING ANY ADDITIONAL

PROPERTY LINE / BOUNDARY / SITE NOTES AS SHOWN ARE BASED ON OWNER'S

4. U.O.N CONTRACTOR SHALL PROVIDE FINAL GRADING A MIN. 5% SLOPE AWAY FROM ALL VERTICAL STRUCTURE, AND A MIN. 2% SLOPE TO THE STREET 5. ALL NEW CONCRETE FLAT WORK (IF APPLICABLE) SHALL HAVE A MIN. 2% SLOPED 6. ALL WORK SHALL BE PERFORMED BY LICENSED CONTRACTOR AS MANDATED BY LOCAL AUTHORITY HAVING JURISDICTION WITH NO EXCEPTION. . WHEN SOLAR PANEL IS REQ'D, SOLAR PLANS SHALL BE REVIEWED & APPROVED BY CITY / INSPECTOR PRIOR TO ROOF SHEATHING INSPECTION.

PROJECT TEAM

ARCHITECT: DUC-HUY HUYNH HU ARCHITECTURE, INC. 15551 EDEN STREET WESTMINSTER, CA 92683

SITE PLAN-PROPOSED SCALE: 1/16" = 1'-0"

**ROOF PLAN-PROPOSED** 

Copyright. Hu Architecture Inc. 2018. All rights reserved.

This drawing and its contents is copyright by Hu Architecture.

Reproducing, modifying, and distributing this material without the written permission of Hu Architecture is prohibited.

DATE Issue Date **SCALE** Huntington Beach, CA 92649 PROJECT NUMBER SHEET

COVER SHEET & SITE PLAN / ROOF PLAN

(714) 476-4751 SCALE: 3/32" = 1'-0" duchuy@huarchitecture.com NO. DATE DESCRIPTION CONSULTANT INFORMATION Hu-? architecture **CLIENT INFORMATION 16471 MALDEN RESIDENCE - NEW HOUSE** I, DUC-HUY HUYNH, AM THE DESIGN LIKE YOU CARE! COORDINATE PROFESSIONAL **LOCATION:** 16471 Malden Cir ON THIS PROJECT: 15551 Eden Street duchuy@huarchitecture.com 16471 Malden Cir "16471 MALDEN RESIDENCE -Westminster, CA 92683 (714) 476-4751 Huntington Beach, CA 92649 **NEW HOUSE"** 

GLASS/GLAZING

HOLLOW METAL

INSIDE DIAMETER

HORIZONTAL

INCLUDING

INFORMATION

INSULATION

INTERIOR

JOINT

HEIGHT

GWB HGT

HVAC

INSUL INT

GYPSUM WALL BOARD

HEATING, VENTILATING & AIR CONDITIONING

CHECKED

DHH


2023.121

DRAWN


AS NOTED

**G001** 


DWG

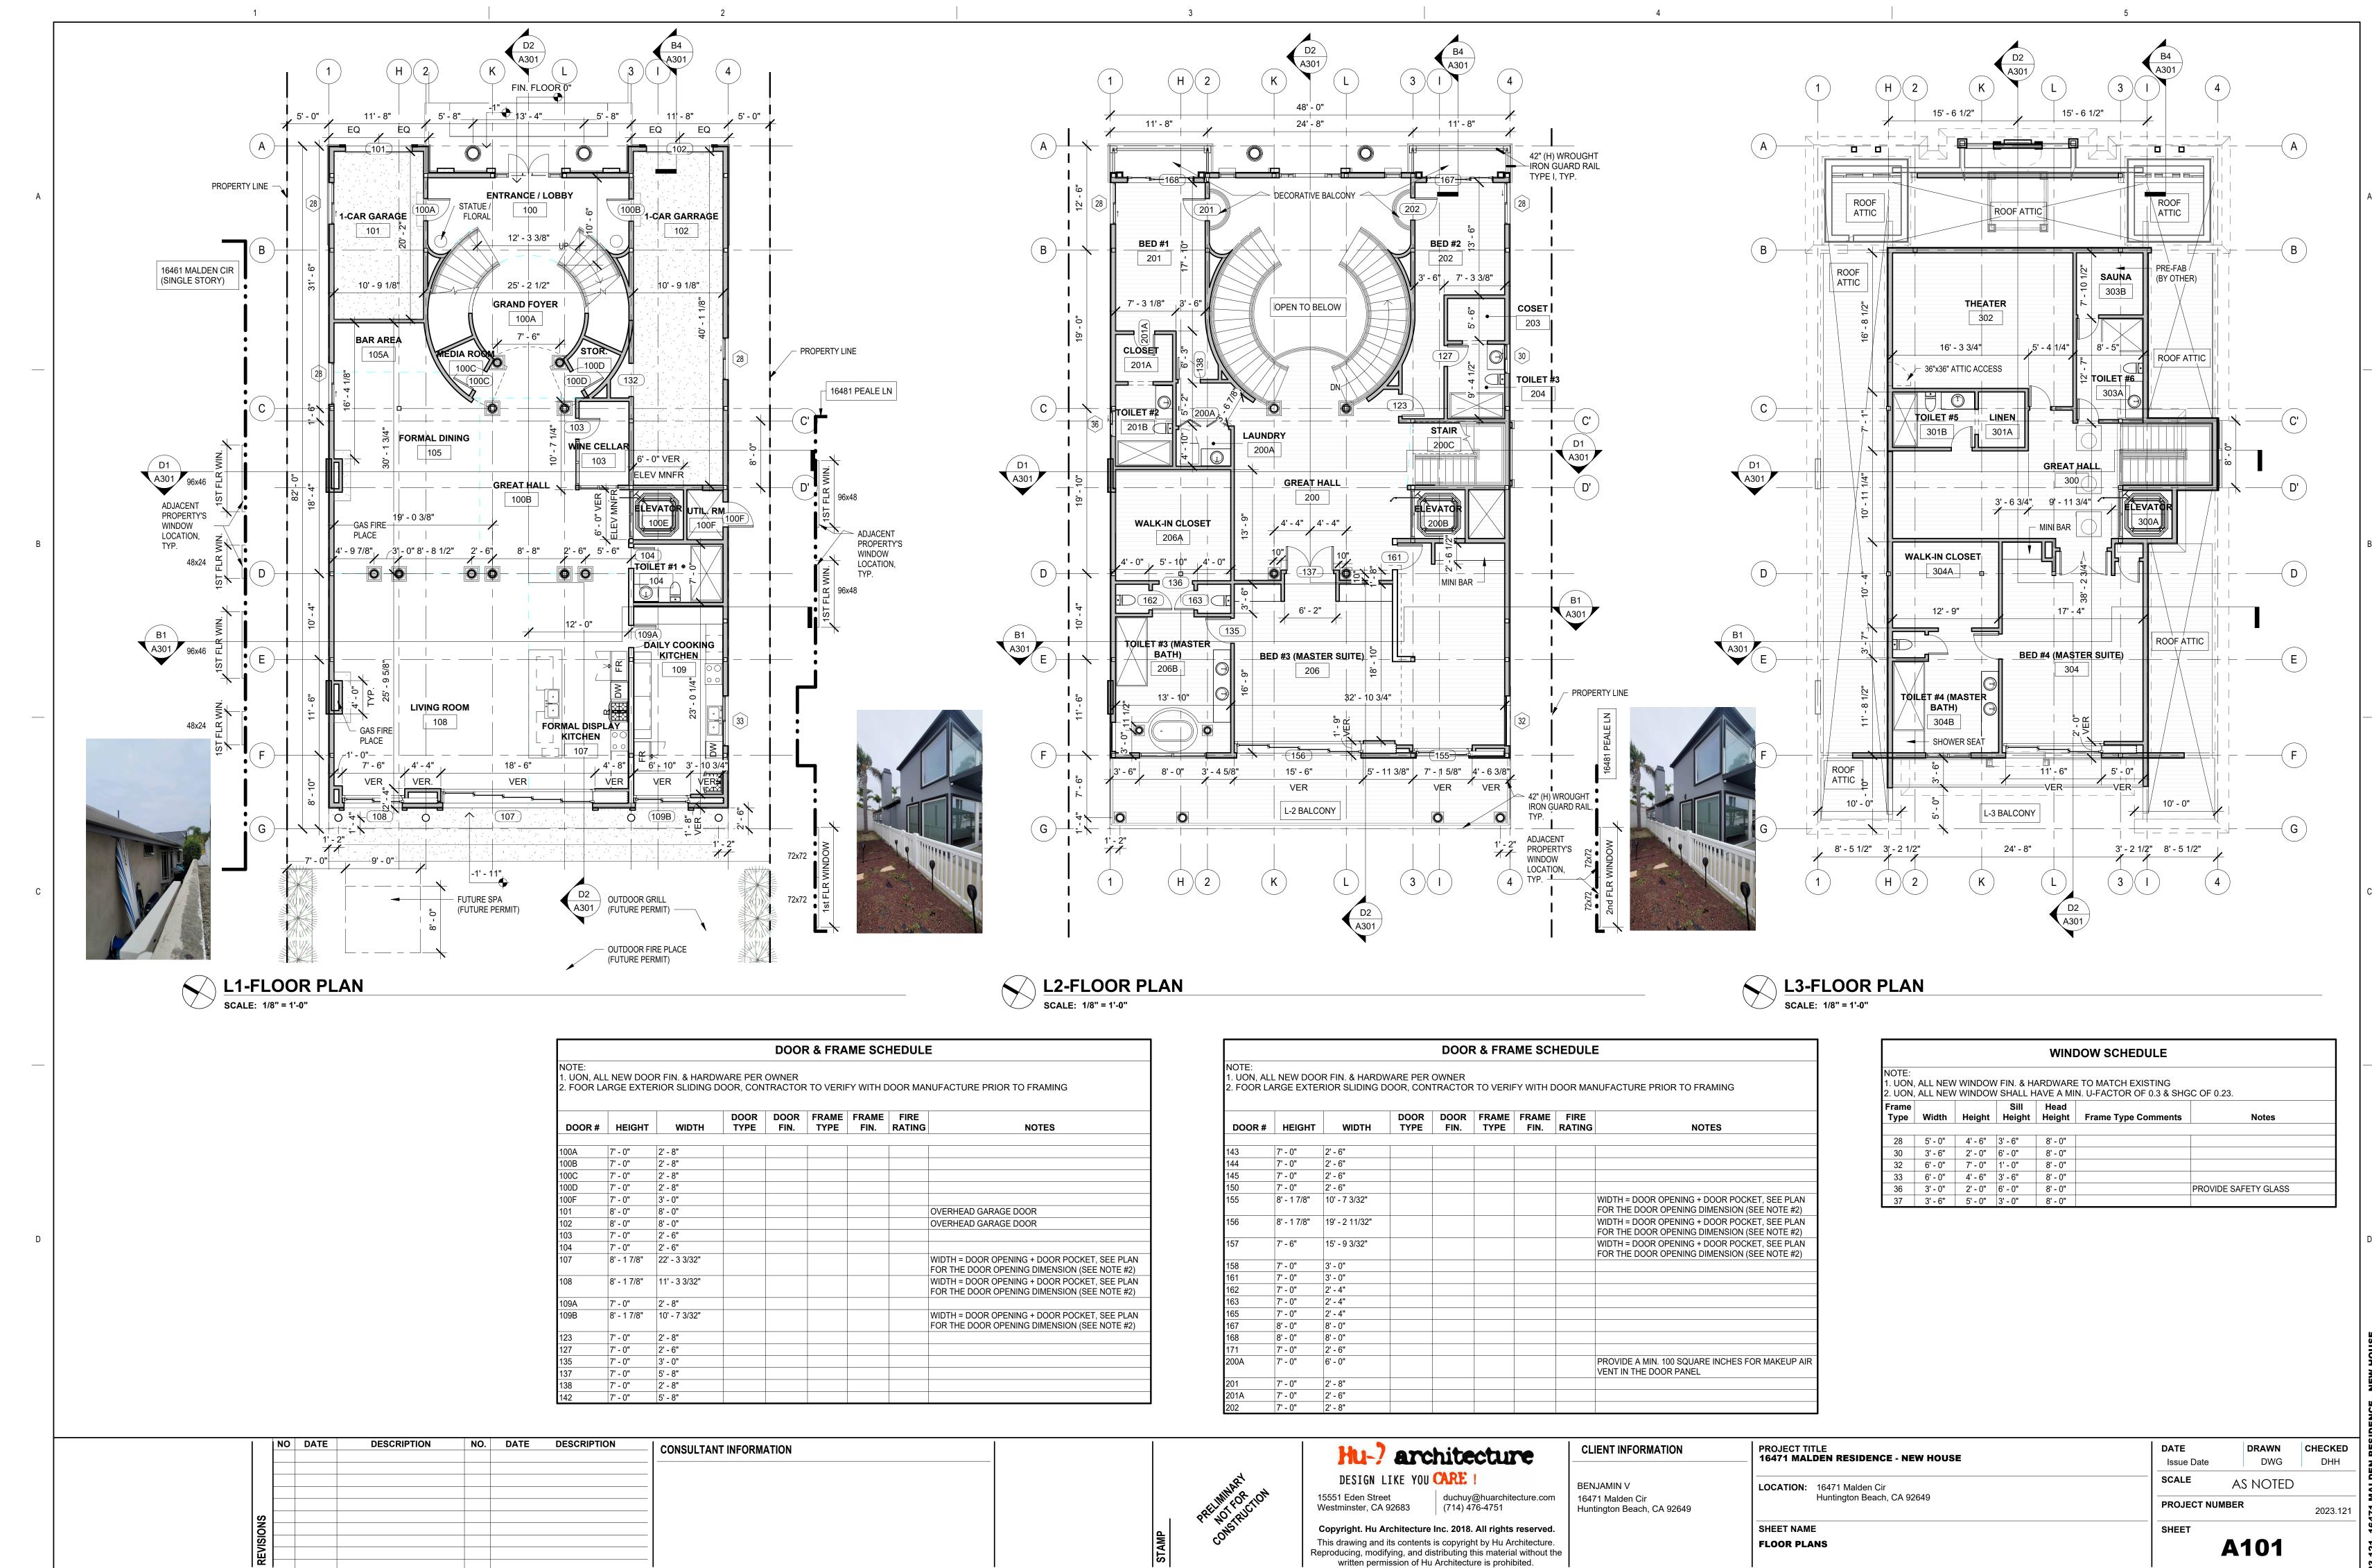

11/13/2024 2:03:04 PM

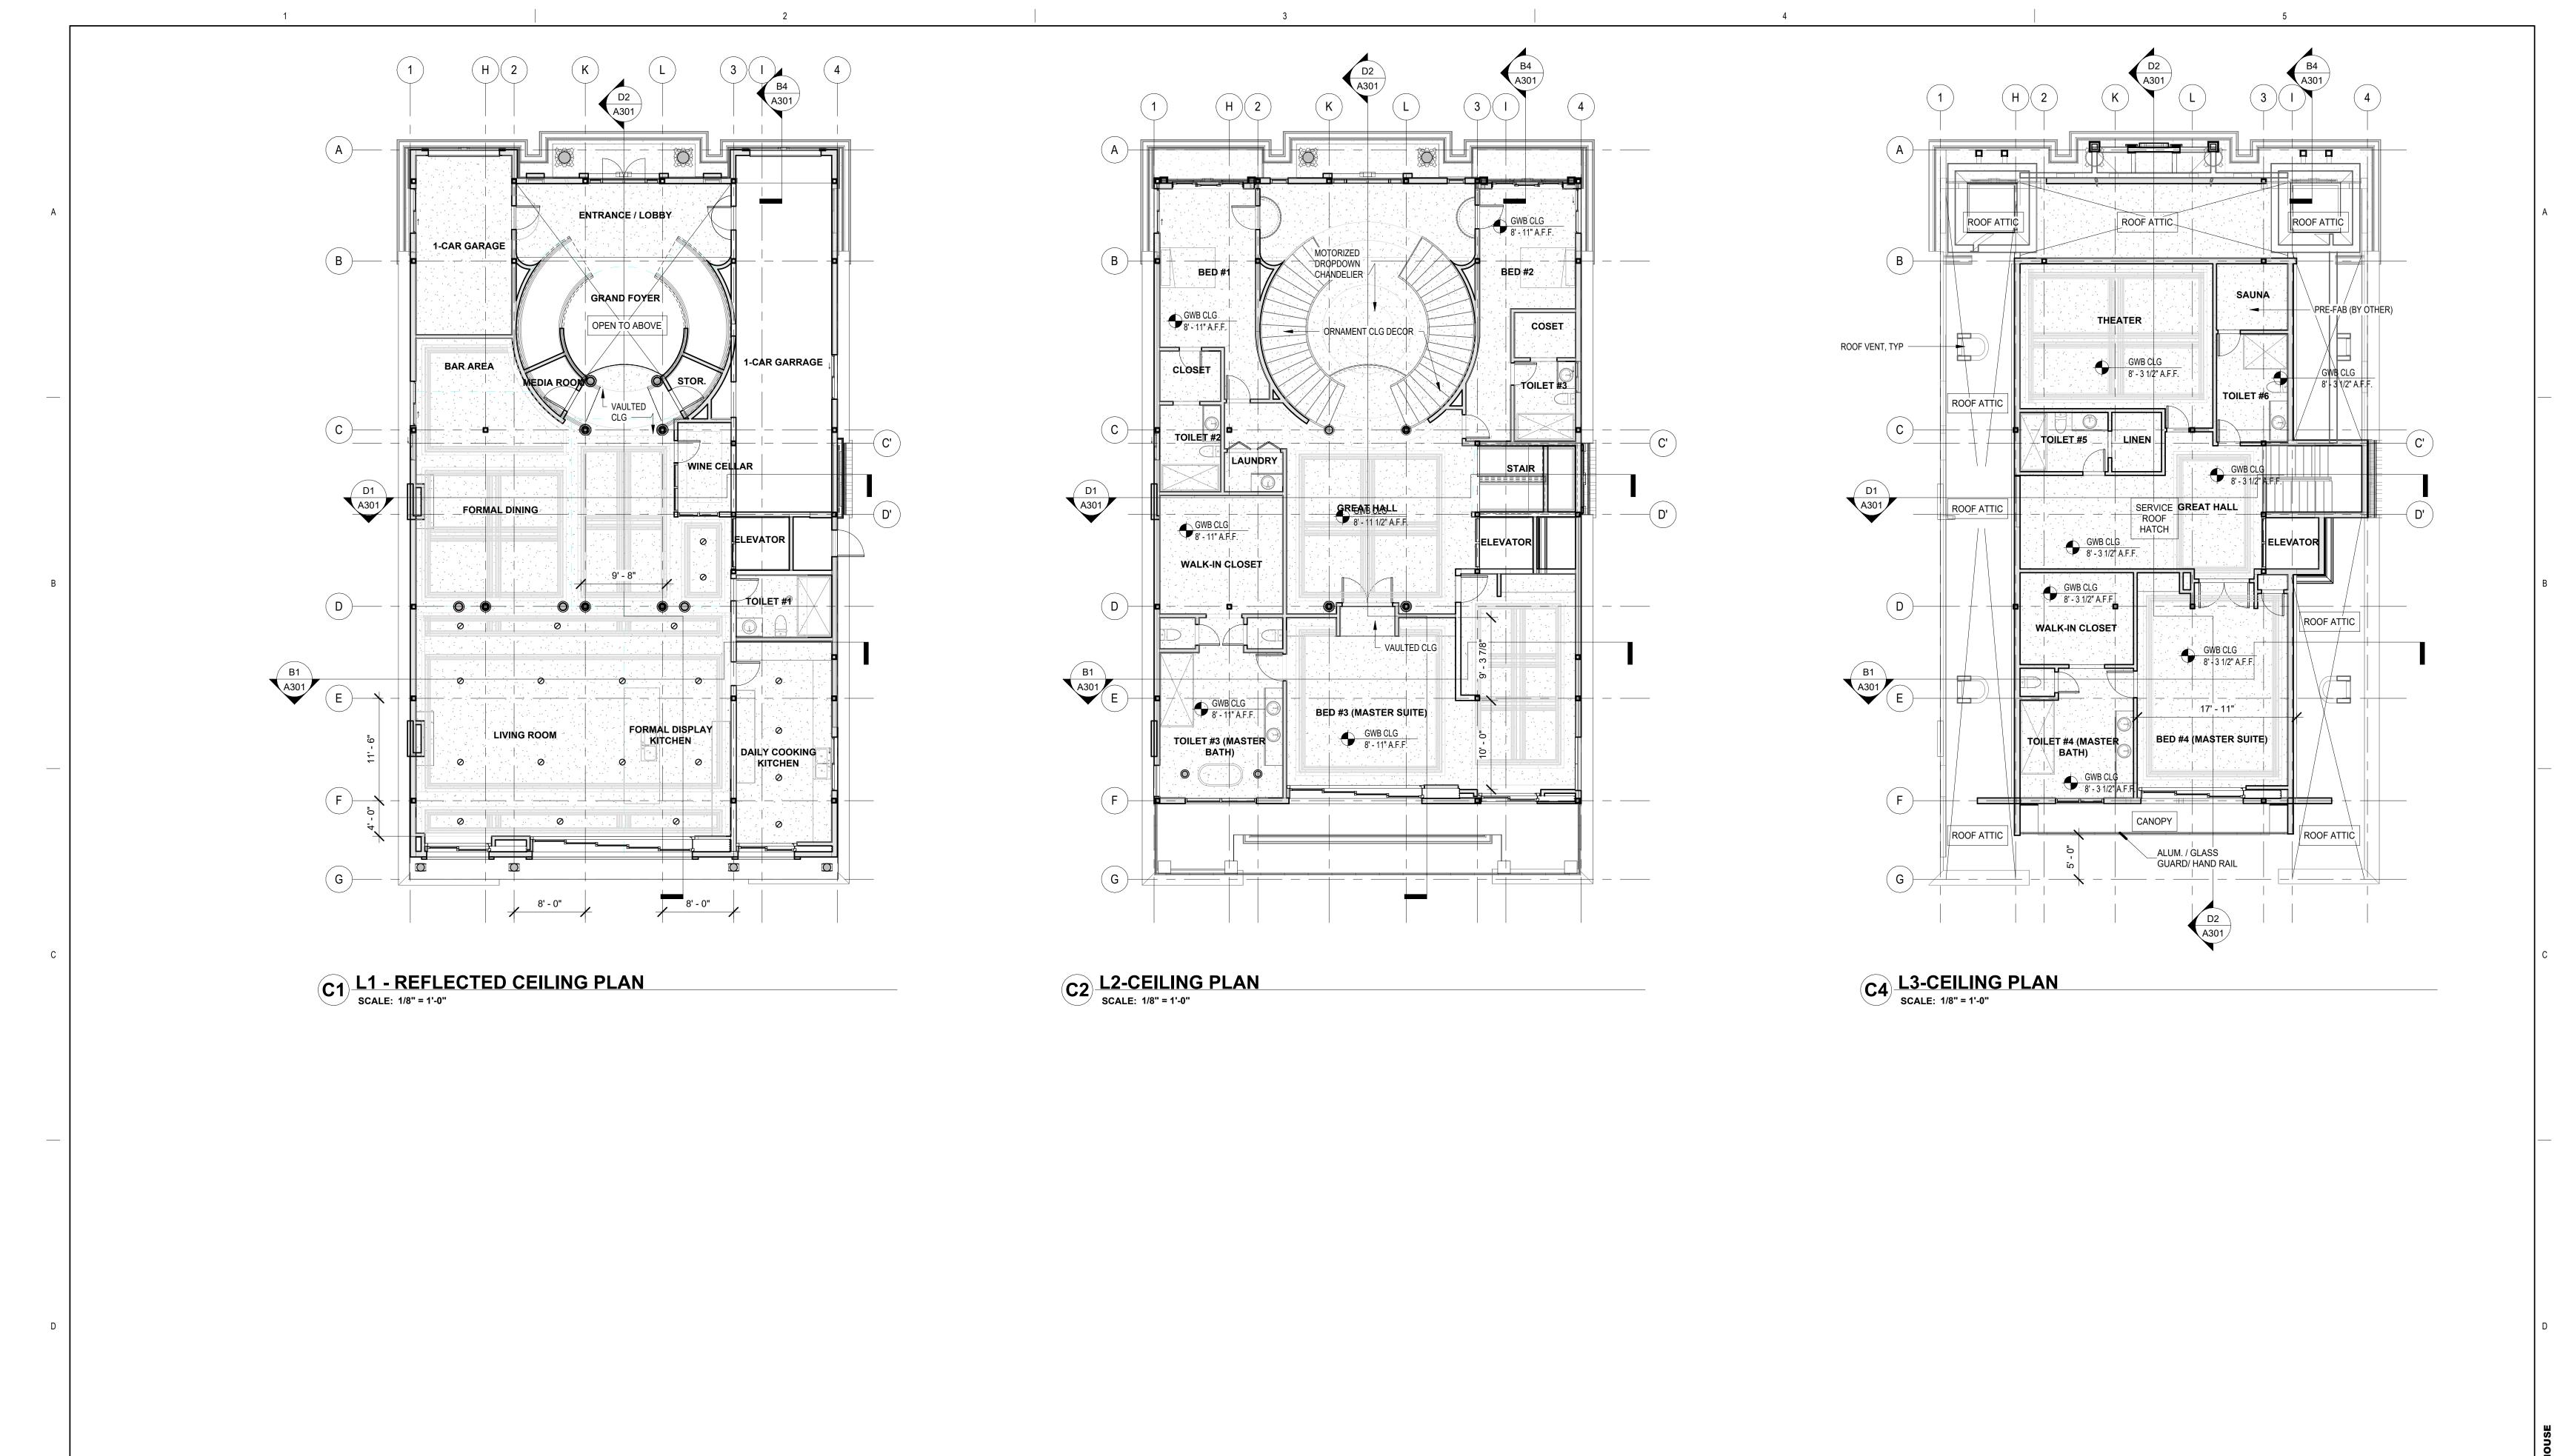

DESCRIPTION NO. DATE DESCRIPTION CONSULTANT INFORMATION

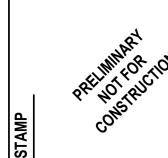

### Hu-) architecture DESIGN LIKE YOU CARE!

15551 Eden Street

duchuy@huarchitecture.com (714) 476-4751 Westminster, CA 92683


Copyright. Hu Architecture Inc. 2018. All rights reserved. This drawing and its contents is copyright by Hu Architecture.

Reproducing, modifying, and distributing this material without the written permission of Hu Architecture is prohibited.

**CLIENT INFORMATION** BENJAMIN V 16471 Malden Cir Huntington Beach, CA 92649 PROJECT TITLE
16471 MALDEN RESIDENCE - NEW HOUSE LOCATION: 16471 Malden Cir Huntington Beach, CA 92649 SHEET NAME




C1 NORTH ELEVATION SCALE: 3/16" = 1'-0"

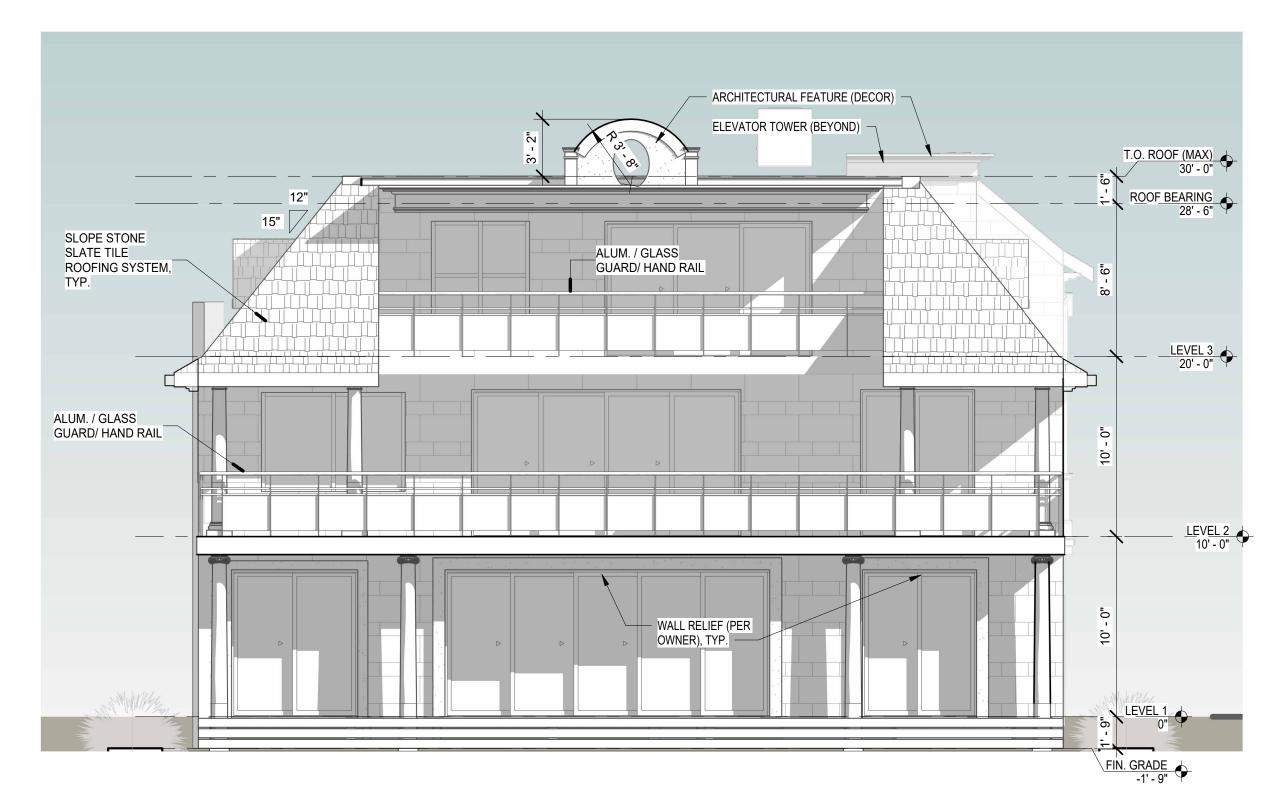

NO. DATE DESCRIPTION


D1 SOUTH ELEVATION
SCALE: 3/16" = 1'-0"

DESCRIPTION

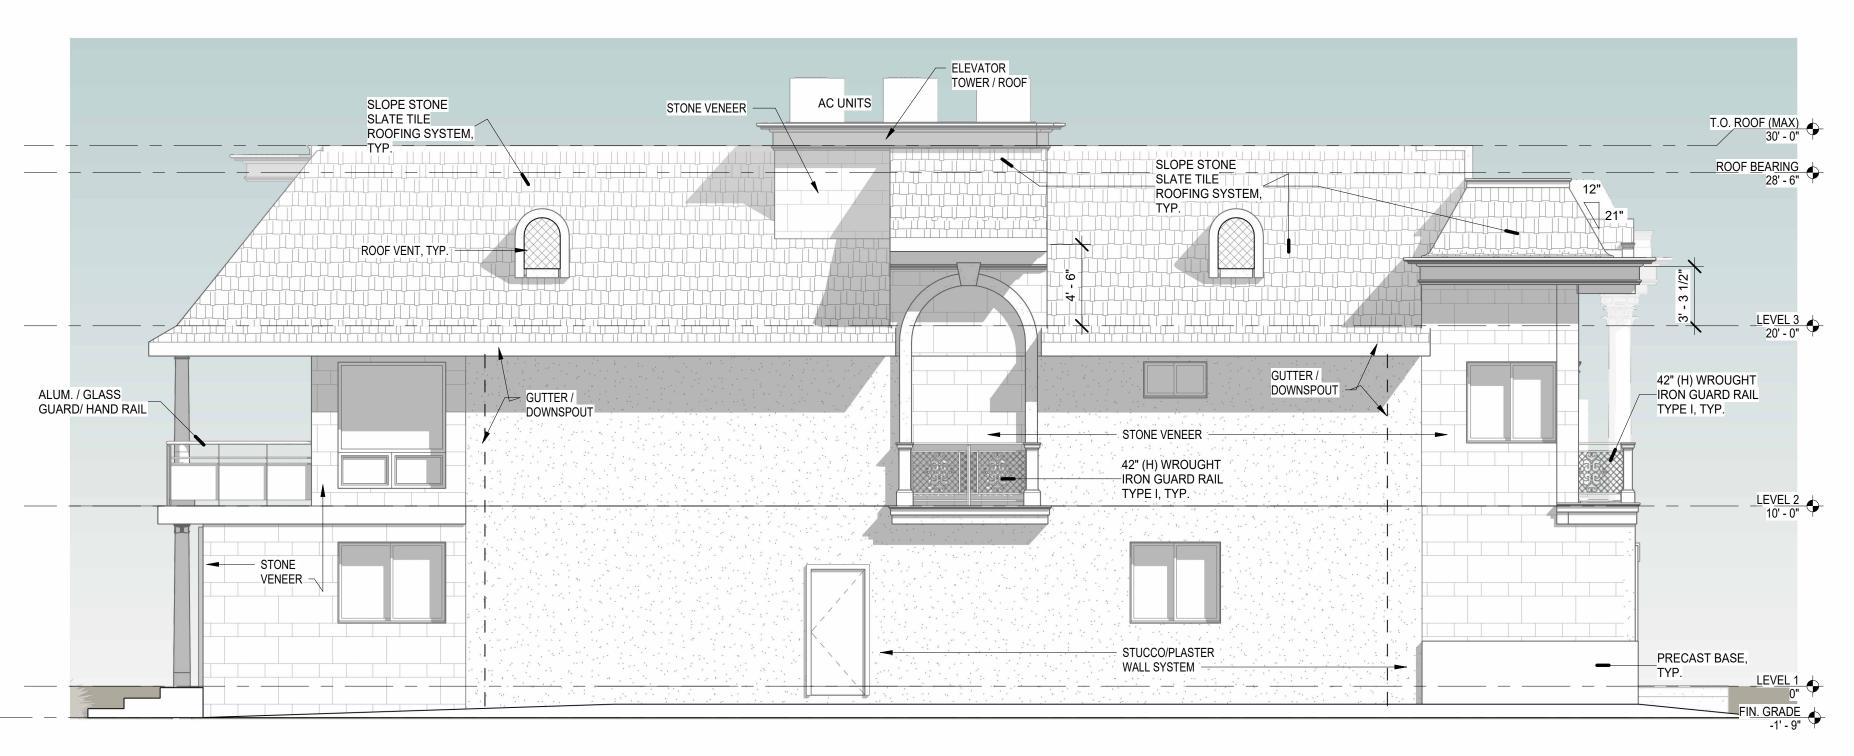

C3 EAST ELEVATION

SCALE: 3/16" = 1'-0"

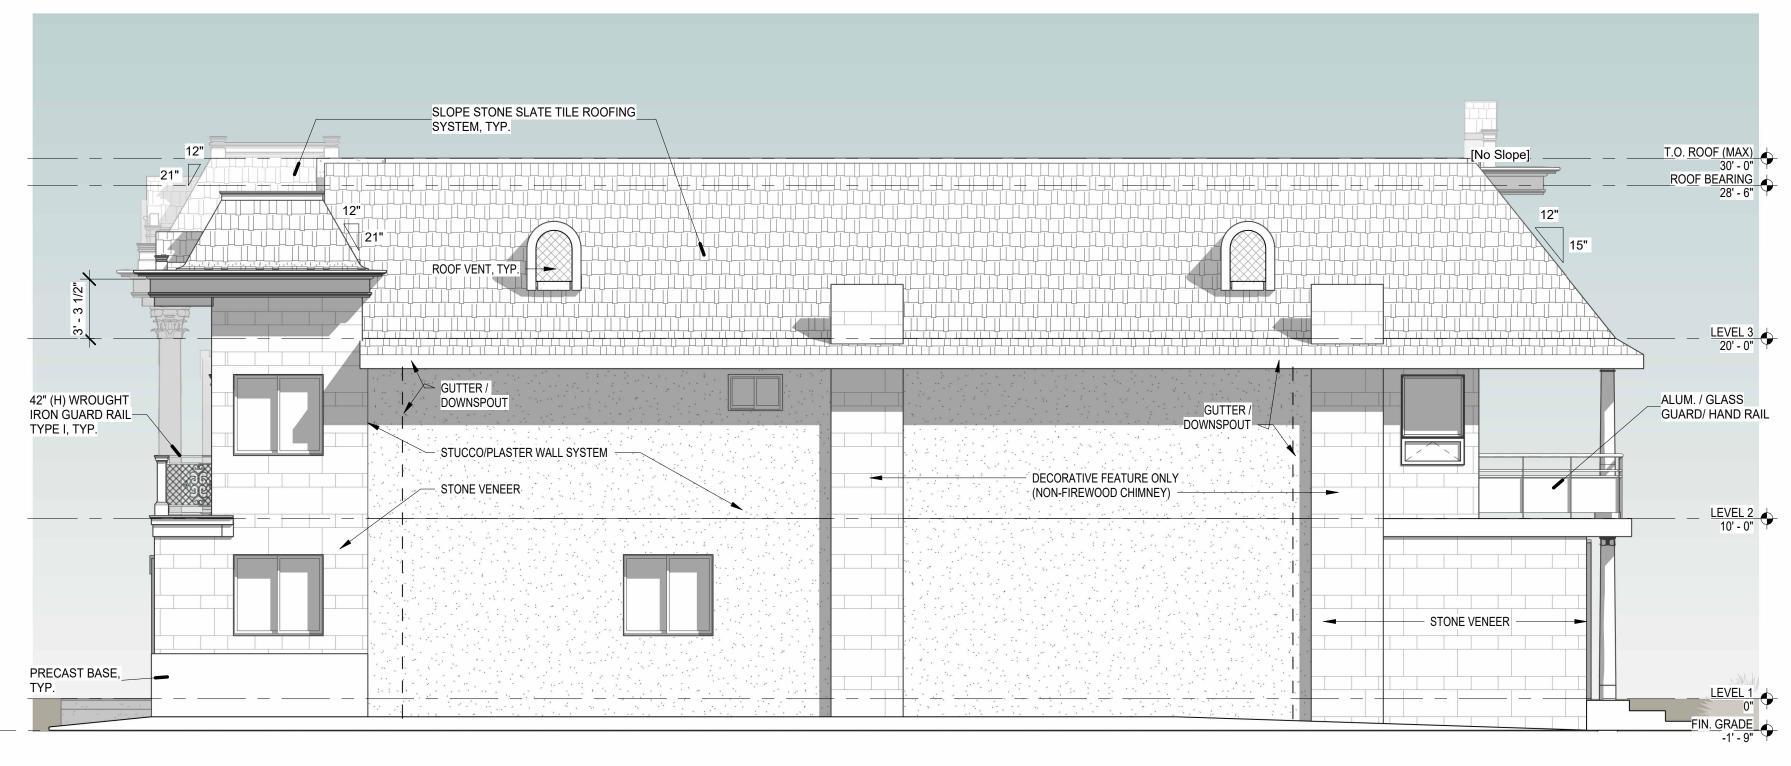

D3 WEST ELEVATION

SCALE: 3/16" = 1'-0"

ELEVATION NOTES:
CONTRACTOR TO VERIFY SITE
CONDITION SO T.O. ROOF SHALL NOT
EXCEED 30F & T.O. ALL ARCHITECTURAL
DECOR ELEMENTS SHALL NOT EXCEED
35FT FROM THE FIN. STREET CURB, TYP.

CONSULTANT INFORMATION



Hu-? architecture DESIGN LIKE YOU CARE!

duchuy@huarchitecture.com (714) 476-4751 15551 Eden Street Westminster, CA 92683

Copyright. Hu Architecture Inc. 2018. All rights reserved. This drawing and its contents is copyright by Hu Architecture.

Reproducing, modifying, and distributing this material without the written permission of Hu Architecture is prohibited.

CLIENT INFORMATION		
BENJAMIN V		
16471 Malden Cir Huntington Beach, CA 92649		

PROJECT TITLE
16471 MALDEN RESIDENCE - NEW HOUSE LOCATION: 16471 Malden Cir Huntington Beach, CA 92649 SHEET NAME

