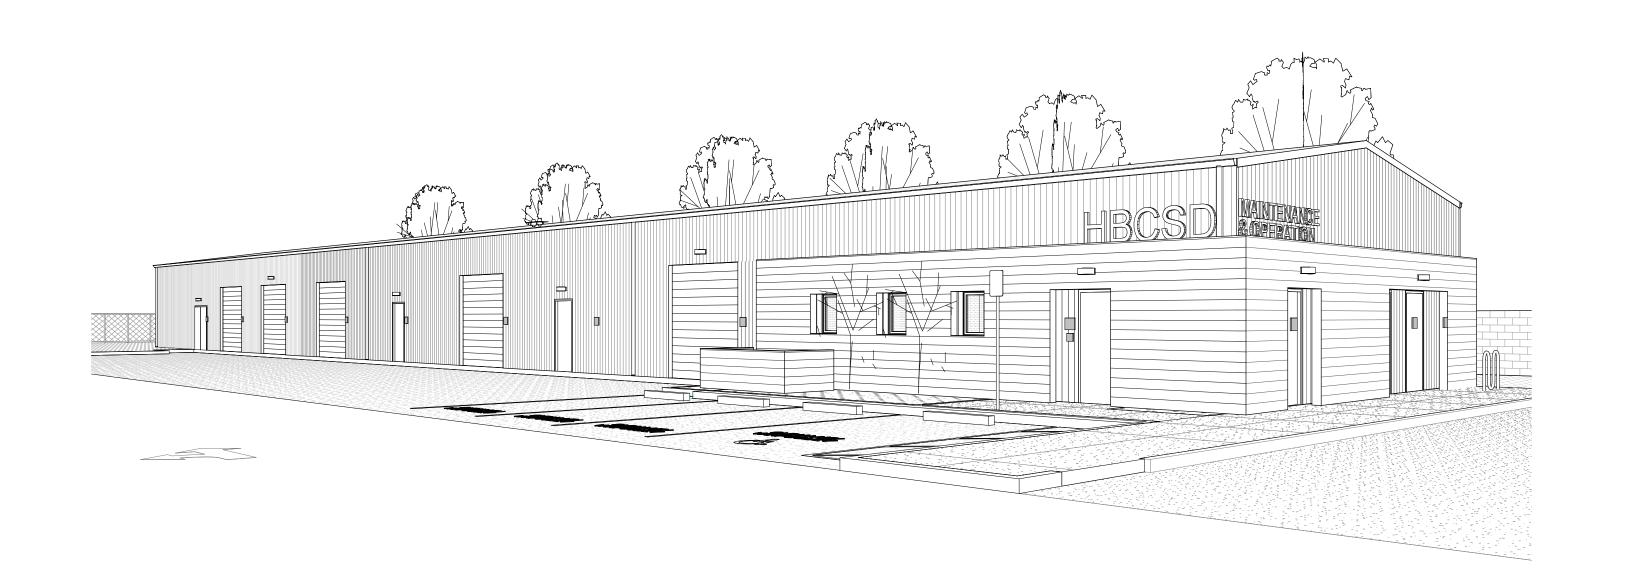
## KETTLER EDUCATIONAL CENTER

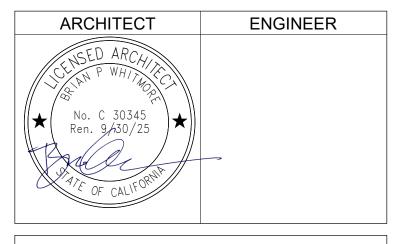
M&O BUILDING 8750 DORSETT DRIVE HUNTINGTON BEACH, CA 92646 HUNTINGTON BEACH CITY SCHOOL DISTRICT



CODES AND REGULATIONS	DRAWING INDEX	PROJECT DIRECTORY	PROJECT DESCRIPTION	SI	ITE MATRIX	
APPLICABLE STATE CODES AND REGULATIONS WITH LATEST AMENDMENTS AND SUPPLEMENTS.  SPECIAL DIVERS AND REGULATIONS WITH LATEST AMENDMENTS AND SUPPLEMENTS.  2022 CALLEFORMA SMEDIAGE GODE (CBG), PART 2, TITLE 24 CCR (2021 BC & CALLEFORMA SMEDIAGEN) AND SMEDIAGEN AMENDMENTS.  2022 CALLEFORMA AMENDMENTS.  2022 CALLEFORMA AMENDMENTS.  2022 CALLEFORMA MEDIAGLAC CODE (CGC), PART 3, TITLE 24 CCR (2016 ACALEFORMA MEDIAGLAC) CODE (CPC), PART 3, TITLE 24 CCR (2016 ACALEFORMA PLUMBING CODE (CPC), PART 4, TITLE 24 CCR (2018 ACALEFORMA PLUMBING CODE (CPC), PART 6, TITLE 24 CCR (2018 ACALEFORMA PLUMBING CODE (CPC), PART 6, TITLE 24 CCR (2018 ACALEFORMA PLUMBING CODE (CPC), PART 6, TITLE 24 CCR (2018 ACALEFORMA PLUMBING CODE (CPC), PART 6, TITLE 24 CCR (2018 ACALEFORMA PLUMBING CODE (CPC), PART 6, TITLE 24 CCR (2018 ACALEFORMA PLUMBING CODE (CPC), PART 6, TITLE 24 CCR (2018 ACALEFORMA PRICE COME, PART 6	SHT. NO.  DESCRIPTION  CENERAL  A0.1   COVER SHEET   A0.2   GENERAL NOTES   A0.3   ARCHITECTURAL SYMBOLS AND ABBREVIATIONS   A0.4   CODE ANALYSIS AND FIRE ACCESS SITE PLAN   A0.5   CODE ANALYSIS FLOOR PLAN   CIMIL  C1.3   FRELIMINARY GRADING PLAN   C1.5   FRELIMINARY UTILITY PLAN   ARCHITECTURAL   A1.9   ENLARGED SITE PLAN   A1.9   ENLARGED SITE PLAN   A2.1   FLOOR PLAN   ROOP   A5.1   EXTERIOR ELEVATIONS   A6.2   COLORED ENTERIOR ELEVATIONS   A6.1   BUILDING SECTIONS   TOTAL SHEET COUNT: 12	CLIENT HUNTINGTON BEACH CITY SCHOOL DISTRICT HUNTINGTON BEACH CITY SCHOOL DISTRICT 8750 DORSETT DR HUNTINGTON BEACH, CA 92646 [T] (74) 964-898 [LEISA WINSTON, ADMIN. TO SUPERINTEDENT  ARCHITECT STUDIO W ARCHITECTS  BRIAN WHITMORE, PRINCIPAL 980 9TH STREET SACRAMENTO, CA 95814 [T] (916) 294-500 BrianW@StudioW-Architects.com  TONY PACHECO-TAYLOR, CLIENT LEADER 424 32ND STRETT, SUITE DIE NEWPORT BEACH, CA 92693 [T] (499) 774-2906 Tony@gStudioW-Architects.com  CIVIL ENGINEER KPF JESUS PEREZ 18400 VON KARMAN AVE., SUITE 600 IRVINE, CA 92612 [O] (949) 252-1022 [F] (499) 252-6022 [Jesus perez_@kptf.com	THE PROPOSED SINGLE-STORY BUILDING TO BE 7,510 GROSS SF. THIS WILL INCLUDE APPROXIMATELY 1,714 GROSS SF OF OFFICE AND SUPPORT SPACES WHERE THE 14 MAINTENANCE AND OPERATION STAFF WILL WORK WHEN ON SITE. THE 1,951 GROSS SF DEDICATED TO AREAS WHERE MAINTENANCE WORK WILL OCCUR WILL BE DEDICATED TO WOOD WORKING, METAL WORKING, GROUNDSKEEPING AND LIGHT MECHANIC WORK. THE REMAINING 3,845 GROSS SF OF THE BUILDING WILL BE USED TO HOUSE THE DISTRICTS MAINTENANCE MATERIALS THAT WILL DE STORDE HERE FOR USE ON SCHOOL SITES. CEQA ANALYSIS WILL BE CONDUCTED BY HECSD.  HOURS AND DAYS OF OPERATION: MONDAY THROUGH FRIDAY – 7:90 AM TO 4:00 PM  NUMBER OF EMPLOYEES: 14  ADDRESS: 8750 DORSETT DRIVE HUNTINGTON BEACH, CALIFORNIA 92646 APN: 148-113-42 SITE AREA: 209,088 SQ. FT / 4:80 ACRES  LEGAL DESCRIPTION: ALL THAT CERTAIN LAND SITUATED IN THE STATE OF CALIFORNIA, COUNTY OF ORANGE, CITY OF HUNTINGTON BEACH, DESCRIBED AS FOLLOWS. THE WEST STAY FEET OF THE NORTH 4/25 00 FEET OF SHE SOUTHEAST ONE-QUARTER RECORDED IN BOOK 51, PAGE 14 OF MISCELLANEOUS MAPS, RECORDS OF ORANGE COUNTY, CALIFORNIA, LYING SOUTHERLY OF THE ASSETTION THAT CHERTAIN LAND STRUMENT OF THE CENTER LINE OF DORSETT LANE, AS SHOWN ON THE MAP OF TRACK 6020. RECORDED IN BOOK 51, PAGE 14 OF MISCELLANEOUS MAPS, RECORDS OF ORANGE COUNTY, CALIFORNIA, LYING SOUTHERLY OF THE ASSTERLY PROLONGATION OF THE CENTER LINE OF DORSETT LANE, AS SHOWN ON THE MAP OF TRACK 6020. RECORDED IN BOOK 51, PAGE 14 OF MISCELLANEOUS MAPS, RECORDS OF ORANGE COUNTY, CALIFORNIA, LYING SOUTHERLY OF THE ASSTERLY PROLONGATION OF THE CENTER LINE OF DORSETT LANE, AS SHOWN ON THE MAP OF TRACK 6020. RECORDED IN BOOK 523, PAGES 5, 6 AND 7 OF MICELLENEOUS MAPS, RECORDS OF ORANGE COUNTY, CALIFORNIA	SUBJECT HUNTINGTON BEACH MUNICIPAL CODE  LANDSCAPE 232.08	A MINIMUN OF 8% OF ENTIRE SITSITE = 209,088 SQ. FT. 8% = 16,727 SQ. FT.  DORSETT DR  PRY CIR NITORY  ARCEL CIR NITORY  ST.	PROVIDED  TE 24.60% = 51,439 S  NAMELL DR



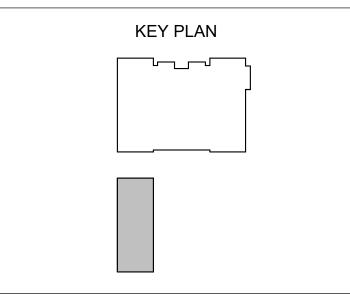
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HUNTINGTON BEACH CITY SCHOOL DISTRICT 8750 DORSETT DR HUNTINGTON BEACH, CA 92646

CUP SUBMITTAL

KETTLER EDUCATIONAL
CENTER
M&O BUILDING
8750 DORSETT DRIVE
HUNTINGTON BEACH, CA 92646

**COVER SHEET** 

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**GENERAL NOTES** 

PRIOR TO SUBMITTING PROPOSAL, BIDDER SHALL EXAMINE CONSTRUCTION DRAWINGS AND SPECIFICATIONS AND SHALL HAVE VISITED THE CONSTRUCTION SITE. HE SHALL BE FAMILIAR WITH THE CONDITIONS UNDER WHICH HE WILL HAVE TO OPERATE AND WHICH WILL IN ANY WAY AFFECT THE WORK UNDER THIS CONTRACT. THE GENERAL CONTRACTOR SHALL NOT DISPUTE. COMPLAIN OR ASSERT THAT THERE IS ANY MISUNDERSTANDING IN REGARDS TO LOCATION, EXTENT, NATURE OR AMOUNT OF WORK TO BE PERFORMED UNDER THIS CONTRACT DUE TO THE CONTRACTOR'S FAILURE TO INSPECT THE SITE. BIDDERS SHALL NOTIFY THE ARCHITECT OF ANY CONDITIONS, REQUIRING WORK, WHICH ARE NOT COVERED IN THE CONTRACT DOCUMENTS.

THERE WILL BE NO SUBSTITUTION FOR SPECIFIED ITEMS WITHOUT PRIOR APPROVAL UNLESS OTHERWISE NOTED. REQUESTS FOR SUBSTITUTIONS SHALL BE MADE IN ACCORDANCE WITH GENERAL CONDITIONS & DIVISION 1 THE GENERAL BUILDING CONTRACTOR SHALL BE RESPONSIBLE FOR OBTAINING AND PAYING FOR ALL PERMITS REQUIRED BY GOVERNING AGENCIES IN ORDER TO PERFORM THE WORK.

THE FINAL LOCATION OF ALL ELECTRICAL AND SIGNAL EQUIPMENT, PANEL BOARDS, FIXTURES, ETC., SHALL BE APPROVED BY OWNER PRIOR TO INSTALLATION. DEFINITIONS

"TYPICAL" MEANS IDENTICAL FOR ALL CONDITIONS, UNLESS OTHERWISE NOTED. "SIMILAR" MEANS COMPARABLE CHARACTERISTICS FOR THE CONDITION NOTED. VERIFY DIMENSIONS AND ORIENTATIONS. "PROVIDE" MEANS TO FURNISH AND INSTALL

"FURNISH" MEANS TO FURNISH AND OTHERS WILL INSTALL.

DIMENSIONING RULES: ALL HORIZONTAL DIMENSIONS SHALL BE TO FACE OF STUD OR TO CENTERLINE OF COLUMN GRID LINE, U.O.N DIMENSIONS NOTED "CLEAR", "CLR", OR "MINIMUM" MUST BE PRECISELY MAINTAINED DIMENSIONS CAN NOT BE MODIFIED WITHOUT APPROVAL OF THE

VERTICAL DIMENSIONS ARE FROM TOP OF FLOOR SLAB UNLESS THERWISE NOTED. DO NOT SCALE DRAWINGS. IF ANY ITEM OF WORK CANNOT BE LOCATED, DO NOT PROCEED WITH THE WORK WITHOUT THE

ARCHITECT UNLESS OTHERWISE NOTED.

ARCHITECT'S APPROVAL. DIMENSIONS MARKED "V.I.F." OR "VERIFY" SHALL BE VERIFIED BY THE CONTRACTOR PRIOR TO THE START OF CONSTRUCTION. VERIFY ALL ROUGH OPENING DIMENSIONS FOR FABRICATED ITEMS WITH THE MANUFACTURER PRIOR TO PROCEEDING WITH CONSTRUCTION.

PROVIDE REQUIRED BACKING, BLOCKING, AND BRACING FOR ALL WALL -MOUNTED FIXTURES, ACCESSORIES AND EQUIPMENT. VERIFY AND COORDINATE WALLS THAT MAY REQUIRE NON-TYPICAL THICKNESS OR FRAMING DUE TO ELECTRICAL, MECHANICAL, PLUMBING, STRUCTURAL AND/OR EQUIPMENT REQUIREMENTS. ALL GLAZING SHALL CONFORM TO FEDERAL GLAZING REGULATIONS AND CHAPTER 24, CBC. ALL CONTRACTORS SHALL REMOVE TRASH AND DEBRIS STEMMING FROM

THEIR WORK ON A DAILY BASIS. PROJECT SITE SHALL BE MAINTAINED IN A CLEAN AND ORDERLY CONDITION THE CONTRACTOR SHALL BE RESPONSIBLE FOR REMOVING ALL LEFT-OVER MATERIALS, DEBRIS, TOOLS AND EQUIPMENT INVOLVED IN HIS OPERATIONS AT THE CONCLUSION OF THE INSTALLATION. HE SHALL LEAVE ALL AREAS CLEAN AND FREE FROM DUST. HAZARDOUS MATERIALS: THE ARCHITECT AND THE ARCHITECT'S

CONSULTANTS SHALL HAVE NO RESPONSIBILITY FOR THE DISCOVERY. PRESENCE, HANDLING, REMOVAL, DISPOSAL OF OR EXPOSURE OF PERSONS TO ASBESTOS OR HAZARDOUS OR TOXIC SUBSTANCES IN ANY FORM AT THE PROJECT SITE, PROFESSIONAL SERVICES RELATED OR IN ANY WAY CONNECTED WITH THE INVESTIGATION, DETECTION, ABATEMENT, REPLACEMENT, USE, SPECIFICATION, OR REMOVAL OF PRODUCTS, MATERIALS, OR PROCESSES CONTAINING ASBESTOS OR HAZARDOUS OR TOXIC MATERIALS ARE BEYOND THE SCOPE OF THIS AGREEMENT. THE GENERAL CONTRACTOR & SUBCONTRACTORS ARE RESPONSIBLE FOR LOCATING & VERIFYING ALL EXISTING UNDERGROUND UTILITIES IN ALL AREAS OF NEW WORK PRIOR TO COMMENCEMENT OF EXCAVATION. EXISTING UTILITIES SHOWN ON THE DRAWING ARE APPROXIMATE ROUTING LOCATION AS BEST DETERMINED FROM EXISTING DRAWINGS AND THE SCHOOL DISTRICT, BUT SHOULD NOT BE CONSTRUED TO REPRESENT ALL THE EXISTING UNDERGROUND UTILITIES.

ALL TEMPORARY WORK SHALL BE CONSIDERED A PART OF THIS CONTRACT AND NO EXTRA CHARGES WILL BE ALLOWED. THIS SHALL INCLUDE MINOR ITEMS OF MATERIAL OR EQUIPMENT NECESSARY TO MEET THE REQUIREMENTS AND INTENT OF THE PROJECT. ALL WALL PENETRATIONS TO EXTERIOR WALLS SHALL BE SEALED AIR/WATER TIGHT. ALL INTERIOR PENETRATIONS SHALL BE SEALED TO PROVIDE A

PROFESSIONAL AND FINISHED APPEARANCE. THE DRAWINGS AND SPECIFICATIONS DO NOT UNDERTAKE TO SHOW OR LIST EVERY ITEM TO BE PROVIDED, BUT RATHER TO DEFINE THE REQUIREMENTS FOR A FULL AND WORKING SYSTEM FROM THE STANDPOINT OF THE FND USER. FOR THIS REASON, WHEN AN ITEM NOT SHOWN OR LISTED IS CLEARLY NECESSARY FOR PROPER USE CONTROL/ OPERATION OF EQUIPMENT WHICH IS SHOWN OR LISTED, PROVIDE ALL ITEMS WHICH WILL ALLOW THE SYSTEM TO FUNCTION PROPERLY AT NO INCREASE IN CONTRACT PRICE OR TIME. THE DETAILS REFLECT THE DESIGN INTENT FOR TYPICAL CONDITIONS. THE CONTRACTOR SHALL VERIFY ALL FIELD CONDITIONS AND SHALL INCLUDE, IN

ANOMALIES, OF ALL TRADES. ALL WORK SHALL CONFORM TO CALIFORNIA CODES, TRADE STANDARDS WHICH GOVERN EACH PHASE OF THE PROJECT, AND ALL APPLICABLE LOCAL CODES AND AUTHORITIES HAVING JURISDICTION. THIS DRAWING SET SHALL BE USED IN CONJUNCTION WITH THE CSI FORMAT

PROJECT MANUAL PUBLISHED IN BOOK FORM, COMBINED, THEY ARE THE

HIS SCOPE. THE COST FOR COMPLETE FINISHED INSTALLATIONS, INCLUDING

NO WORK SHALL COMMENCE WITH UNAPPROVED MATERIALS. ANY WORK DONE WITH UNAPPROVED MATERIALS AND EQUIPMENT IS AT THE CONTRACTOR'S RISK. SEE SPECIFICATIONS FOR SUBMITTAL AND SUBSTITUTION REQUIREMENTS. CONSTRUCTION MATERIAL STORED ON THE SITE SHALL BE PROPERLY STACKED AND PROTECTED TO PREVENT DAMAGE OR DETERIORATION. FAILURE IN THIS REGARD MAY BE CAUSE FOR REJECTION OF MATERIAL

AND/OR WORK. SECURITY OF MATERIALS ARE THE SOLE RESPONSIBILITY OF CONTRACTOR. ALL EQUIPMENT/CABINETS SHALL BE FABRICATED FROM FIELD VERIFIED DIMENSIONS AND APPROVED SHOP DRAWINGS. COORDINATE MECHANICAL, PLUMBING AND ELECTRICAL EQUIPMENT WITH THIS WORK. THE CONTRACTOR SHALL BE RESPONSIBLE FOR ALL DAMAGE AND COSTS ATTRIBUTED TO RAIN WATER DAMAGE DURING THE DURATION OF THIS PROJECT. PROTECT AREAS FROM DAMAGE WHICH MAY OCCUR DUE TO TEMPERATURES, WIND, DUST, WATER, ETC. PROVIDE AND MAINTAIN

TEMPORARY BARRICADES, CLOSURE WALLS, ETC., AS REQUIRED DURING

RESPONSIBLE FOR REMEDIAL WORK IF RELATED WORK IS CONTINUED AFTER

CONSTRUCTION. MAINTAIN EXISTING PEDESTRIAN ACCESS ALONG EXISTING ADJACENT 26. ALL PUBLIC IMPROVEMENTS SHALL BE MADE IN ACCORDANCE WITH THE LATEST ADOPTED CITY/COUNTY STANDARDS. ALL TYPICAL DETAILS SHALL APPLY UNLESS NOTED OTHERWISE. NOTIFY THE ARCHITECT IN WRITING AND SEEK CLARIFICATION IF ANY DISCREPANCIES OR OMISSIONS ARE FOUND. CONTRACTOR SHALL BE

A DISCREPANCY IS IDENTIFIED.

"EXISTING".

NEW FINISHES AND CONSTRUCTION SHALL BE PROTECTED BY THE CONTRACTOR FROM POTENTIAL DAMAGE CAUSED BY CONSTRUCTION ACTIVITY. DAMAGE TO FINISHES OR CONSTRUCTION SHALL BE REPAIRED OR REPLACED (OWNER'S DECISION) BY THE CONTRACTOR WITH IDENTICAL MATERIAL AND/OR FINISHES. CONTRACTOR SHALL MAKE AND MAINTAIN A PHOTOGRAPHIC RECORD NOTEBOOK WITH DATED/INDEXED PHOTOGRAPHS SEE ELECTRICAL DRAWINGS FOR INFORMATION RELATED TO TELECOMMUNICATION EQUIPMENT, POWER, AND LIGHTING FIXTURES AND EQUIPMENT. SEE ARCHITECTURAL PLANS, REFLECTED CEILING PLAN AND INTERIOR ELEVATIONS FOR COORDINATED EQUIPMENT LOCATIONS. IF NOT SHOWN, CONTACT ARCHITECT FOR REVIEW AND DECISION. PROVIDE ACCESS DOORS REQUIRED FOR ACCESS TO CONCEALED

MECHANICAL, PLUMBING, AND ELECTRICAL EQUIPMENT. ALL NOTED WORK IS UNDERSTOOD TO BE NEW, UNLESS LABELED AS "(E)" OR SUPPLEMENTAL GENERAL NOTES

THESE DRAWINGS DO NOT CONTAIN THE NECESSARY COMPONENTS FOR CONSTRUCTION SAFETY. LOCATIONS OF ALL UTILITIES SHOWN ARE APPROXIMATE AND CONTRACTOR SHALL EXERCISE EXTREME CAUTION IN EXCAVATING AND TRENCHING ON THIS SITE TO AVOID INTERCEPTING EXISTING PIPING OR CONDUITS. IT SHALL BE THE RESPONSIBILITY OF THE CONTRACTOR TO LOCATE ALL EXISTING UTILITIES WHETHER SHOWN HEREIN OR NOT AND TO PROTECT THEM FROM DAMAGE. THE ARCHITECT IS NOT RESPONSIBLE FOR THE LOCATION OF UNDERGROUND UTILITIES OR STRUCTURES WHETHER OR NOT SHOWN OR DETAILED AND INSTALLED BY ANY OTHER CONTRACT. THE CONTRACTOR SHALL IMMEDIATELY NOTIFY THE ARCHITECT SHOULD ANY UNIDENTIFIED CONDITIONS BE DISCOVERED. THE CONTRACTOR SHALL BEAR ALL EXPENSE OF REPAIR OR REPLACEMENT OF UTILITIES OR OTHER PROPERTY DAMAGED BY OPERATIONS

IN CONJUNCTION WITH THE EXECUTION OF THIS WORK. THESE DOCUMENTS AND THE IDEAS AND DESIGNS INCORPORATED HEREIN. AS AN INSTRUMENT OF PROFESSIONAL SERVICE, ARE THE PROPERTY OF STUDIO W ARCHITECTS, AND ARE NOT TO BE USED, IN WHOLE OR IN PART, FOR ANY OTHER PROJECT WITHOUT THE WRITTEN AUTHORIZATION OF STUDIO W ARCHITECTS. EACH BIDDER SHALL POSSESS AT THE TIME OF BID. A CLASS B OR THE

APPROPRIATE CLASS C CONTRACTOR'S LICENSE PURSUANT TO PUBLIC CONTRACT CODE SECTION 3300 AND BUSINESS AND PROFESSIONS CODE SECTION 7028.15. THE SUCCESSFUL BIDDER MUST MAINTAIN THE LICENSE THROUGHOUT THE DURATION OF THIS CONTRACT. FIRE SAFETY DURING CONSTRUCTION:

GENERAL: FIRE SAFETY DURING CONSTRUCTION SHALL COMPLY WITH 2019 CALIFORNIA FIRE CODE (CFC) CH. 33 (PART 9, TITLE 24 CCR) ACCESS ROADS: FIRE DEPARTMENT ACCESS ROADS SHALL BE ESTABLISHED AND MAINTAINED IN ACCORDANCE WITH SECTION 902. WATER SUPPLY: WATER MAINS AND HYDRANTS SHALL BE

OPERATIONAL IN ACCORDANCE WITH SECTION 903. BUILDING ACCESS: ACCESS TO BUILDINGS FOR THE PURPOSE OF FIREFIGHTING SHALL BE PROVIDED. CONSTRUCTION MATERIAL SHALL NOT BLOCK ACCESS TO BUILDINGS, HYDRANTS OR FIRE APPLIANCES. ALTERATIONS OF BUILDINGS: SHALL COMPLY WITH APPLICABLE

PROVISIONS OF SECTIONS 8704 AND 8705. DEMOLITION OF BUILDINGS: SHALL COMPLY WITH SECTION 8706 AND APPLICABLE PROVISIONS OF SECTIONS 8704 AND 8705 FIRE WATCH: MAINTAIN FIRE WATCH WHEN REQUIRED BY THE BUILDING OFFICIAL AND WHEN EXISTING FIRE PROTECTION SYSTEMS ARE SHUT DOWN FOR ALTERATIONS. FIRE WATCH SHALL REMAIN IN EFFECT UNTIL EXISTING FIRE PROTECTION SYSTEMS ARE RETURNED  ${\sf FO}$  SERVICE OR AS ALLOWED BY THE BUILDING OFFICIAL.

RESTORED TO EQUAL RATING. FIRE STOP SYSTEMS AS LISTED BY UNDERWRITERS LABORATORIES SHALL BE INSTALLED PER FIRE RESISTANCE DIRECTORY. FIRE STOP SYSTEMS SHALL BE AS SPECIFIED. NONRESIDENTIAL ENERGY STANDARDS COMPLIANCE STATEMENT (TITLE 24, A. THE DESIGN INDICATED HEREIN COMPLIES WITH THE REQUIREMENTS OF THE ENERGY CONSERVATION STANDARDS OF TITLE 24, PART 6, CALIFORNIA CODE OF REGULATIONS. THE PROPOSED BUILDINGS WILL BE IN COMPLIANCE WITH THE ENERGY CONSERVATION STANDARDS PROVIDED THEY ARE BUILT ACCORDING TO THESE DRAWINGS AND SPECIFICATIONS AND PROVIDED ANY FUTURE IMPROVEMENTS ARE COMPLETED ACCORDING TO THE REQUIREMENTS OF TITLE 24, PART 6 CALIFORNIA CODE OF REGULATIONS. THESE DRAWINGS AND SPECIFICATIONS HAVE BEEN PREPARED TO INCLUDE ALL SIGNIFICANT ENERGY CONSERVATION FEATURES REQUIRED FOR COMPLIANCE WITH THE STANDARDS. BUILDING AREAS THAT ARE UNCONDITIONED AND/OR NOT SUBJECT TO THE STANDARDS ARE INDICATED ON THE

DRAWINGS

PENETRATIONS IN FIRE RATED MATERIALS OR ASSEMBLIES SHALL BE

**ENVELOPE MANDATORY MEASURES:** INSTALLED INSULATING MATERIALS SHALL HAVE BEEN CERTIFIED BY THE MANUFACTURER TO COMPLY WITH THE CALIFORNIA QUALITY STANDARDS FOR INSULATING MATERIAL ALL INSULATING MATERIALS SHALL BE INSTALLED IN COMPLIANCE WITH THE FLAME SPREAD RATING AND SMOKE DENSITY REQUIREMENTS OF TITLE 24, PART 2, CALIFORNIA CODE OF REGULATIONS, SECTIONS 719 ALL EXTERIOR JOINTS AND OPENINGS IN THE BUILDING

ENVELOPE THAT ARE POTENTIAL AND OBSERVABLE SOURCES OF AIR LEAKAGE SHALL BE CAULKED, GASKETED, WEATHERSTRIPPED OR OTHERWISE SEALED. SITE CONSTRUCTED DOORS, WINDOWS, AND SKYLIGHTS SHALL BE CAULKED BETWEEN THE UNIT AND THE BUILDING. AND SHALL BE WEATHERSTRIPPED (EXCEPT FOR UNFRAMED GLASS

DOORS AND FIRE DOORS). MANUFACTURED DOORS AND WINDOWS INSTALLED SHALL HAVE AIR INFILTRATION RATES CERTIFIED BY THE MANUFACTURER IN ACCORDANCE WITH TITLE 24, PART 6,

CALIFORNIA CODE OF REGULATIONS, SECTION 116(a)1. MANUFACTURED FENESTRATION PRODUCTS IN THE ENVELOPE OF THE BUILDING, INCLUDING, BUT NOT LIMITED TO, WINDOWS, SLIDING GLASS DOORS, FRENCH DOORS, SKYLIGHTS, CURTAIN WALLS, AND GARDEN WINDOWS MUST BE LABELED FOR U-VALUE IN ACCORDANCE WITH THE (NFRC) NATIONAL FENESTRATION RATING COUNCIL'S INTERIM U-VALUE RATING

DEMISING WALL INSULATION SHALL BE INSTALLED IN ALL OPAQUE PORTIONS OF FRAMED WALLS (EXCEPT DOORS). PROOF LOAD TESTS FOR EXPANSION TYPE ANCHOR BOLTS: ANCHOR DIAMETER REFERS TO THE THREAD SIZE FOR THE WEDGE CATEGORY AND TO THE ANCHOR OUTSIDE DIAMETER FOR THE SLEEVE

APPLY PROOF TEST LOADS TO WEDGE & SLEEVE ANCHORS WITHOUT REMOVING THE NUT IF POSSIBLE. IF NOT, REMOVE NUT AND INSTALL A THREADED COUPLER TO THE SAME TIGHTNESS OF THE ORIGINAL NUT

USING A TORQUE WRENCH AND APPLY LOAD. FOR SLEEVE INTERNALLY THREADED CATEGORIES. VERIFY THAT THE ANCHOR IS NOT PREVENTED FROM WITHDRAWING BY A BASEPLATE OR OTHER FIXTURES. IF RESTRAINT IS FOUND. LOOSEN AND SHIM OR REMOVE FIXTURE(S) PRIOR TO TESTING. REACTION LOADS FROM TEST FIXTURES MAY BE APPLIED CLOSE TO

THE ANCHOR BEING TESTED, PROVIDED THE ANCHOR IS NOT RESTRAINED FROM WITHDRAWING BY THE FIXTURE(S). TEST EQUIPMENT IS TO BE CALIBRATED BY AN APPROVED TESTING LABORATORY IN ACCORDANCE WITH STANDARD RECOGNIZED PROCEDURES.

THE FOLLOWING CRITERIA APPLY FOR THE ACCEPTANCE OF **INSTALLED ANCHORS:** HYDRAULIC RAM METHOD: THE ANCHOR SHOULD HAVE NO OBSERVABLE MOVEMENT AT THE APPLICABLE TEST LOAD. FOR WEDGE AND SLEEVE TYPE ANCHORS. A PRACTICAL

WAY TO DETERMINE OBSERVABLE MOVEMENT IS THAT THE WASHER UNDER THE NUT BECOMES LOOSE. DROP-IN ANCHORS ARE ONLY TO BE TESTED WITH THIS METHOD. TORQUE WRENCH METHOD: THE APPLICABLE TEST TORQUE MUST BE REACHED WITHIN THE FOLLOWING LIMITS: WEDGE OR SLEEVE TYPE: ONE-HALF (1/2) TURN OF THE NUT. ONE-QUARTER (1/4) TURN OF THE NUT FOR THE 3/8 IN. SLEEVE ANCHOR ONLY.

TESTING SHOULD OCCUR 24 HOURS MINIMUM AFTER INSTALLATION

OF THE SUBJECT ANCHORS. ALL ANCHOR BOLTS OF THE EXPANSION TYPE (LOADED IN EITHER PULLOUT OR SHEAR) SHALL HAVE 50 PERCENT OF THE BOLTS (ALTERNATE BOLTS IN ANY GROUP ARRANGEMENT ALLOWED BY THE TYPE OF SUBSTRATE AND DIAMETER OF BOLT LISTED BELOW UNDER TEST VALUES TABLE) PROOF TESTED IN TENSION TO TWICE THE ALLOWABLE TENSION LOAD. IF THERE ARE ANY FAILURES, THE IMMEDIATELY ADJACENT BOLTS MUST THEN ALSO BE TESTED. TESTING SHALL BE PERFORMED IN ACCORDANCE WITH TITLE 24. PART 2, SECTION 1916A.8. ALL BOLTS MUST HAVE ICC APPROVAL.

ALL ANCHOR BOLTS OF THE EXPANSION TYPE SHALL BE ONE OF THE FOLLOWING: 1. HILTI KB-TZ ANCHOR ICC NO. ESR 1917

MINIMUM TEST VALUES NORMAL WEIGHT OR LIGHTWEIGHT CONCRETE <u>ANCHOR</u> **TORQUE** EFFECTIVE MIN. **TENSION** LOAD (LBS) (FT-LBS) **EMBEDMENT** 6500 25 1 1/2" - 2 3/4" 1/2 10,705 40 2" - 3 1/4" 5/8 17,170 60 3 1/8" - 4 3/4" 3/4 25,120 110 3 1/4" - 4 3/4"

POWDER-DRIVEN CONCRETE FASTENERS GENERAL: USE OF POWDER DRIVEN CONCRETE FASTENERS FOR TENSION LOADS IS LIMITED TO SUPPORT OF MINOR LOADS LIKE ACOUSTICAL CEILINGS, DUCT WORK, CONDUIT ALLOWABLE LOADS: IN GENERAL, LOADS SHOULD BE LIMITED TO LESS

THAN 100 POUNDS. HOWEVER GREATER LOADS MAY BE PERMITTED

FOR SPECIAL CASES WHEN APPROVED BY THE CHECKING SUPERVISOR OR FIELD ENGINEER. TESTING: THE OPERATOR, TOOL, AND FASTENER SHALL BE PREQUALIFIED BY THE PROJECT INSPECTOR. HE SHALL OBSERVE THE TESTING OF THE FIRST 10 FASTENER INSTALLATIONS. A TEST "PULL-OUT" LOAD OF NOT LESS THAN TWICE THE DESIGN LOAD, OR 200 POUNDS, WHICHEVER IS GREATER, SHALL BE APPLIED TO THE PIN IN SUCH A MANNER AS NOT TO RESIST THE SPALLING TENDENCY OF THE CONCRETE SURROUNDING THE PIN. THEREAFTER, RANDOM TESTS UNDER THE PROJECT INSPECTOR'S SUPERVISION SHALL BE MADE OF APPROXIMATELY 1 IN 10 PINS, EXCEPT THAT WHEN THE DESIGN LOAD EXCEEDS 100 POUNDS. ONE HALF OF THE PINS SHALL BE TESTED. SHOULD FAILURE OCCUR ON ANY PIN TESTED, ALL INSTALLATIONS

MUST BE TESTED AND UNFAIR PINS REPLACED. ALL POWDER DRIVEN CONCRETE FASTENERS SHALL BE ONE OF THE FOLLOWING: HILTLING. X-CF OR X-CP PINS - WOOD PLATE - ICC NO. ESR 2379 X-U PINS - STEEL TRACK - ICC NO. ESR 2269 ITW RAMSET/REDHEAD DRIVE PIN - WOOD PLATE -

DRIVE PIN - STEEL TRACK - ICC NO. ESR 1955 10. SPECIFICATIONS FOR AUTOMATIC END WELDED STUDS MATERIAL: AUTOMATIC END WELDED STUDS SHALL BE NELSON GRANULAR FLUX-FILLED SHEAR CONNECTOR OR ANCHOR STUDS (OR APPROVED EQUAL). STUDS SHALL BE MANUFACTURED OF

G-1015 COLD ROLLED STEEL WHICH CONFORMS TO ASTM A108. INSTALLATION: THE STUDS SHALL BE AUTOMATICALLY END WELDED IN ACCORDANCE WITH THE MANUFACTURER'S RECOMMENDATIONS IN SUCH A MANNER AS TO PROVIDE COMPLETE FUSION BETWEEN THE END OF THE STUD AND THE PLATE. THERE SHOULD BE NO POROSITY OR EVIDENCE OF LACK OF FUSION BETWEEN THE WELDED END OF THE STUD AND THE PLATE. THE STUD SHALL DECREASE IN LENGTH DURING WELDING APPROXIMATELY 1/8" FOR 5/8" AND UNDER, AND 3/16" FOR OVER 5/8" DIAMETER. WELDING SHALL BE DONE ONLY BY QUALIFIED WELDERS APPROVED BY THE WELDING INSPECTOR. INSPECTION AND TESTS: INSPECTION, IN ACCORDANCE WITH TITLE

24, PART 2, SECTION 2212A.3 AND 1704A.3.1 OF ALL THE SHOP AND FIELD WELDING OPERATIONS FOR THE AUTOMATIC END WELDED STUDS SHALL BE MADE BY A QUALIFIED WELDING INSPECTOR (APPROVED BY THE DIVISION OF THE STATE ARCHITECT). THE TYPE AND CAPACITY OF THE WELDING EQUIPMENT SHALL BE IN ACCORDANCE WITH THE MANUFACTURER'S RECOMMENDATIONS AND SHALL BE CHECKED AND APPROVED BY A WELDING INSPECTOR.

AT THE BEGINNING OF EACH DAY'S WORK, A MINIMUM OF TWO TEST STUD WELDS SHALL BE MADE WITH THE EQUIPMENT TO BE USED TO METAL WHICH IS THE SAME AS THE ACTUAL WORK PIECE. THE TEST STUDS SHALL BE SUBJECTED TO A BEND TEST BY STRIKING THEM WITH A 900 HEAVY HAMMER. AFTER THE ABOVE TEST, THE WELD SECTION SHALL NOT EXHIBIT ANY TEARING OUT



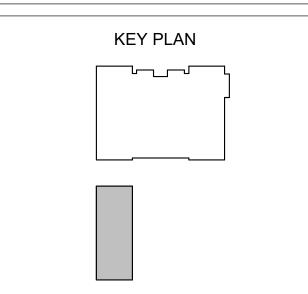
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**HUNTINGTON BEACH** CITY SCHOOL DISTRICT 8750 DORSETT DR **HUNTINGTON BEACH, CA 92646** 

**CUP SUBMITTAL** 

KETTLER EDUCATIONAL 8750 DORSETT DRIVE **HUNTINGTON BEACH, CA 92646** 

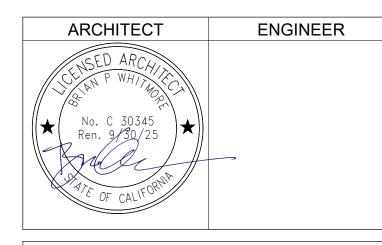
**GENERAL NOTES** 

Date		Project Number
04/05/2023	}	21010
Scale		Drawing Number
12" = 1'-0"		$\Lambda \cap \Omega$
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Author	Checker	, , , , , ,

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HUNTINGTON BEACH CITY SCHOOL DISTRICT 8750 DORSETT DR HUNTINGTON BEACH, CA 92646

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ARCHITECTURAL SYMBOLS AND ABBREVIATIONS

Date 04/05/2023		Project Number 21010
Scale As indicated	 d	Drawing Number
Drawn Author	Checked Checker	A0.3

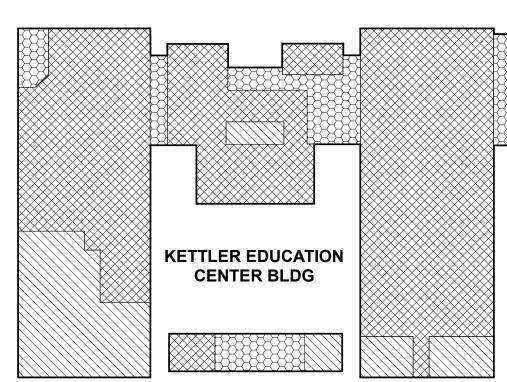
### **PARKING ANALYSIS** (E) KETTLER EDUCATION CENTER

BASED ON HUNTINGTON BEACH, CALIFORNIA MUNICIPAL CODE: TITLE 23 ZONING CODE

231.04 OFF-STREET PARKING AND LOADING SPACES REQ'D WAREHOUSE AND STORAGE: 1 PARKING SPACE PER 1000 SQ FT 6,906 GROSS SF / 1000 SF = 6.906 = 7 STALLS REQ'D

23,852 GROSS SF / 250 SF = 95.408 = 96 STALLS REQ'D

TOTAL PARKING REQ'D: 103 STALLS **TOTAL PARKING EXISTING:** 119 STALLS



WAREHOUSE & STORAGE - 6,906 GROSS SF OFFICES, BUSINESS, & PROFESSIONAL - 23,852 GROSS SF

PROJECT DATA

HUNTINGTON BEACH, CA 92646 APN: 148-113-42 ZONING DISTRICT: PUBLIC SEMI-PUBLIC DISTRICT GENERAL PLAN LAND USE DESIGNATION: PS

<u>LOT COVERAGE</u> (34704 SF + 7510 SF) / 209,088 X 100 = 20.19%

FLOOR AREA RATIO (FAR): 7510 SF / 209,088 SF = 0.036

BUILDING USE (PROPOSED):
BUSINESS (B) / FACTORY INDUSTRIAL (F-2) LOW-HAZARD / LOW-HAZARD

PARKING SPACES (PROPOSED):
ON-SITE PARKING: 14 STALLS (INCLUDES 1 ACCESSIBLE STALL)

FIRST FLOOR OTAL AREA

### **PARKING ANALYSIS**

BASED ON HUNTINGTON BEACH, CALIFORNIA MUNICIPAL CODE: TITLE 23 ZONING CODE

**GROSS BUILDING AREA** 

7,510 SF

7,510 SF

### 231.04 OFF-STREET PARKING AND LOADING SPACES REQ'D

MAINTENANCE AND REPAIR SERVICES: 1 PARKING SPACE PER 500 SQ FT 7,510 GROSS SF / 500 SF = 15.02 = 16 STALLS REQ'D

16 STALLS TOTAL PARKING REQ'D: TOTAL PARKING PROVIDED: 14 STALLS

### **BICYCLE STORAGE CALCS**

BASED ON HUNTINGTON BEACH . CALIFORNIA MUNICIPAL CODE: TITLE 23 ZONING CODE

231.20 BICYCLE PARKING
REQUIRED: ONE BICYCLE SPACE FOR EVERY 25 AUTOMOBILE PARKING SPACE REQUIRED FOR BUILDINGS UP TO 50,000 SQ FT OF GROSS BUILDING AREA; MINIMUM OF THREE

**CLEAN AIR VEHICLE PARKING** 

5-BIKE CAPACITY STORAGE, PERMANENTLY ANCHORED

BASED ON CalGreen 2022 PA			
TOTAL NUMBER OF PARKING SPACES	NUMBER OF REQUIRED CLEAN AIR VEHICLE SPACES	NUMBER OF REQUIRED CHARGING SPACES	
0 TO 9	0	0	
10 TO 25	4	0	
26 TO 50	8	2	
51 TO 75	13	3	BUILDING NAME
76 TO 100	17	4	BUILDING CONDIT
101 TO 150	25	6	OCCUPANCY (CBC
151 TO 200	35	9	BUILDING HEIGHT
201 and over	20 percent of total <sup>1</sup>	25 percent of EV capable spaces <sup>2</sup>	NUMBER OF STOR
<sup>1</sup> Calculation for spaces shall be rounded up to the nearest whole			TYPE OF CONSTR

### **ACCESSIBLE PARKING**

BASED ON CBC TABLE 11B-208.2 "PARKING SPACES" MINIMUM NUMBER OF REQUIRED TOTAL NUMBER OF PARKING SPACES PROVIDED IN PARKING FACILITY ACCESSIBLE PARKING SPACES

1 TO 25	1
26 TO 50	2
51 TO 75	3
76-100	4
101-150	5
151-200	6
201-300	7
301-400	8
401-500	9
501-1000	2 PERCENT OF TOTAL

20, PLUS 1 FOR EACH 100, OR FRACTION

1 VAN STALL

THEREOF, OVER 1000 STANDARD PARKING PROVIDED: 10 STALLS CLEAN AIR VEHICLE PARKING STALLS REQ.: 4 STALLS CLEAN AIR VEHICLE PARKING STALLS PROVIDED: 4 STALLS

1001 AND OVER

ACCESSIBLE PARKING PROVIDED:

**TOTAL PARKING PROVIDED:** 

SHALL NOT EXCEED 1.

	1	7	4	BUILDING CONDITION	NEW
	2	5	6	OCCUPANCY (CBC SECTION 302)	B / F-2 / S-2
	3	5	9	BUILDING HEIGHT	17'-6"
	20 percer	nt of total¹	25 percent of EV capable spaces <sup>2</sup>	NUMBER OF STORIES	1
		spaces shall be	rounded up to the nearest whole	TYPE OF CONSTRUCTION	V-B
			(EV capable spaces provided	SPRINKLERS	NO
with EVSE) in column 3 count toward the total number of required EV capable spaces shown in column 2.			ALTERNATIVE PROTECTION (CBC 903.1.1)	NOT USED	
	_ t dapable spa			SEPARATED? (CBC TABLE 508.4)	YES
=	SSIBL	E PAR	RKING	ALLOWABLE AREA DETERMINATION (CBC 506.2, BASED ON THE MOST RESTRICTIVE OCCUPANCY)	$A_a = A_t + (NS \times I_f)$ $A_a = X,XXX + (X,XXX \times .XX)$ $A_a = XX,XXX$
3-2	208.2 "PARKING	SPACES"		A <sub>t</sub> = TABULAR ALLOWABLE AREA (CBC TABLE 506.2)	9,000 SF
	NG SPACES	_	NUMBER OF REQUIRED	NS = TABULAR ALLOWABLE AREA FACTOR	9,000 SF
)	FACILITY	ACCESS	SIBLE PARKING SPACES	I <sub>f</sub> = FRONTAGE INCREASE (CBC 506.3)	0.75
			1	ALLOWABLE BUILDING HEIGHT (CBC TABLE 504.3)	18'

**GENERAL NOTES** 

1. ALL (E) STRUCTURES AND ITEMS ON SITE ARE APPROXIMATE BASED ON

1. ALL EXTERIOR OUTWARD SWINGING DOORS TO HAVE A MINIMUM 5'-0" LEVEL

SEE ACCESSIBLE PATH OF TRAVEL DEFINITION, THIS SHEET.

1/2" MAXIMUM IN THE DIRECTION OF TRAFFIC FLOW.

ALL BUILDING ENTRANCES AND EXTERIOR GROUND LEVEL EXITS SHALL BE

ALL SIDEWALKS ALONG THE ACCESSIBLE ROUTE TO BE A MINIMUM OF 4'-0"

WIDE, AND THERE SHALL BE NO DROP-OFFS OVER 4" AT EDGE OF WALK OR LANDING. WHERE A 4" DROP-OFF DOES OCCUR, PROVIDING A 6" HIGH

FOR GRATINGS LOCATED IN THE SURFACE OF ANY PEDESTRIAN WALKWAY

IN THE PATH OF TRAVEL. GRID/OPENINGS IN GRATINGS SHALL BE LIMITED TO

36" WIDE CONTINUOUS DETECTABLE WARNING SHALL BE USED WHERE THE

ACCESSIBLE PATH OF TRAVEL AS INDICATED ON PLANS IS A BARRIER FREE

ACCESS ROUTE WITHOUT ANY ABRUPT LEVEL CHANGES EXCEEDING 1/2" IF

EXCEEDING 1/4" MAXIMUM AND AT LEAST 48" IN WIDTH. SURFACE IS STABLE,

SLOPE IN THE DIRECTION OF TRAVEL IS LESS THAN 5% UNLESS OTHERWISE INDICATED. ACCESSIBLE PATH OF TRAVEL SHALL BE MAINTAINED FREE OF

OVERHANGING OBSTRUCTIONS TO 80" MINIMUM AND PROTRUDING OBJECTS

GREATER THAN 4" PROJECTION FROM WALL ABOVE 27" AND LESS THAN 80".

GATES ALONG ACCESSIBLE ROUTE SHALL MEET DOOR REQUIREMENTS PER

CBC SECTION 11B-404 INCLUDING PANIC HARDWARE AND 10" MIN. SMOOTH

GATES IN PATH OF TRAVEL SHALL COMPLY WITH EXIT DOOR REQUIREMENTS

WITH PROPER ACCESSIBLE LEVER HARDWARE AND KICK PLATES.

WALLS, FENCES, AND OTHER FREE STANDING STRUCTURES REQUIRE

TRANSFORMER LOCATED IN THE ELECTRICAL ROOM OF (E) KETTLER

**CODE ANALYSIS** 

**M&O BUILDING** 

= .834 < 1 = OK

ARCHITECT SHALL VERIFY THAT THERE ARE NO BARRIERS IN THE PATH OF

PEDESTRIAN PATH CROSSES OR ADJOINS A VEHICULAR WAY (SUCH AS A

DRIVEWAY) TO WARN OF POTENTIAL HAZARDS AS PER CBC 11B-705. SEE DESIGN PROFESSIONAL IN GENERAL RESPONSIBLE CHARGE

BEVELED AT 1:2 MAXIMUM SLOPE OR VERTICAL LEVEL CHANGES NOT

FIRM AND SLIP RESISTANT. CROSS SLOPE DOES NOT EXCEED 2% AND

STATEMENT ON THIS SHEET FOR PATH OF TRAVEL REQUIREMENTS

WARNING CURB OR GUARD OR HANDRAIL. (SEE CBC SECTION 11B-303.5)

**EXISTING CONDITIONS** 

DRAWINGS FROM OWNER.

ACCESSIBLE.

GATES:

BOTTOM OR KICK PLATE.

**EDUCATION CENTER** 

**ACCESSIBLE PATH OF TRAVEL:** 

BUILDING A FRONTAGE INCREASE CALCULATION PER CBC 506.3:

ALLOWABLE NUMBER OF STORIES (CBC TABLE 504.4)

ACTUAL AREA / ALLOWABLE AREA

(BLDG PERIM. THAT FRONTS A MIN. 20' OPEN SPACE OR PUBLIC WAY) (PERIMETER OF ENTIRE BUILDING) (WIDTH OF PUBLIC WAY, SEE CALC. BELOW)

 $W = (L_1 \times w_1 + L_2 \times w_2 + L_3 \times w_3 + L_4 \times w_4)/F$ Ln = LENGTH OF A PORTION OF THE EXTERIOR PERIMETER WALL w<sub>n</sub> = WIDTH (≥ 20 FEET) OF A PUBLIC WAY OR OPEN SPACE

ASSOCIATED WITH THAT PORTION OF THE EXTERIOR PERIMETER WALL. F = BLDG PERIM. THAT FRONTS ON A PUBLIC WAY (≥ 20 FEET)

 $I_f = [556' - 8'' / 556' - 8'' - .25] 30 / 30$  $I_f = [1-.25]1$   $I_f = .75$ 

### SEPARATED OCCUPANCY RATIO

SEPARATED OCCUPANCIES ALLOWABLE BUILDING AREA (CBC 508.4.2) IN EACH STORY, THE BUILDING AREA SHALL BE SUCH THAT THE SUM OF THE RATIOS OF THE ACTUAL BUILDING AREA OF EACH SEPARATED OCCUPANCY DIVIDED BY THE ALLOWABLE BUILDING AREA OF EACH SEPARATED OCCUPANCY

OCCUPANCY	ACTUAL SF (GROSS) ALLOWABLE SF	<u>RATIO</u>
В	<u>1,714 SF</u> 5,000 SF	= .342 < 1> <b>OK</b>
F-2	<u>1,951 SF</u> 13,000 SF	= .150 < 1> <b>OK</b>
S-2	<u>3,845 SF</u> 13,500 SF	= .284 < 1> <b>OK</b>

**TOTALS** 

.342 + .150 + .284 = <u>.776 < 1 --> OK</u>

### **LEGEND**

(E) BUILDING, NOT UNDER SCOPE OF WORK BUILDING UNDER SCOPE OF WORK

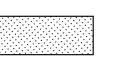
> 20'-0" WIDE MINIMUM CLEAR FIRE ACCESS LANE ACCESSIBLE BATHROOM FACILITIES:

(W) WOMENS (G) GIRLS (B)BOYS (N) ALL GENDER (DF)DRINKING FOUNTAIN

• • • • • • • ACCESSIBLE PATH OF TRAVEL, SEE DEFINITION ON THIS SHEET

— — — SETBACK LINE

LOCATION OF ACCESSIBLE EXTERIOR EXIT DOORS, ENTRANCES, AND EGRESS



LANDSCAPE



8750 DORSETT DR **HUNTINGTON BEACH, CA 92646** 

STUDIO W

ARCHITECTS

Studio W Architects

Newport Beach, California 92663

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**ENGINEER** 

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CODE ANALYSIS AND FIRE ACCESS SITE PLAN

**HUNTINGTON BEACH, CA 92646** 

Project Number 11/28/2023 Scale **Drawing Number** As indicated Drawn

Checked

CODE ANALYSIS SITE PLAN 1" = 30'-0" (15)

- 6' HIGH CONTINUOUS

**FENCE VIEW** 1" = 30'-0" (10)

CONTINUOUS FENCE ON

(NET) 35 SF (GROSS) 43 SF NO OCC.

(10 402)

114 S-2 766 SF (NET)

4 OCC.

{6}

<u>------</u>

**FILTERS** 

1 OCC.

**GROUNDSKEEPING** 

4 OCC.

**MECHANIC** 

118 F-2

4 OCC.

SECURE

STORAGE 119 S-2 1,041 SF (NET)

4 OCC.

CODE ANALYSIS FLOOR PLAN 3/32" = 1'-0" (10)

617 SF (NET)

117 F-2 677 SF (NET)

115 8-2

386 SF (NET)

(NET) 73 SF 84 ST

(GROSS) 84 SF

**PLAN ROOM** 

103 B

32 OCC.

LOCKSMITH OFFICE 109 B

(NET) 492 SF

(NET) 173 SF

2 OCC.

LAYOUT

AREA

110 B

(NET) 362 SF

(GROSS) 383 SF 3 OCC.

(GROSS) 188 SF

(GROSS) 523 SF

STUDIO W

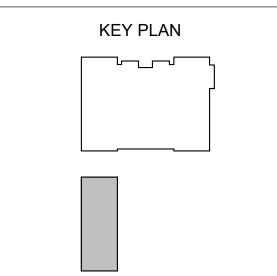
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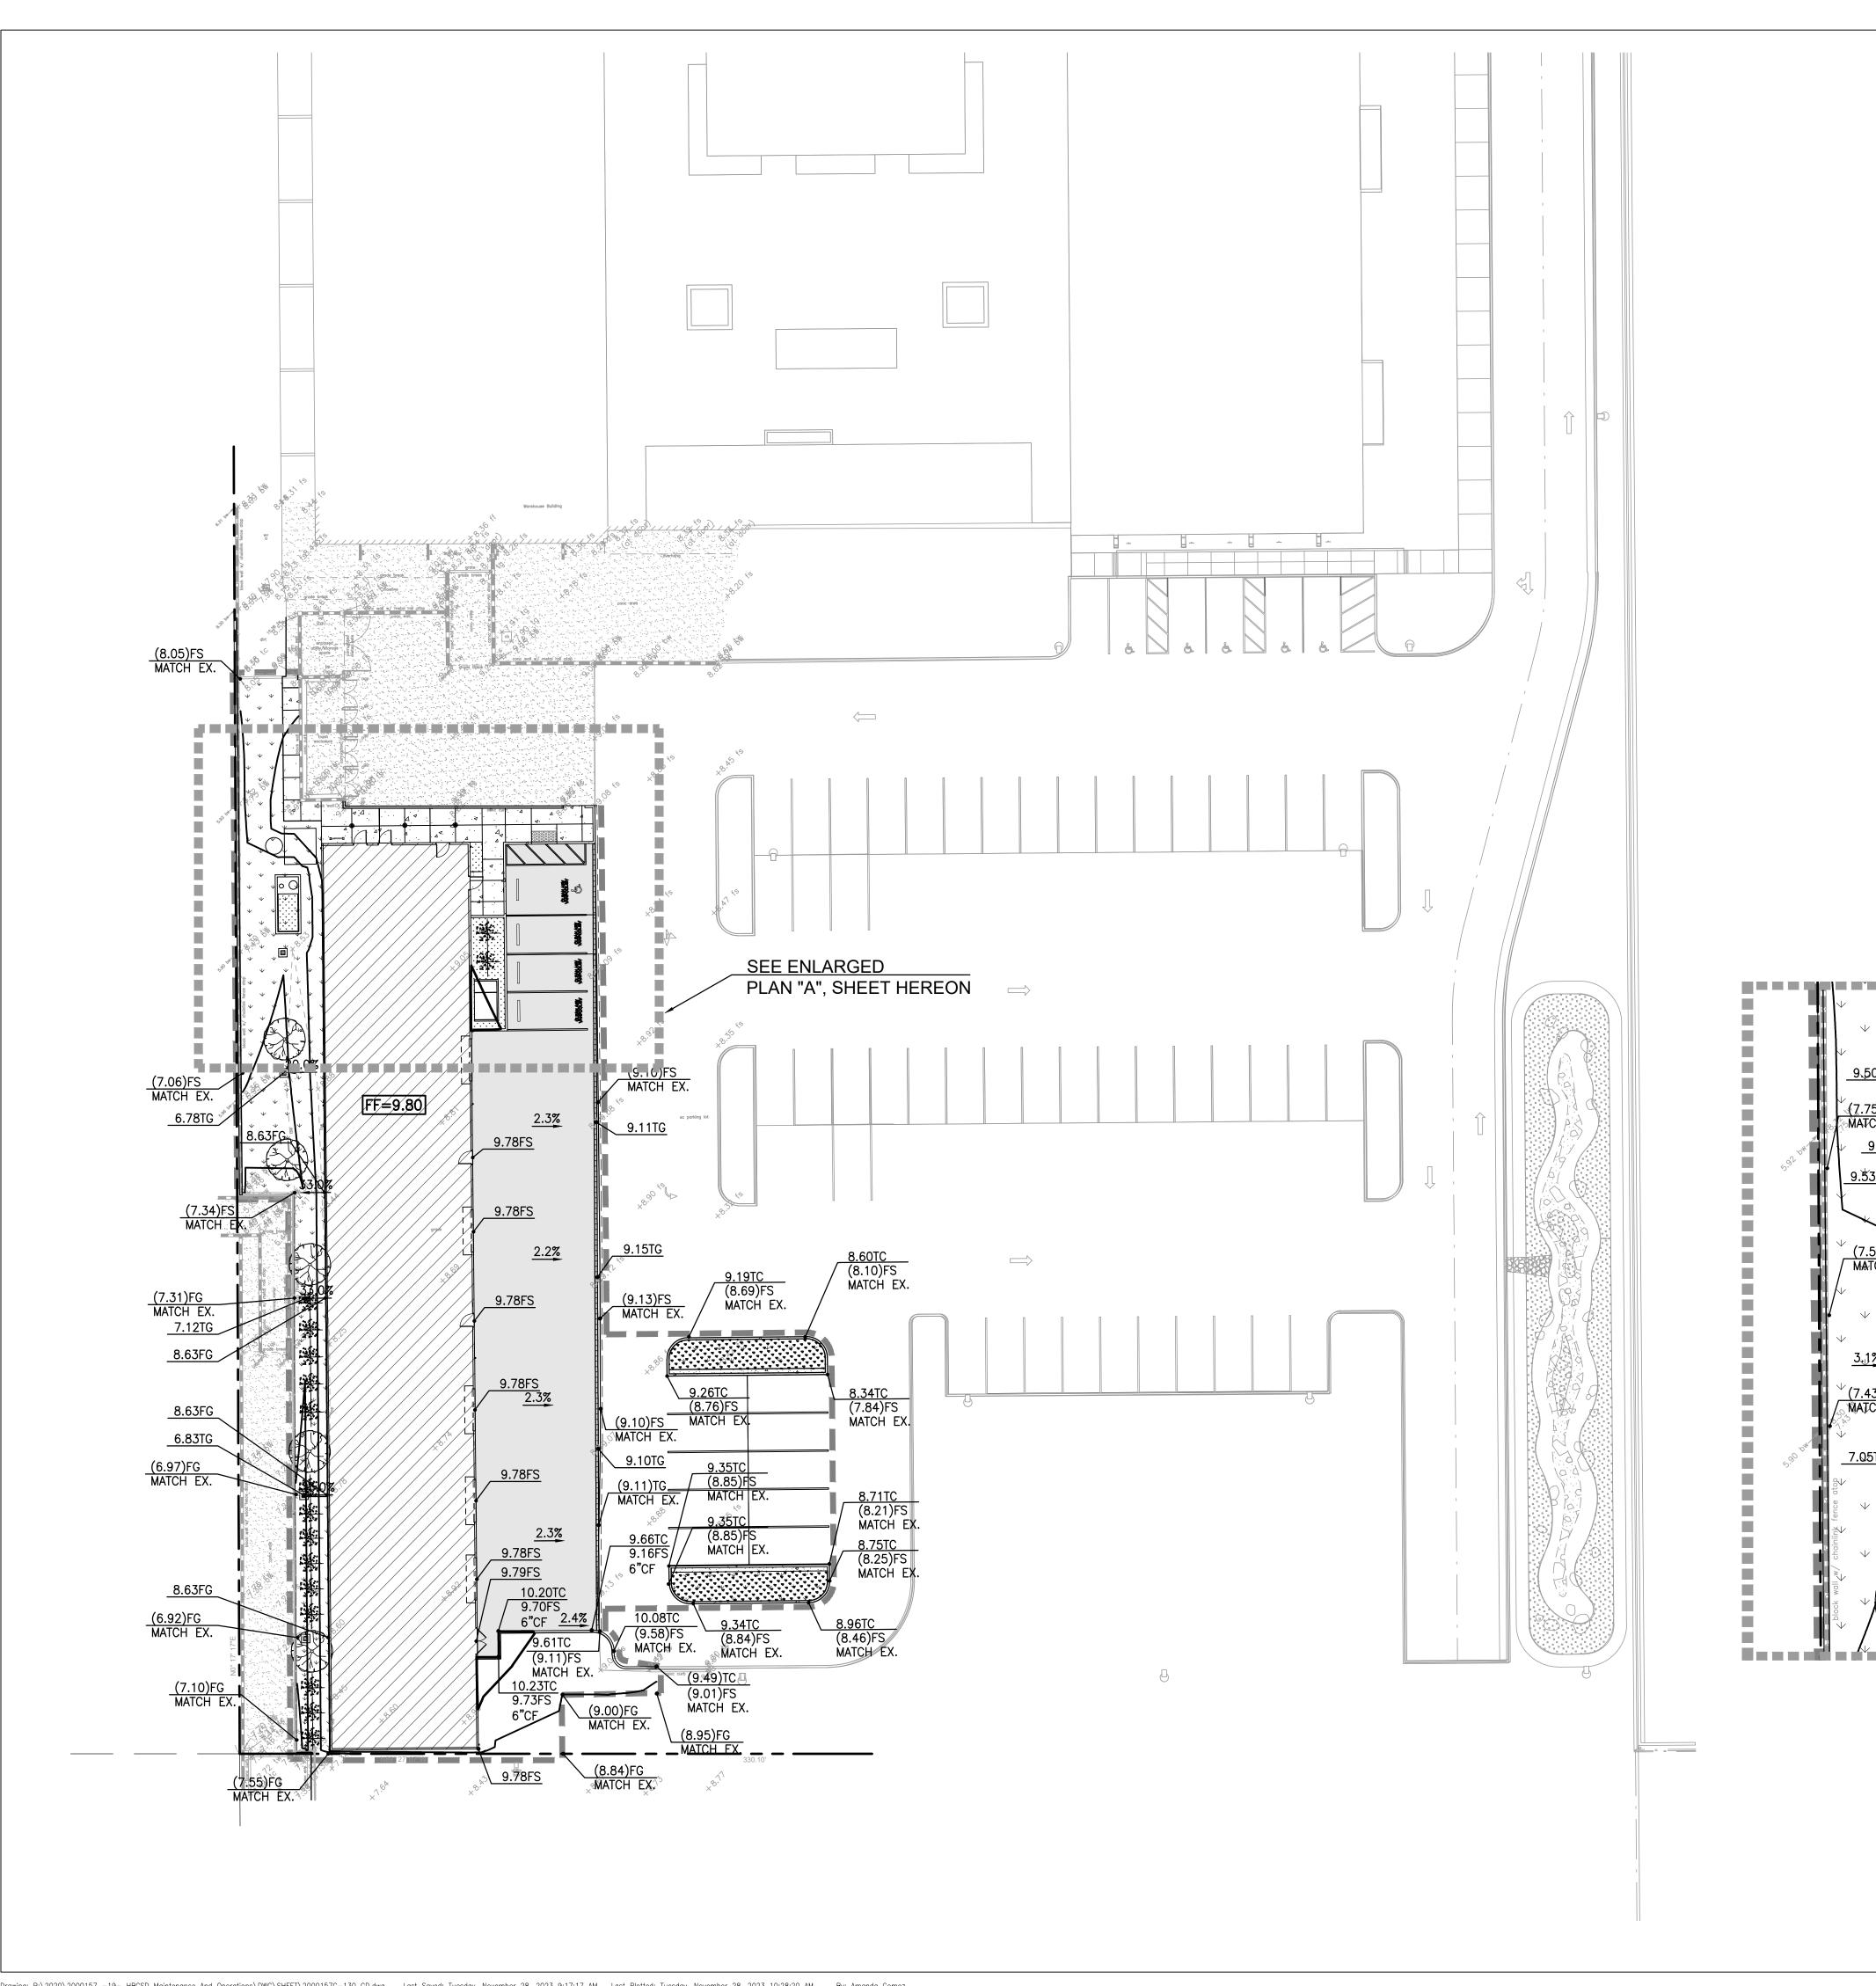
CODE ANALYSIS FLOOR PLAN

Project Number 04/05/2023 21010 **Drawing Number** Scale As indicated Checked Drawn

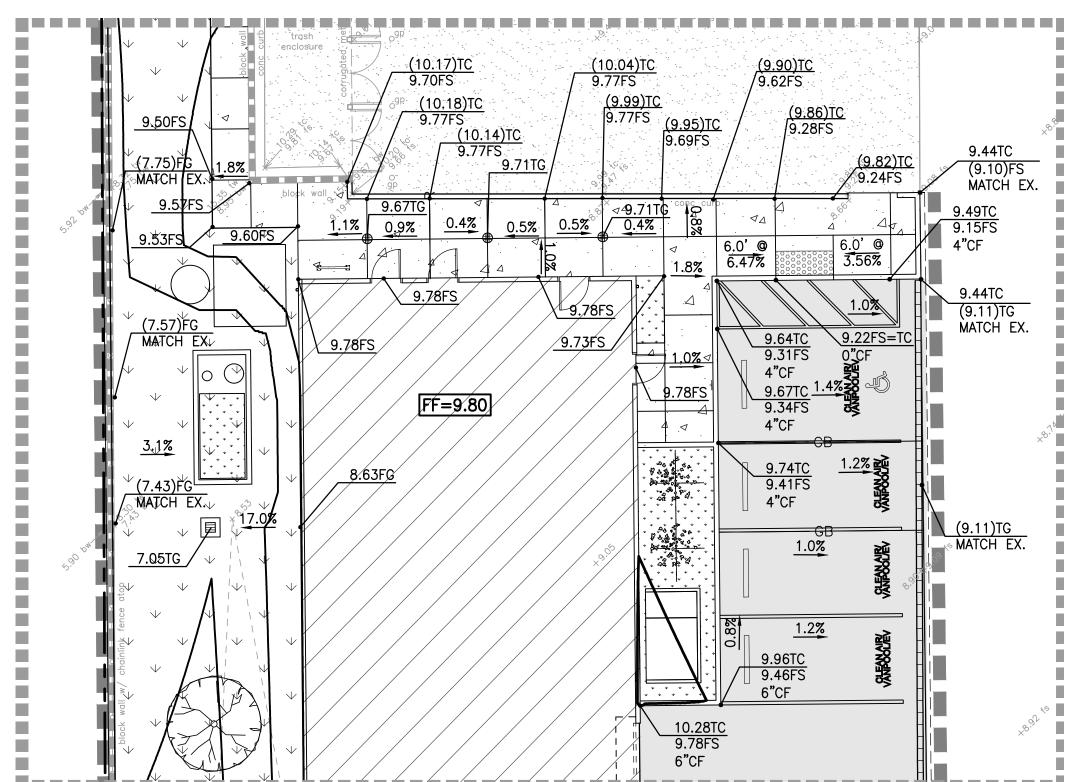
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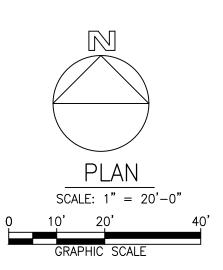


LEGEND: SAWCUT LINE CONCRETE PAVING ASPHALT PAVING PROPOSED BUILDING



ENLARGED GRADING PLAN

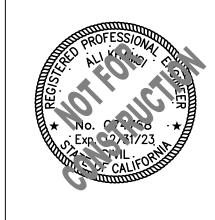
1" = 10'





# HUNTINGTON

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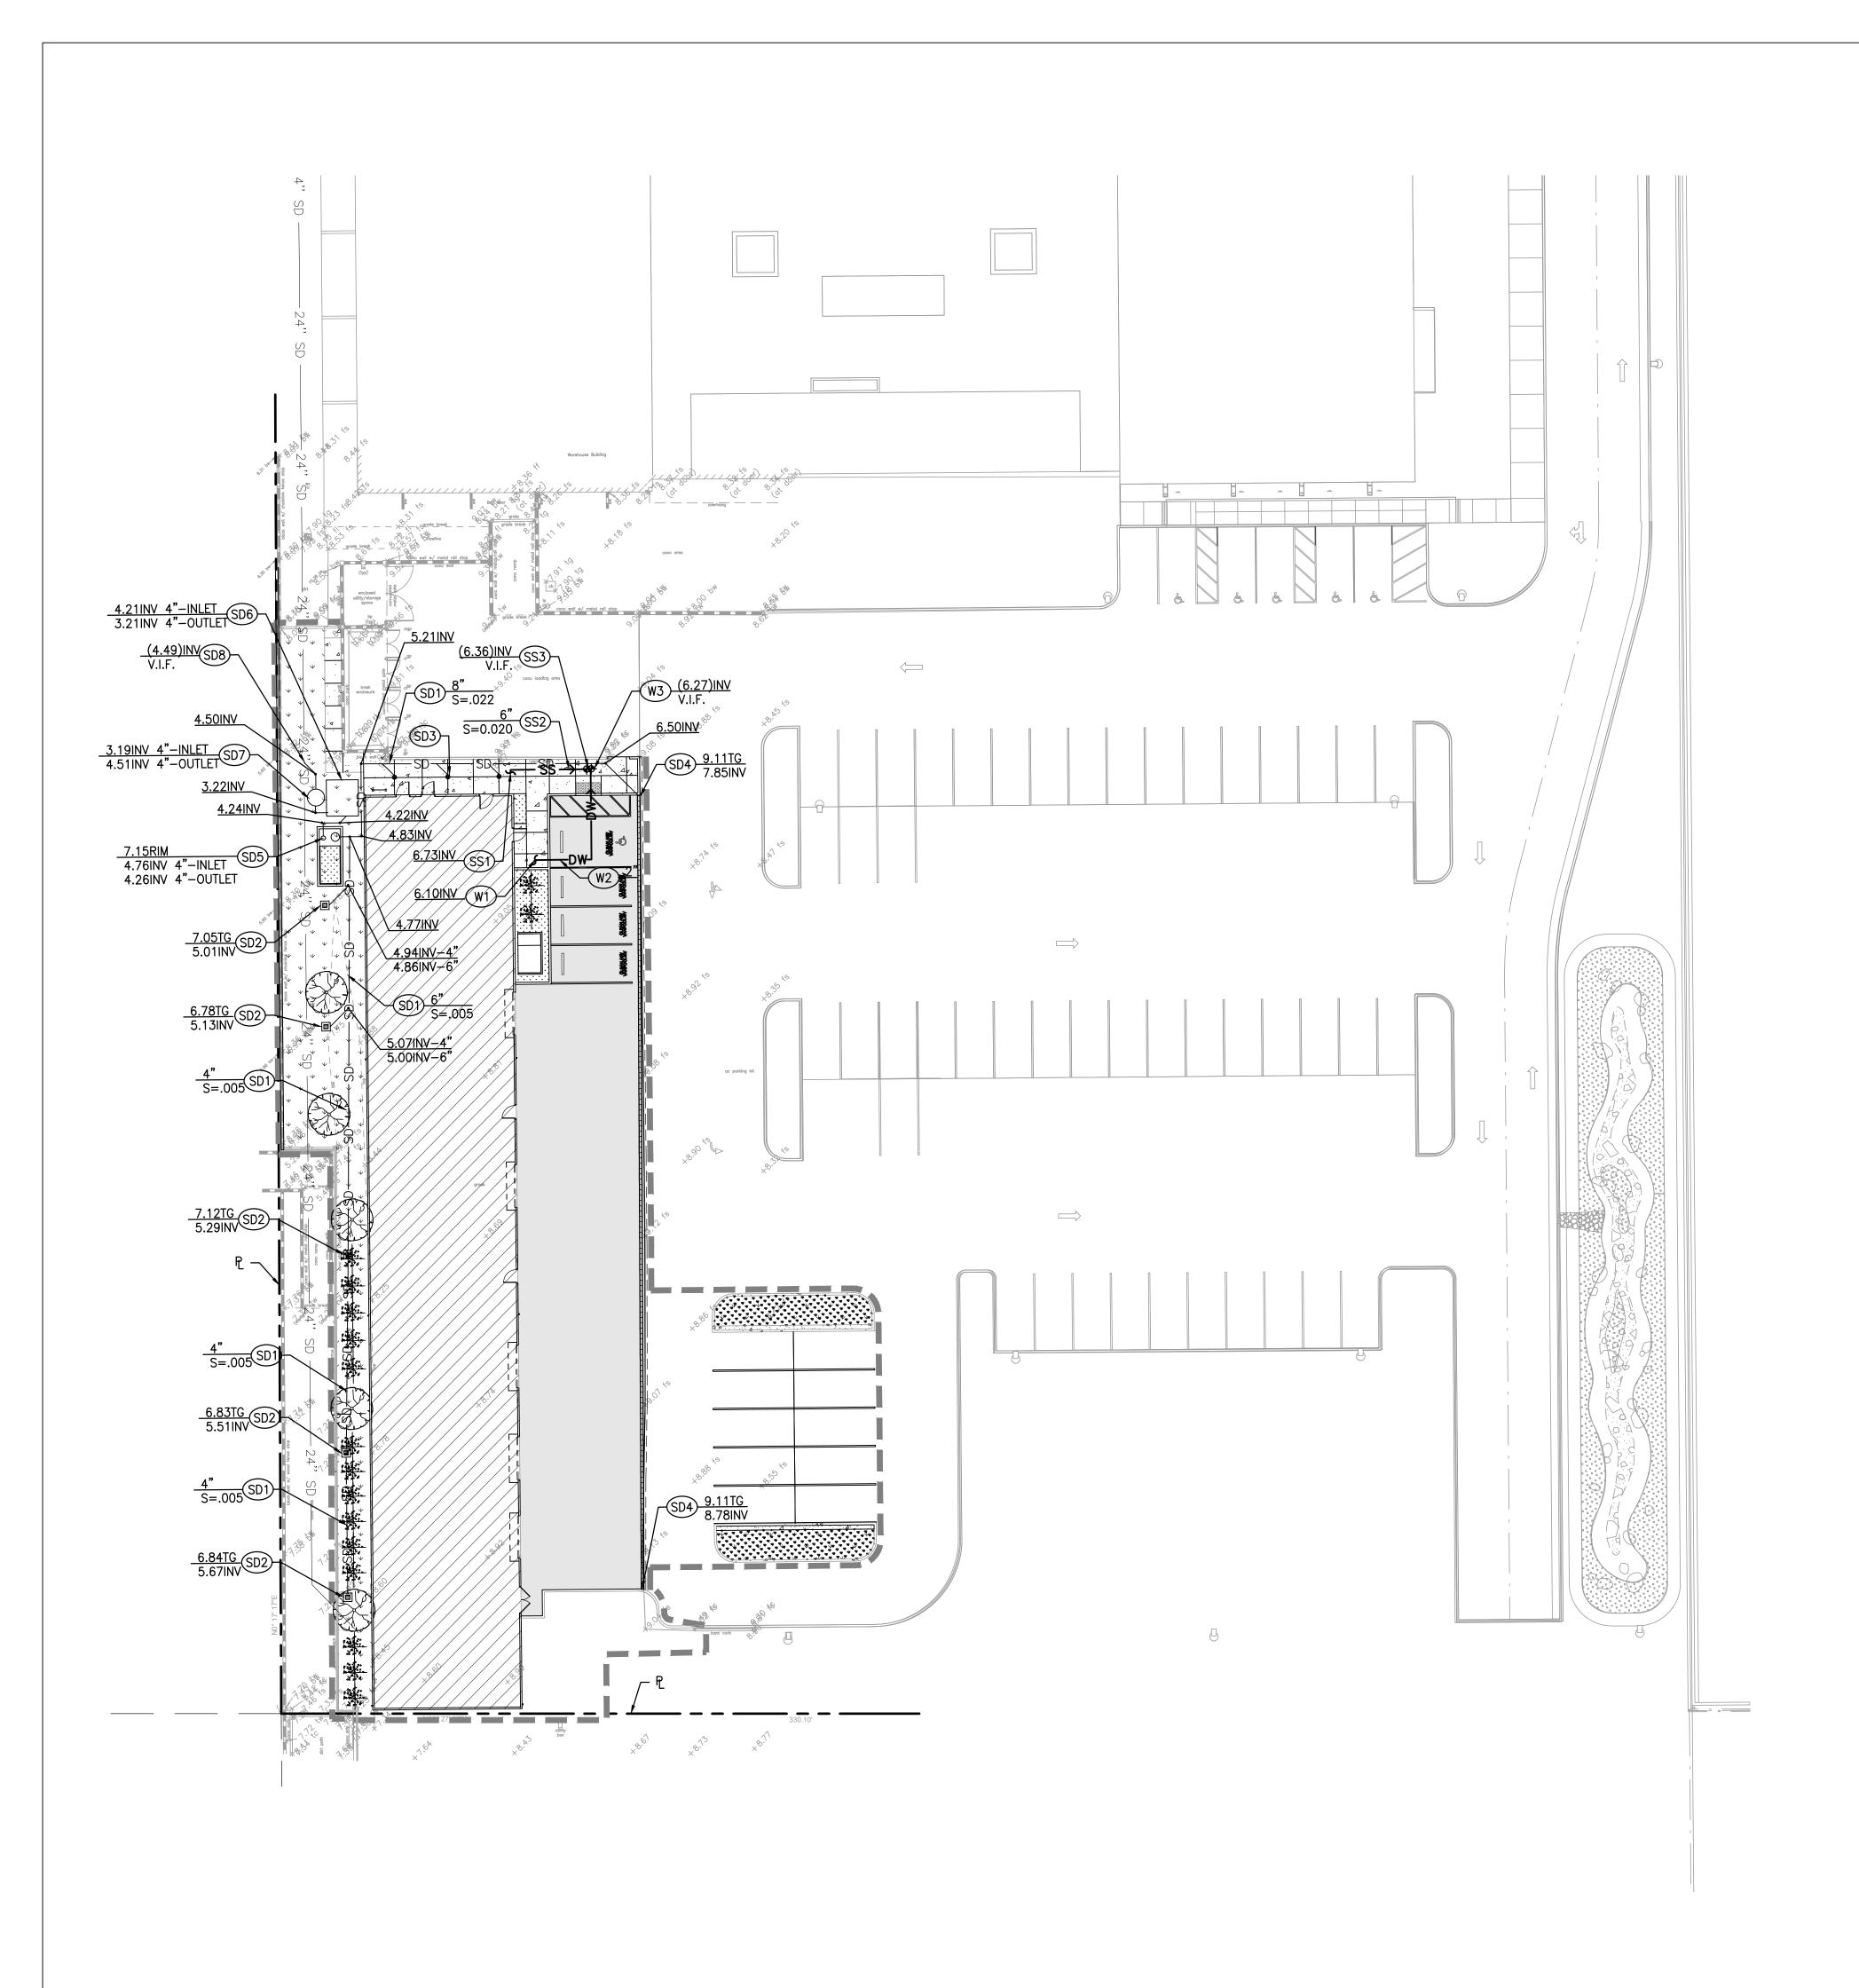


ISSUED FOR:

04.11.2023 Project Number: 2000157 Drawn By:

Checked By: AS SPECIFIED

PRELIMINARY GRADING PLAN



### **UTILITY CONSTRUCTION NOTES:**

### STORM DRAIN

- (SD1) PVC, SDR-35 STORM DRAIN PIPE. SIZE AND SLOPE PER PLAN.
- SD2 12" X 12" PRECAST CONCRETE CATCH BASIN. JENSEN PRECAST PRODUCTS OR APPROVED EQUIVALENT..
- SD3) AREA DRAIN
- (SD4) ACO K200 KLASSIK DRAIN
- SD5) ADS ECOPURE BIOFILTRATION UNIT
- SD6 ADS STORMTECH MC-3500
- SD7) PSI SUMP PUMP
- SD8 CONNECT TO EXISTING 24" SD LINE. VERIFY POC AND LOCATION IN THE FIELD.

### SANITARY SEWER

- POINT OF CONNECTION 5 FEET FROM BUILDING FACE. SEE PLUMBING DRAWINGS FOR CONTINUATION.
- (\$S2) PVC, SDR-35 SANITARY SEWER PIPE. SIZE AND SLOPE PER PLAN.
- CONNECT TO EXISTING STUB OUT. VERIFY POC AND LOCATION IN THE FIELD.

### DOMESTIC WATER

- POINT OF CONNECTION 5 FEET FROM BUILDING FACE. SEE PLUMBING DRAWINGS FOR CONTINUATION.
- (W2) PVC SCH-40 DOMESTIC WATER PIPE SIZE PER PLAN.
- CONNECT TO EXISTING STUB OUT. VERIFY POC AND LOCATION IN THE FIELD.

### FIRE WATER

A SEPARATE PRIVATE FIRE WATER SERVICE SEPARATED FROM THE PUBLIC MAIN IN DORSETT DRIVE BY THE CONSTRUCTION OF A DOUBLE CHECK DETECTOR ASSEMBLY WILL BE PROVIDED BY A SEPARATE

THE FIRE SPRINKLER SYSTEM AND PROPOSED HYDRANT WILL HAVE A SEPARATE DEDICATED FIRE SERVICE LINE INSTALLED PER WATER DIVISION STANDARDS BY A SEPARATE PERMIT

### **LEGEND**

	UTILITY LIMIT OF WORK
	PROPERTY LINE
	PROPOSED STORM DRAIN LINE
— ss —— ss —	PROPOSED SEWER LINE
——w——w——	PROPOSED WATER LINE
<pre></pre>	PLANTER AREA
	PROPOSED BUILDING
: 4 · · · · · · · · · · · · · · · · · ·	CONCRETE PAVING
	ASPHALT PAVING

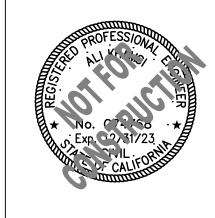
ALL BURIED DUCTILE IRON AND COPPER PIPE, FITTINGS, VALVES, AND APPURTENANCES SHALL BE COATED WITH A DIELECTRIC COATING: A LIQUID EPOXY COATING SYSTEM PER AWWA C-210 AT 24 MILS MINIMUM DRY FILM THICKNESS (MDFT) 3M SCOTCHKOTETM 323/3231 LIQUID EPOXY COATINGS FOR CORROSION PROTECTION OR EQUIVALENT, OR A COLD APPLIED THREE PART SYSTEM PETROLEUM WAX TAPE PER AWWA C-217, OR A 100% POLYURETHANE COATING OF 24 MILS MDFT SUITABLE FOR BURIED USE DENSYL TAPE BY DENSO OR EQUIVALENT.



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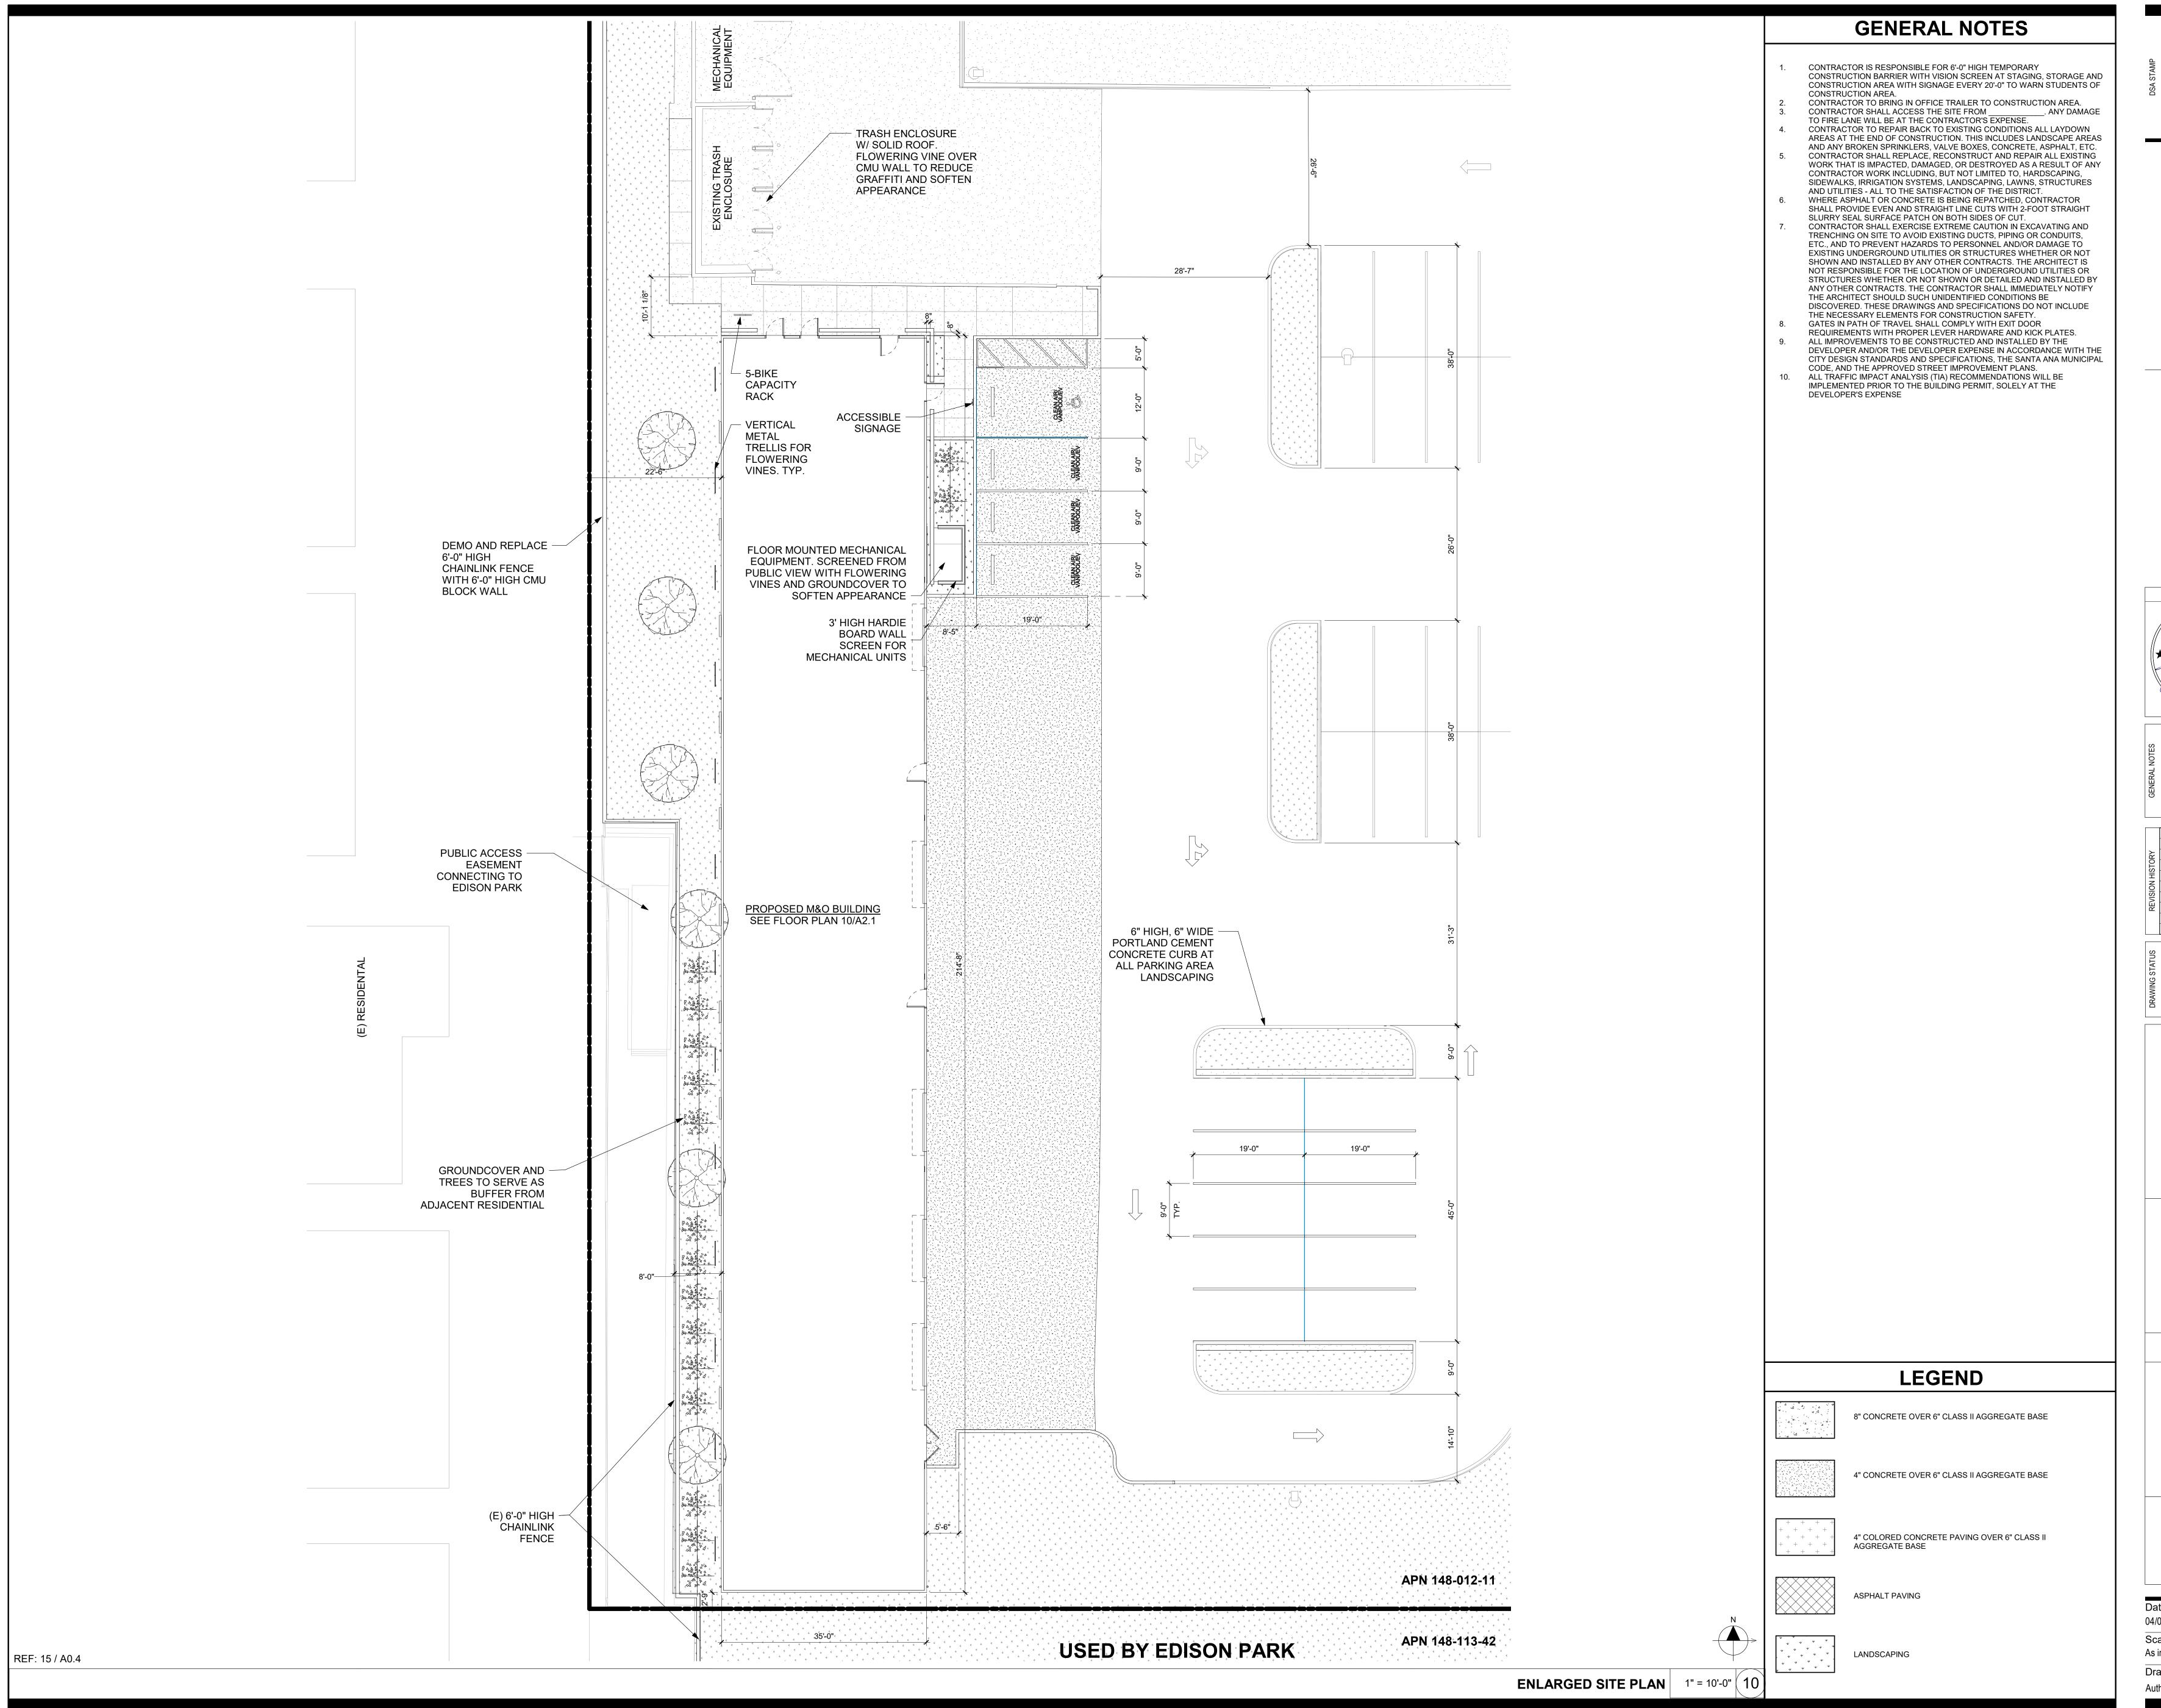


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11.28.2023 2000157 Project Number: Drawn By: Checked By: AS SPECIFIED

PRELIMINARY UTILITY

PLAN



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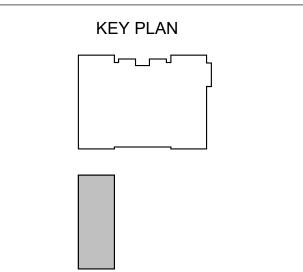
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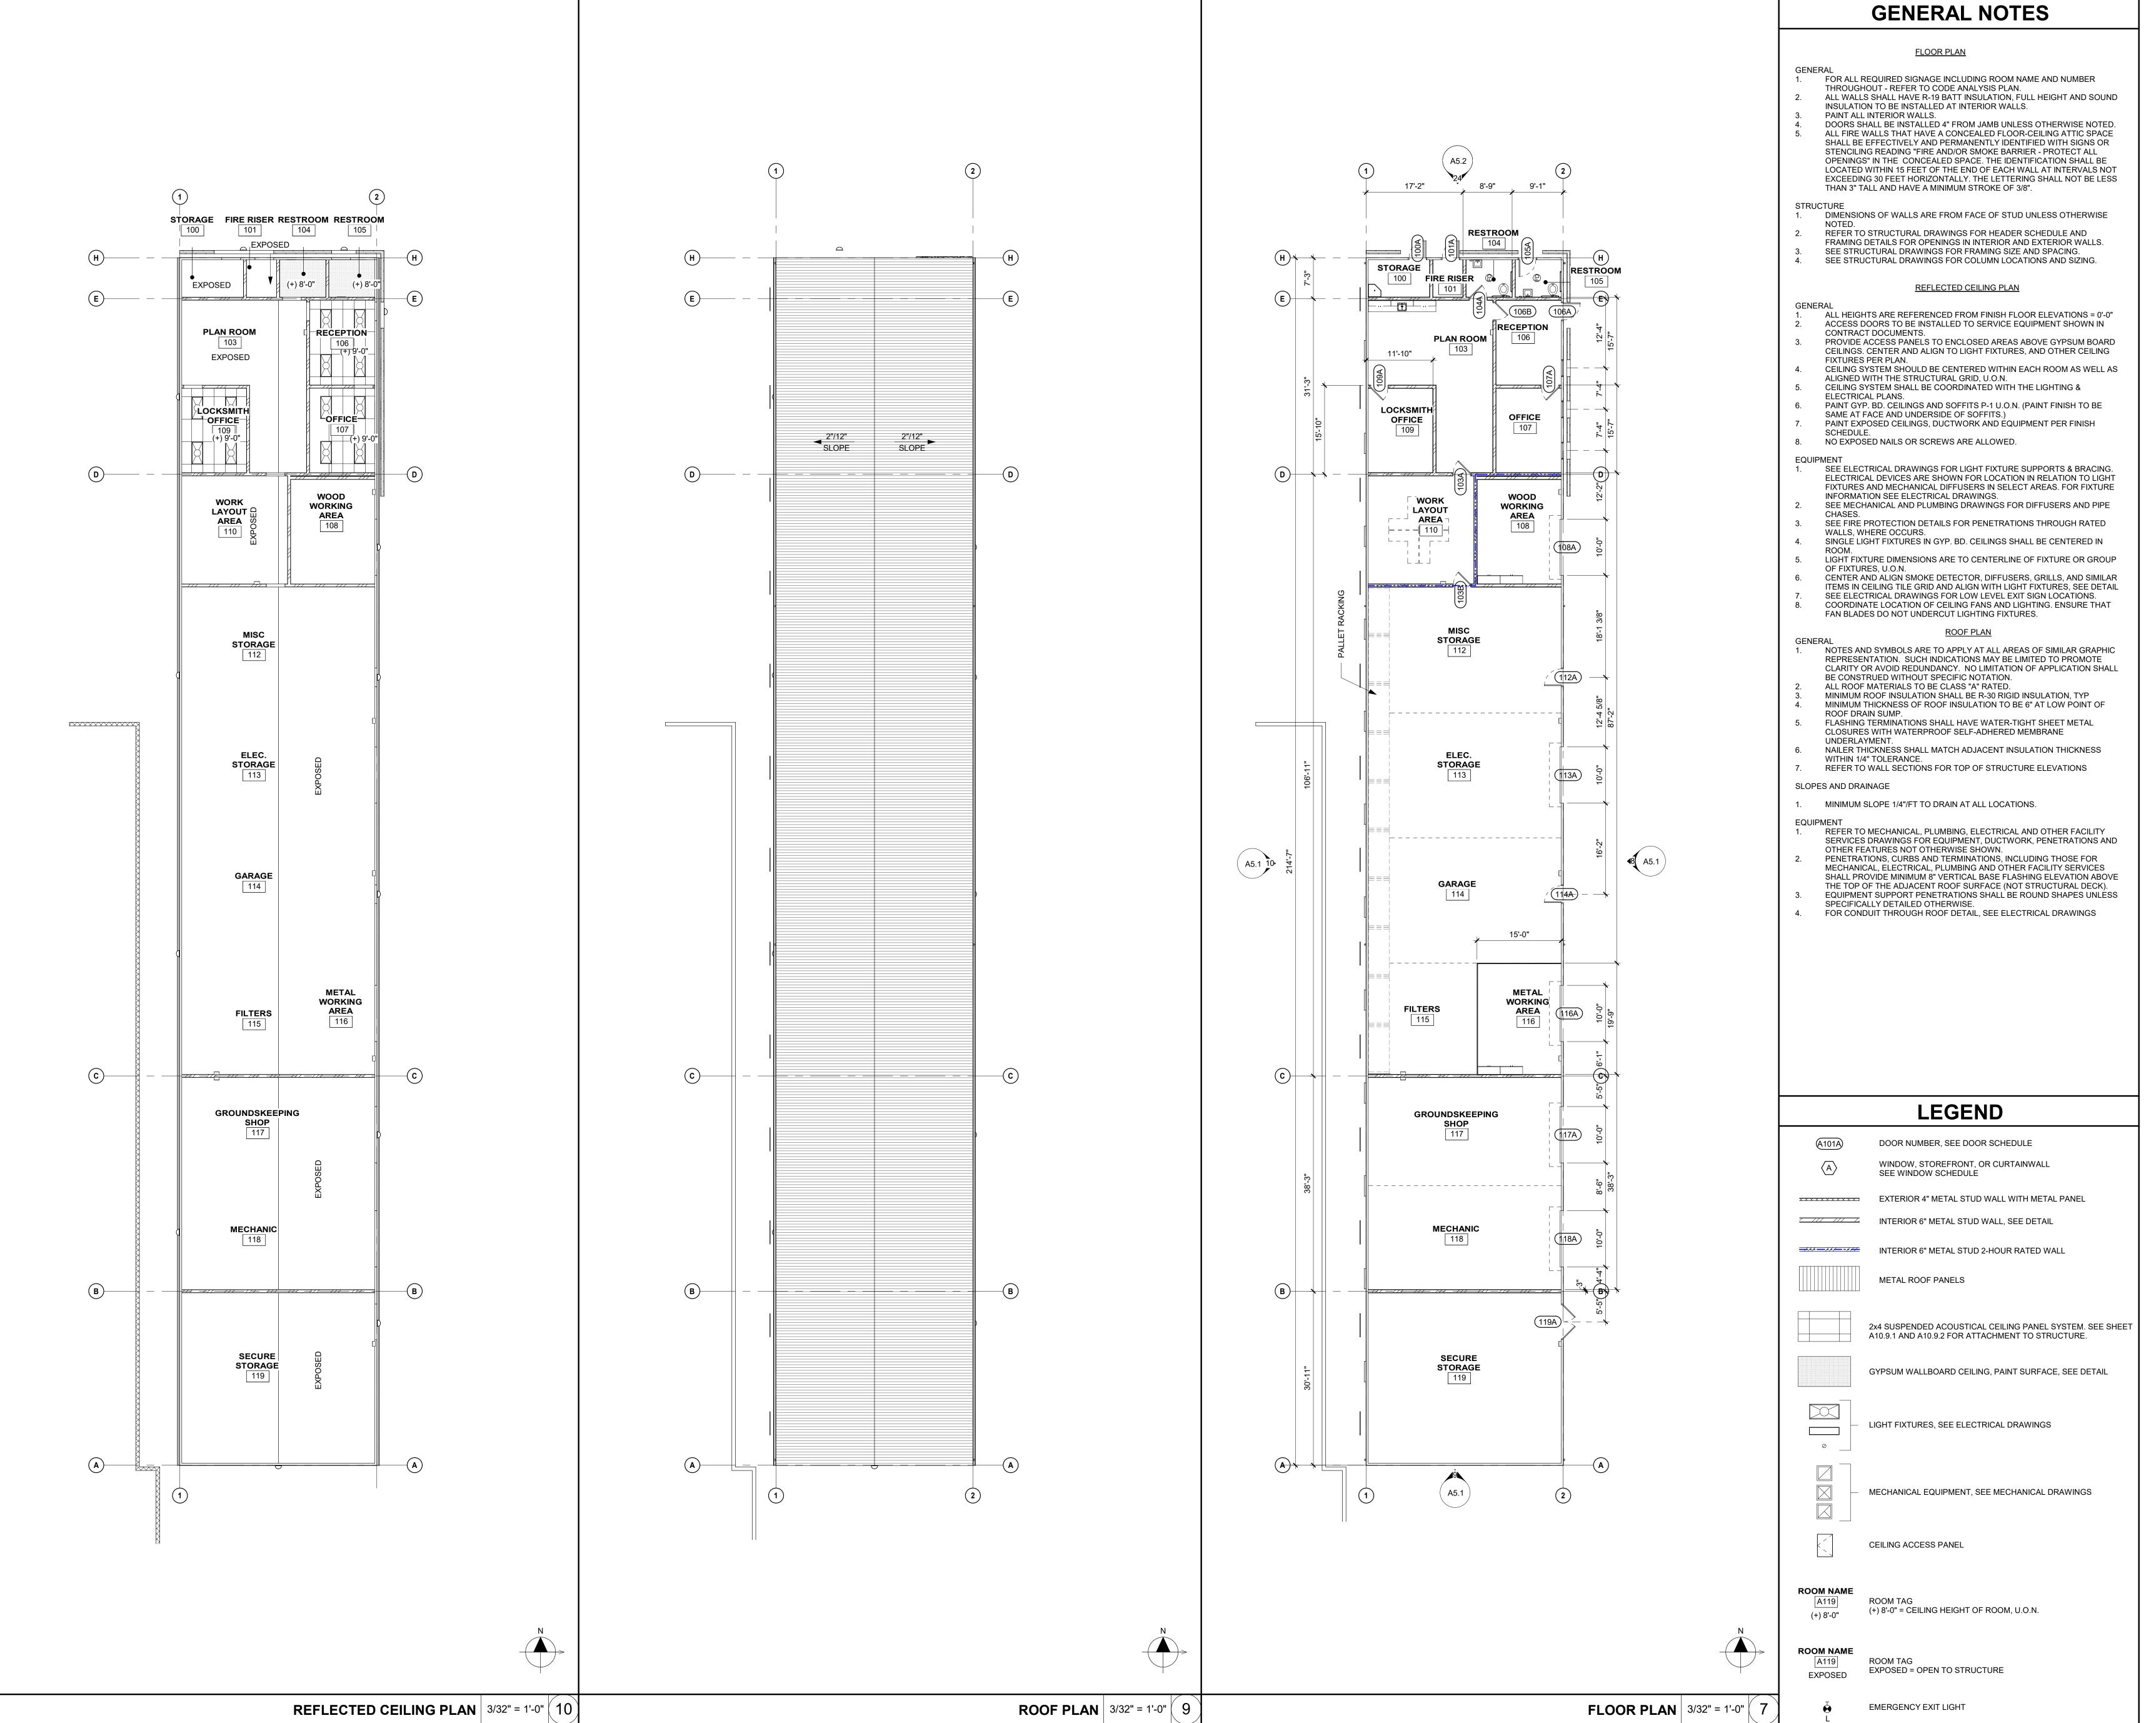
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ENLARGED SITE PLAN

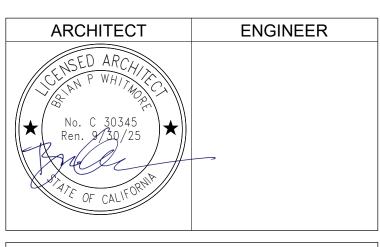
Project Number 04/05/2023 Drawing Number Scale As indicated

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KEY PLAN

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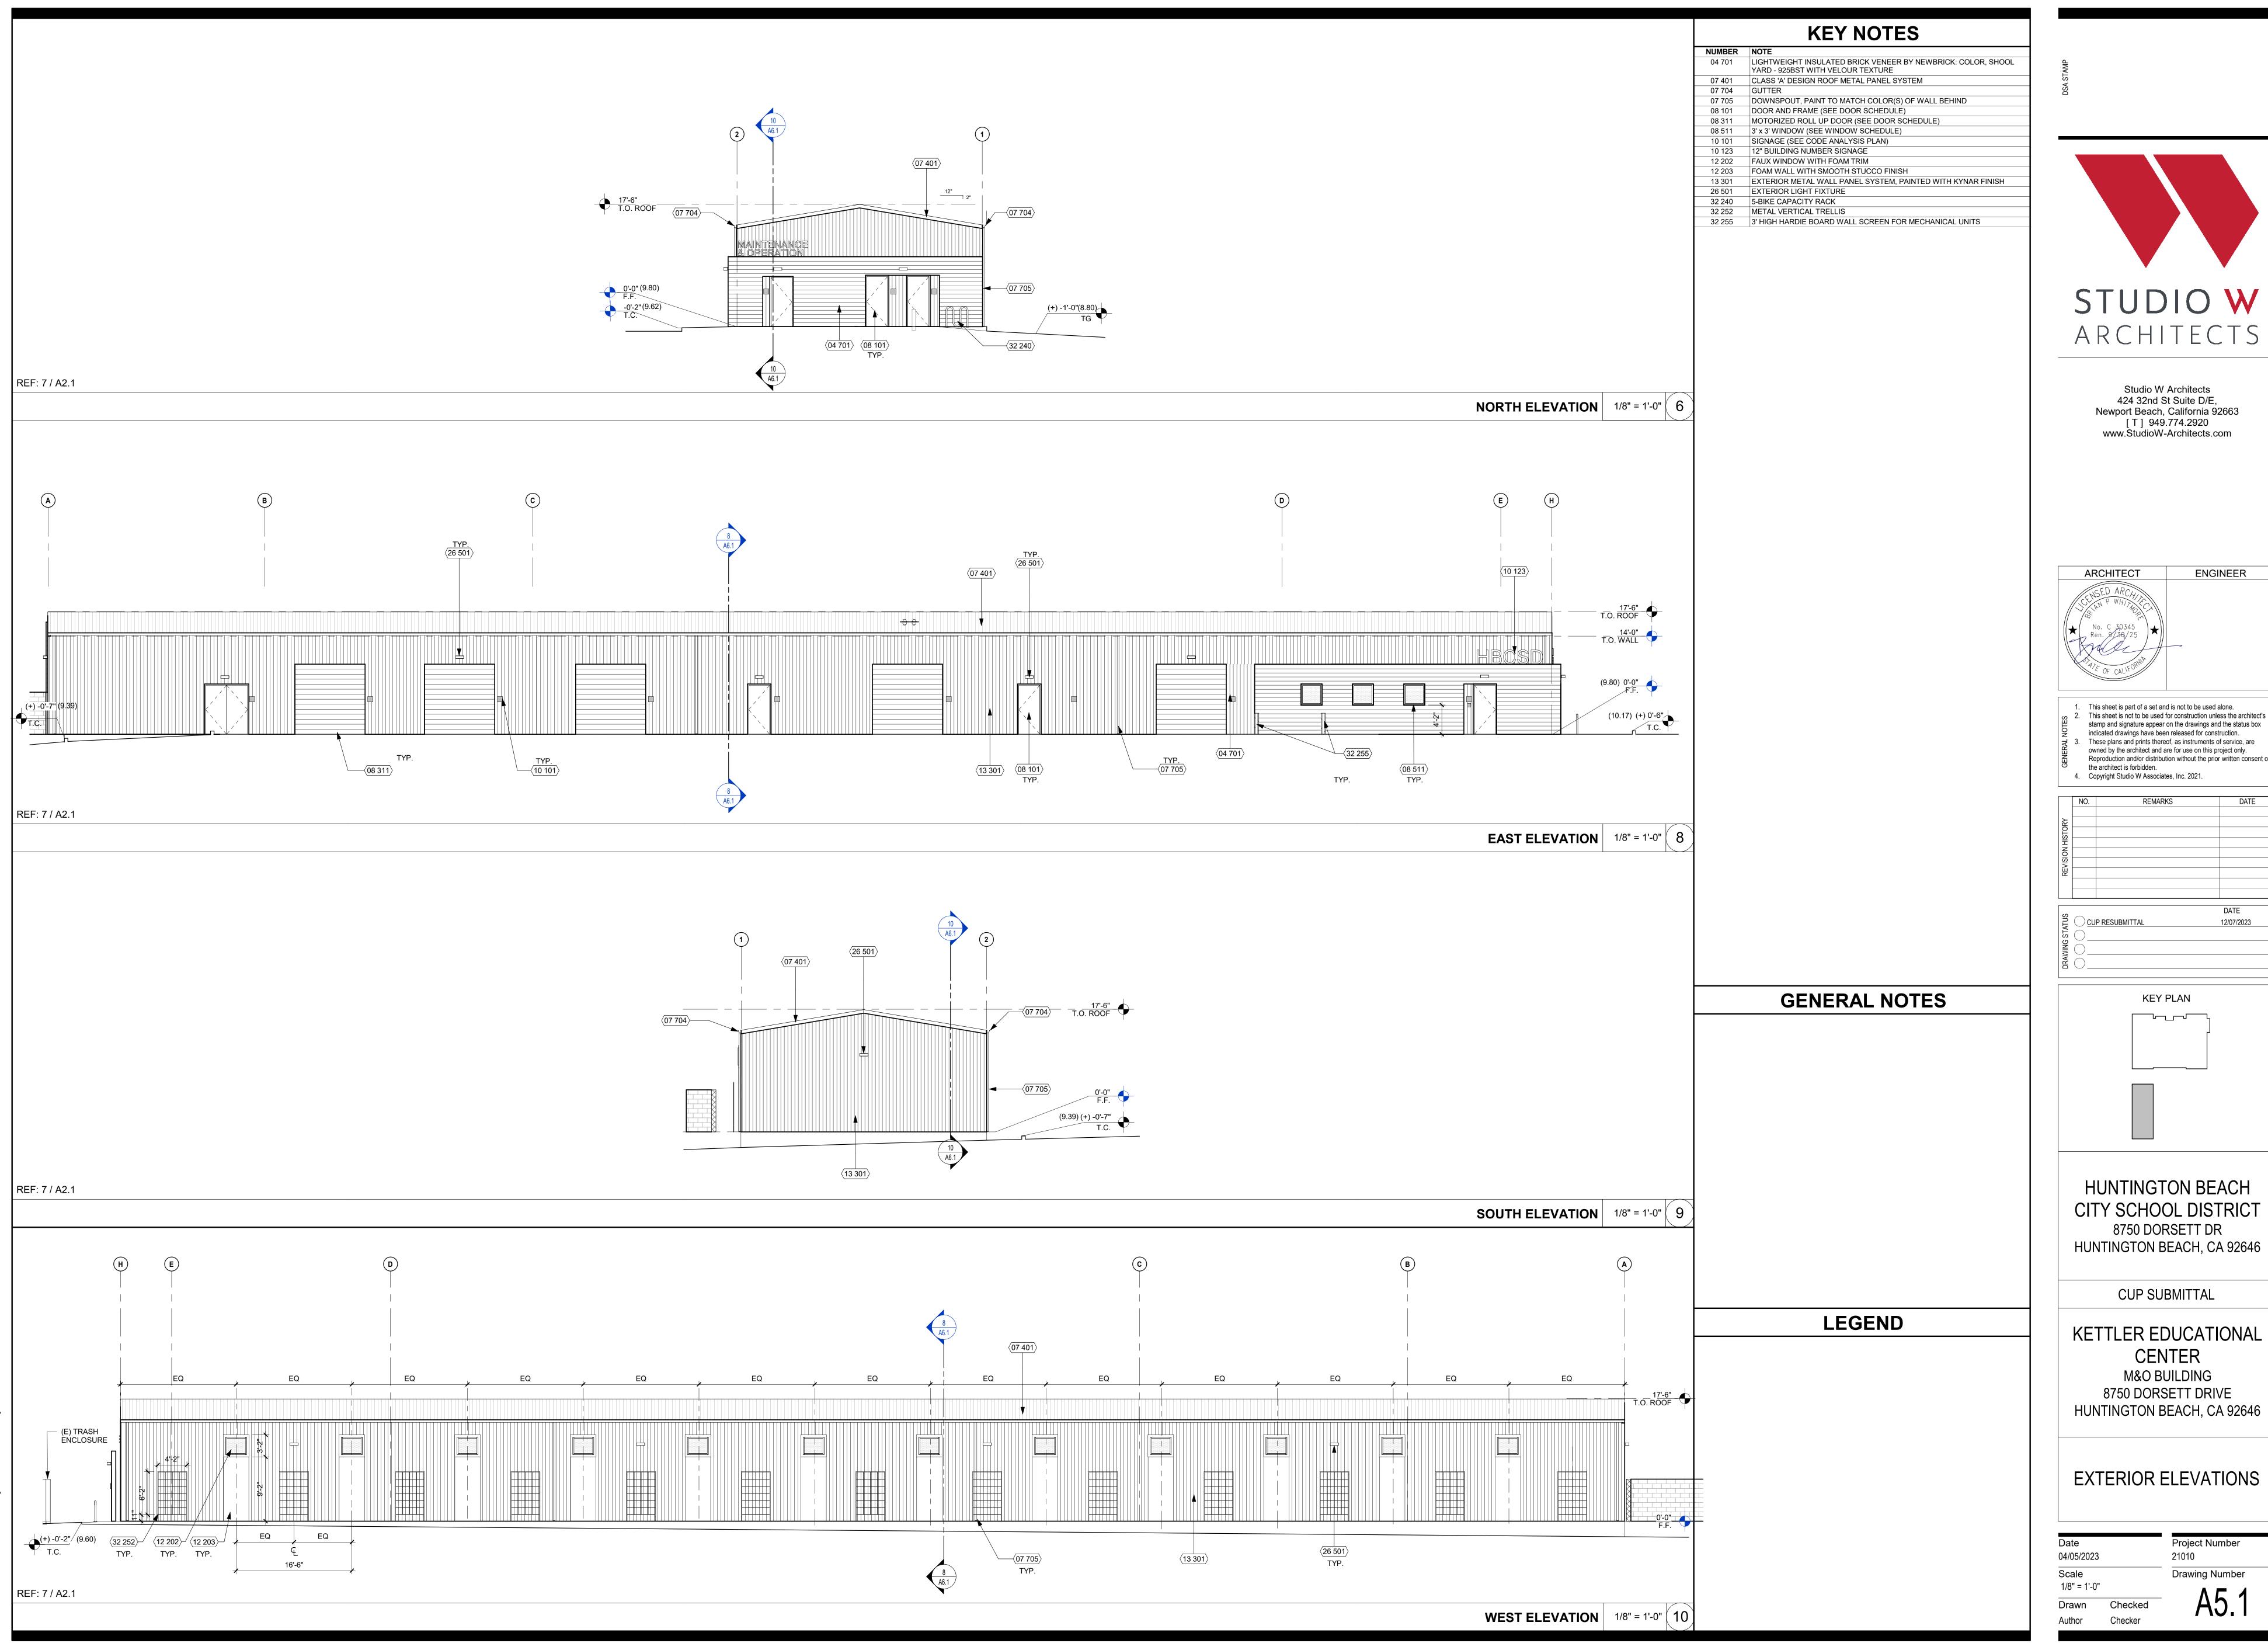
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**HUNTINGTON BEACH, CA 92646** 

FLOOR PLAN, ROOF PLAN, & RCP

Project Number 04/05/2023 Drawing Number Scale As indicated Drawn

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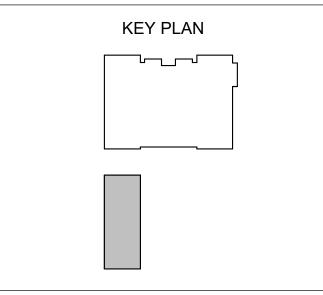
STUDIO W ARCHITECTS

> Studio W Architects 424 32nd St Suite D/E Newport Beach, California 92663 [T] 949.774.2920 www.StudioW-Architects.com

ARCHITECT	ENGINEER
No. C 30345 Ren. 9/36/25	

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REVISION HISTORY			
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**HUNTINGTON BEACH** CITY SCHOOL DISTRICT 8750 DORSETT DR HUNTINGTON BEACH, CA 92646

**CUP SUBMITTAL** 

KETTLER EDUCATIONAL CENTER **M&O BUILDING** 8750 DORSETT DRIVE

Project Number 04/05/2023 Drawing Number 1/8" = 1'-0" Checked Checker



STUDIO W
ARCHITECTS

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ARCHITECT ENGINEER

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NO. INCLINATION DATE

CUP RESUBMITTAL 12/07/2023

KEY PLAN

HUNTINGTON BEACH CITY SCHOOL DISTRICT 8750 DORSETT DR HUNTINGTON BEACH, CA 92646

**CUP SUBMITTAL** 

### KETTLER EDUCATIONAL CENTER M&O BUILDING

M&O BUILDING 8750 DORSETT DRIVE HUNTINGTON BEACH, CA 92646

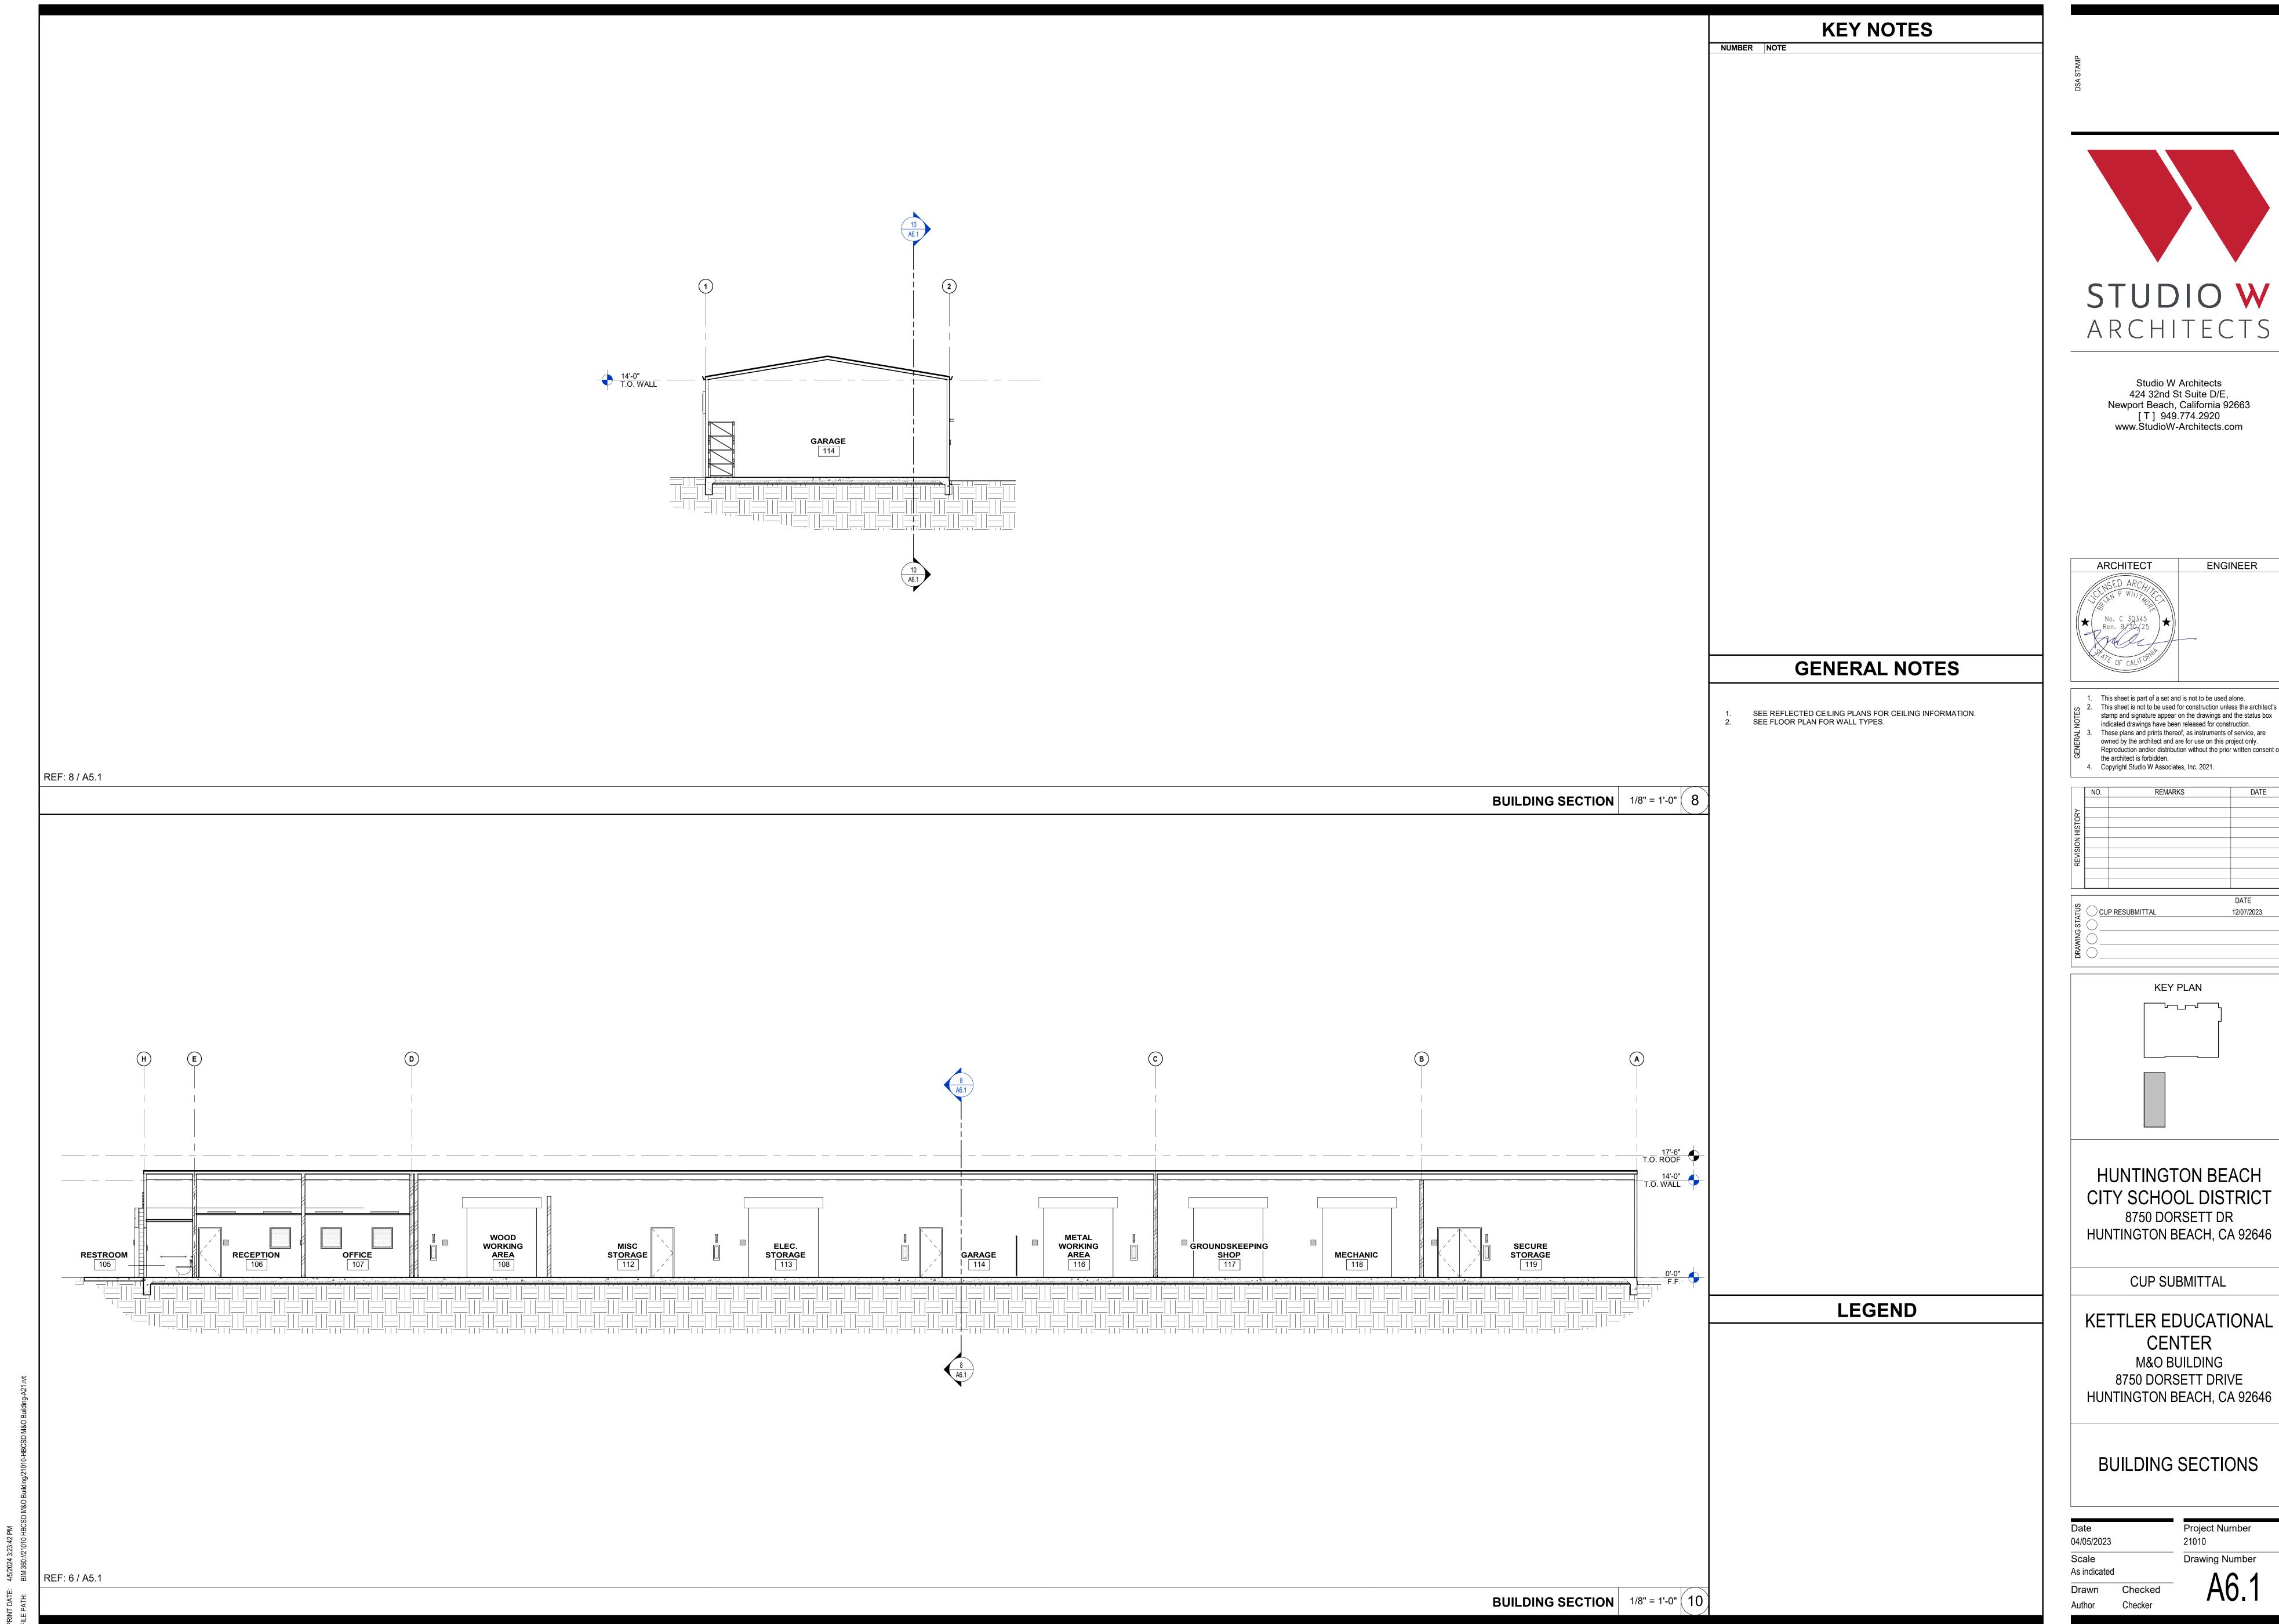
COLORED EXTERIOR ELEVATIONS

Date
04/05/2023
Scale
As indicated

Project Number 21010 Drawing Number

Drawn Checked
Author Checker

At





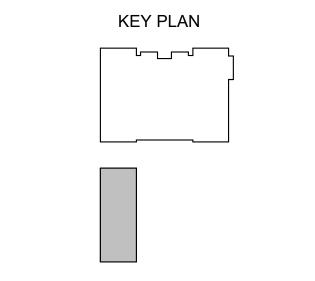
ARCHITECT	ENGINEER
★ No. C 30345 Ren. 9/30/25  ★ OF CALIFORNIA	

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CUP RESUBMITTAL	12/07/2023
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**HUNTINGTON BEACH** CITY SCHOOL DISTRICT

Project Number 21010 Drawing Number