ANGLE INCH FOOT JANITOR'S CLOSET

WOOD

WITHOUT

WINDOW

CHANNEL

NUMBER

DIAMETER

CL OR Q: CENTERLINE

W/0:

WDW:

WUB:

WATER CLOSET

WATERPROOFING

WELDED WIRE FABRIC

WALL UTILITY BOX

WIDE FLANGE

HUNTINGTON BEACH FIRE DEPARTMENT NOTES:

HIGH POINT

AIR CONDITIONING

INCANDESCENT

INCLUDING

INSULATION

INTERIOR

JANITOR

LOW POINT

LAMINATED

LAVATORY

LINOLEUM

LIGHTING

JOINT

HEATING, VENTILATING, AND

HEIGHT

INCH

HFATFR

HGT:

HTR:

HVAC:

INCAN:

INT:

LINO:

LTG:

- Automatic Fire Sprinklers are required. All new R occupancies are required to be protected by an automatic fire sprinkler system. The entire structure must be protected with an automatic fire sprinkler system in accordance with NFPA 13D. Separate plans (two sets) shall be submitted to the Fire Department for permits and approval. For Fire Department approval, reference that a fire sprinkler system will be installed in compliance with the California Fire Code, NFPA 13D, and City Specification # 420 Automatic Fire Sprinkler Systems in the
- Residential (SFD) Address Numbers shall be installed to comply with City Specification #428, Premise Identification. Number sets are required on front of the structure in a contrasting color with the background and shall be a minimum of four inches (4") high with one and one half inch (1/2") brush stroke. For Fire Department approval, reference compliance with City Specification #428, Premise Identification in the plan notes and portray the address location on the building.
- Fire/Emergency Access and Site Safety shall be maintained during project construction phases in compliance with CFC Chapter 33, Fire Safety During Construction And Demolition.
- Discovery of additional soil contamination or underground pipelines, etc., must be reported to the Fire Department immediately and the approved work plan modified accordingly in compliance with City Specification #431-92 Soil Clean-Up Standards.
- Outside City Consultants The Fire Department review of this project and subsequent plans may require the use of City consultants. The Huntington Beach City Council approved fee schedule allows the Fire Department to recover consultant fees from the applicant, developer or other responsible party.

DONNA DOAN RESIDENCE

PROPOSED NEW MAIN HOUSE AND ATTACHED ADU THREE STORY RESIDENTIAL

4731 Los Patos Ave., Huntington Beach, CA 92649 APN: 163-302-34 (PARCEL 4)



4731 Los Patos Ave to Warner-Lynn, Huntington Beach, Walk 0.3 mile, 5 min Google Maps



Map data ©2020 Google 200 ft ■

via Lynn Lane

5 min 0.3 mile




PROJECT DATA

LEGAL DESCRIPTION:					
ADDRESS:	4731 Los	s Patos Ave.,	Huntington	Beach,	CA 9264
					PARCEL ·
LOT:		BLOCK :			
TRACT:		PARCEL NU	MBER :	16	3-302-3
ZONING : RL		COUNTY:			ORANG
OCCUPANCY GROUP:	R-3/U	TYPE OF C	ONSTRUCTION	١:	V-I
NUMBER OF STORIES:	3				
LOT SIZE :				7,294	1.00 SQ.F
LOT COVERAGE: (50% MA)	K.+5%FOR PATIO	COVER=55%	3,646.50/7	294.00	= 50.00
SETBACK:		(نىىد)	
FRONT:					15'-5
REAR:					19'-2
LEFT_SIDE	•				10'-0
RIGHT SID	E:				5'-0
BUILDING	HEIGHT:				30'-0
SCOPE OF WORK					

	SCOPL OF WOR	
1. MAIN HOUSE	TOTAL LIVING AREA:	5,980.00 SQ.FT.
	1ST FLOOR:	2,081.00 SQ.FT.
	2ND FLOOR:	2,443.00 SQ.FT.
	3RD FLOOR:	1,456.00 SQ.FT.
	4 CAR GARAGE:	725.00 SQ.FT.
	PATIO COVER 1:	300.00 SQ.FT.
	PATIO COVER 2:	15.00 SQ.FT.
	PORCH:	136.50 SQ.FT.
	BALCONY:	136.50 SQ.FT.
	TOP ROOF DECK 1&2	352.00 SQ.FT.
2. ATTACHED ADU:	TOTAL LIVING AREA:	1,193.00 SQ.FT.
	1ST FLOOR:	389.00 SQ.FT.
	2ND FLOOR:	804 00 S0 FT

DRAWING SYMBOLS

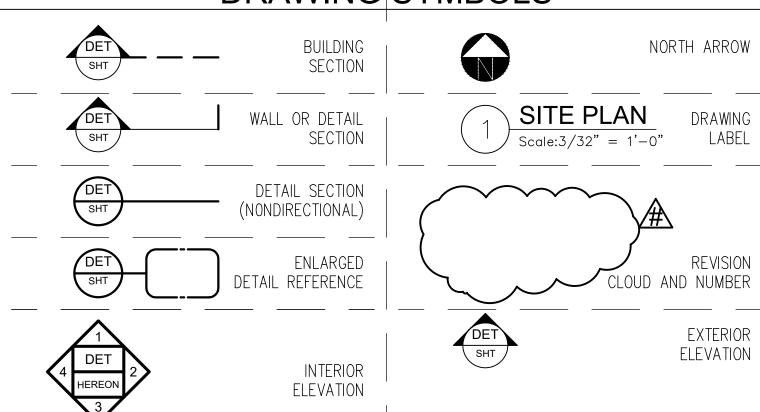

CHEET INDEX

	SUEET INDEX				
SH	HEET	DESCRIPTION			
1	A-000	TITLE SHEET, SHEET INDEX, VICINITY MAP,& PROJECT INFORMATION			
2	GRN-1	2022 CALGreen RESIDENTIAL MANDATORY MEASURES CHECKLIST			
3	GRN-2	2022 CALGreen RESIDENTIAL MANDATORY MEASURES CHECKLIST			
4	A-000.1	SPEC. MANU. SHEETS			
5	A-000.2	Construction and Demolition (C & D) Debris Re—Use and Recycling Program Form			
6	A-001	PROPOSED SITE & LANDSCAPE PLAN, AND WATER METER UPGRÅDE CHECK LIST			
7	A-101	PROPOSED 1ST FLOOR PLAN			
8	A-102	PROPOSED 2ND FLOOR PLAN			
9	A-103	PROPOSED 3RD FLOOR PLAN & TOP ROOF DECK PLAN AND DOOR & WINDOW SCHEDULE			
10	A-104	PROPOSED ROOF PLAN			
11	A-201	PROPOSED (EAST) FRONT & (WEST) REAR ELEVATION			
12	A-202	PROPOSED (NORTH) RIGHT & (SOUTH) LEFT ELEVATION			
13	A-301	PROPOSED SECTION A-A & B-B			
14	A-302	PROPOSED SECTION C-C & D-D			
15	AD-401	DETAILS			
16	AD-402	DETAILS T			
	W-501	DETAILS			
1Ω	0.0	CTDIICTIIDAI CENEDAI NOTEC			

STRUCTURAL GENERAL NOTES | FOUNDATION PLAN 2ND FLOOR FRAMING PLAN 3RD FLOOR FRAMING PLAN ROOF FRAMING PLAN FOUNDATION DETAILS

SIMPSON HIGH STRENGTH STRUCTURAL DETAILS SIMPSON HIGH STRENGTH STRUCTURAL DETAILS SIMPSON HIGH STRENGTH STRUCTURAL DETAIL TITLE 2

DONNA DOAN

LY PHAN P.E.

LY PHAN

PROPOSED 1ST FLOOR ELECTRICAL PLAN PROPOSED 2ND FLOOR ELECTRICAL PLAN PROPOSED 3RD FLOOR ELECTRICAL PLAN

(CELL): (714) 800-9969

squarekey2014@gmail.com **CONSULTANTS**

18962 CRIMSON CIR., HUNTINGTON BEACH, CA 92646

OWNER:

1. ARCHITECTURAL DESIGN: Q3 DESIGN & CONSTRU	CTION INC.	3. CIVIL (GRADING)
1218 CAMDEN PL. SANTA ANA, CA 92707		10820 KEENAN PL, STANTON, CA 90680
PHONE: 714 458 5374 - Email: DOQUOCPL@YAH	00.COM	PHONE:(714) 487 7037 — EMAIL: hdt.civil@yahoo.com
CONTACT PERSON:	QUOC DO	CONTACT PERSON:
REVIEWED BY: ONG, FRANCIS PHAT. ARCHITECT		
4122 GLENWOOD STREET ,IRVINE, CA 92604		
PHONE: (714) 296 3844 - Email: f660pro@yahoo	o.com	
CONTACT PERSON: ONG, FRANCIS PHAT.	ARCHITECT	

TRUONG DONG

2. STRUCTURE & T24 Dong Engineering Inc. 12682 Hoover St, Garden Grove, CA 92841 PHONE: (714) 204 2874 — Email: TRUONGDONG@GMAIL.COM

SOILS ENGINEER: GEOTECHNICAL INTERNATIONAL LAN & ASSOCIATES 13139 Harbor Boulevard, Garden Grove, CA 92843 PHONE: (714) 414-9215 - Email: Lanpham9@hotmail.com CONTACT PERSON: LAN PHAM

BUILDING CODE DESCRIPTION

DOIL	DINO CODE DESCRIPTION
2022 CALIFORN	IA BUILDING CODE (CBC).
2022 CALIFORN	IA RESIDENTIAL CODE (CRC).
2022 CALIFORN	IA MECHANICAL CODE (CMC).
2022 CALIFORN	IA PLUMBING CODE (CPC).
2022 CALIFORN	IA ELECTRICAL CODE (CEC).
2022 CALIFORN	IA GREEN BUILDING STANDARDS CODE (CGBSC).
2022 CALIFORN	IA ENERGY EFFICIENCY STANDARDS (CEES).
CITY OF HUNTIN	NGTON BEACH MUNICIPAL CODE

DEFERRED SUBMITTAL

1. FIRE SPRINKLERS	PLANS AND PERMIT SHALL BE SEPARAT	ED
2. SOLAR	PLANS AND PERMIT SHALL BE SEPARAT	ED
3. GRADING PLAN	PLANS AND PERMIT SHALL BE SEPARAT	ED
4. FENCING	PLANS AND PERMIT SHALL BE SEPARAT	ED

|23|SD1

27 WSWH1

1281WSWH2

30 T24.1

35 E-103

NAME:

ADDRESS:

PHONE:

FMAII:

CONTACT PERSON:

IWSWHJ

• FIRE SPRINKLER PLANS STAMPED APPROVED BY THE CITY OF HUNTINGTON BEACH FIRE DEPARTMENT SHALL BE PROVIDED AT THE SITE AT TIME OF FRAMING INSPECTION. • AUTOMATIC FIRE-SPRINKLERS TO BE PROVIDED THROUGHOUT.

GENERAL NOTES:

- THE SCOPE OF THIS PROJECT IS AS GENERALLY DEPICTED ON THESE PLANS. POINTS OF CONNECTION, NOT SPECIFICALLY DEPICTED, THAT NEED TO BE MADE ARE THE RESPONSIBILITY OF THE GENERAL CONTRACTOR. ALL WORK PERFORMED EVEN IN REMOTE AREAS OF THE BUILDING OR SITE, PERTAINING TO THIS PROJECT SHALL COMPLY WITH THE INTENT OF CONTRACT
- 2. IT SHALL BE THE RESPONSIBILITY OF EACH CONTRACTOR TO CHECK WITH THE ARCHITECTURAL DRAWINGS BEFORE FINALIZING THEIR BID AND BEFORE THE INSTALLATION OF THEIR WORK. ANY DISCREPANCY BETWEEN THE ARCHITECTURAL AND THE CONSULTING ENGINEER(S) DRAWINGS SHALL BE BROUGHT TO THE DESIGNER ATTENTION BY WRITTEN REQUEST FOR CLARIFICATION. ANY WORK INSTALLED IN CONFLICT WITH THE ARCHITECTURAL DRAWINGS SHALL BE CORRECTED BY THE CONTRACTOR AT HIS OWN EXPENSE AND AT NO EXPENSE TO THE OWNER OR DESIGNER
- 3. THESE DRAWINGS ARE BASED ON FIELD OBSERVATION AND DOCUMENTS FURNISHED BY THE OWNER. THE DESIGNER SHALL BE NOTIFIED IMMEDIATELY BY THE CONTRACTOR OF ANY DISCREPANCIES OR OTHER QUESTIONS PERTAINING TO THE CONTRACT DOCUMENTS. THE CONTRACTOR SHALL BE HELD RESPONSIBLE FOR THE RESULTS OF ANY ERRORS, DISCREPANCIES OR OMISSIONS THAT THE CONTRACTOR FAILED TO NOTIFY THE DESIGNER OF BEFORE CONSTRUCTION AND/OR FABRICATION OF THE WORK.
- 4. THE CONTRACTOR SHALL VERIFY ALL DIMENSIONS AND CONDITIONS OF EXISTING SITE. THE CONTRACTOR SHALL REPORT TO THE DESIGNER ALL CONDITIONS WHICH PREVENT THE PROPER EXECUTION OF ITS WORK. THE DRAWINGS SHALL NOT BE
- 5. CONSTRUCTION SHALL COMPLY WITH APPLICABLE EDITION OF UNIFORM BUILDING CODE, ALL APPLICABLE LOCAL, STATE AND FEDERAL CODES, ORDINANCES, LAWS, REGULATIONS AND PROTECTIVE COVENANTS GOVERNING THE WORK. IN CASE OF CONFLICTS, THE MORE STRINGENT REQUIREMENT SHALL GOVERN.
- 6. EXCEPT WHERE MORE STRINGENT REQUIREMENTS ARE NOTED OR SHOWN ON THE PLAN WORKMANSHIP AND MATERIALS SHALL CONFORM TO THE C.B.C LATEST EDITION.
- 7. WORKING DIMENSIONS SHALL NOT BE SCALE FROM DRAWING 8. ITEMS IDENTIFIED BY TRADE NAMES MAY BE SUBSTITUTED BY APPROVED EQUALS.

DESIGNING NOTES:

- 1. ALL MATERIAL AND FIXTURES ARE TO HAVE APPROVAL FROM APPROVED TESTING AGENCY.
- ROOFING MATERIAL TO BE "CLASS A" MIN. AND MINIMUM ROOF PITCH IS 1/2" PER FOOT
- LIGHT AND VENTILATION: A. ROOMS USED FOR LIVING, SLEEPING, EATING OR COOKING SHALL BE PROVIDED WITH NATURAL LIGHT EQUAL TO 8% OF THE FLOOR AREA WITH A MIN. 10 SF.
- BATH ROOMS, LAUNDRY AND SIMILAR ROOMS SHALL HAVE NATURAL VENTILATION NOT LESS THAN 4% OF THE FLOOR AREA OR 1.5 SF. MIN. OR PROVIDE MECHANICAL VENTILATION WITH A MIN. OF 5 AIR CHANGES
- STUCCO LATH & DRYWALL SHALL BE NAILED TO ALL STUDS AND TO TOP/BOTTOM PLATES.
- SAFETY GLAZING IS REQUIRED AT WARDROBE DOOR. WINDOWS AT BEDROOMS (EGRESS) MIN. CLR. OPENING, 5.7 sq. ft. MIN. CLR. HEIGHT, 24" MIN. CLR. WIDTH, 20"
- FINISHED SILL HEIGHT TO BE NOT MORE THAN 44" ABOVE FINISHED FLOOR
- PROVIDE APPROVED SMOOTH HARD NON-ABSORBENT FINISH TO 72"MIN. O/ DRAIN INLET INSTALL TEMPERED GLASS ENCLOSURE @ SHOWER, WITH DOOR 22" MIN. SWING OUT @ TUB / SHOWER COMBINATION
- CONTROL VALVES MUST BE PRESSURE BALANCED OR THERMOSTATIC MIXING VALVES. THE UNINCORPORATED AREA OF THE COUNTY IS CONSIDERED TO BE "SPECIAL WIND REGION" ALL ROOF
- FASTENERS SHALL BE INSTALLED PER MANUFACTURER'S INSTRUCTIONS.). EXTERIOR LATH PROVIDE TWO LAYERS OF GRADE D PAPER OVER ALL WOOD BASE SHEATHING. (CBC 2510.6)

- SLIDING GLASS DOORS AND WINDOWS LOCATED LESS THAN 16 FEET ABOVE ANY SURFACE AVAILABLE FOR USE BY THE PUBLIC SHALL BE CAPABLE OF BEING LOCKED SECURELY. MOVEABLE PANELS SHALL NOT BE EASILY REMOVED FROM THE FRAME. ALL MAIN OR FRONT ENTRY TO DWELLINGS SHALL BE ARRANGED SO THAT THE OCCUPANT HAS A MEW OF THE AREA IMMEDIATELY OUTSIDE WITHOUT OPENING DOOR. SUCH VIEW MAY BE PROMDED BY A DOOR VIEW, A VIEW PORT, WINDOW, OR OTHER OPENING.
- EXTERIOR WOODEN DOORS SHALL BE OF SOLID CORE CONSTRUCTION OR SHALL BE COVERED ON THE INSIDE FACE WITH 16 GAUGE SHEET METAL ATTACHED WITH SCREWS AT 6 INCH ON CENTERS AROUND THE PERIMETER. 4. ALL SWINGING DOORS SHALL BE EQUIPPED WITH A DEAD BOLT WITH A MINIMUM THROW OF 1 INCH AND AN EMBEDMENT OF NOT
- THE INACTIVE LEAF OF A PAIR OF DOORS AND THE UPPER LEAF OF DUTCH DOORS SHALL BE EQUIPPED WITH A DEAD BOLT. NON-REMOVABLE PINS SHALL BE USED IN PIN TYPE HINGES WHICH ARE ACCESSIBLE FROM THE OUTSIDE WHEN THE DOOR IS
- UNFRAMED GLASS DOORS SHALL BE FULLY TEMPERED GLASS NOT LESS THAN 1/3 INCH THICK.
- NARROW-FRAMED CLASS DOORS SHALL BE FULLY TEMPERED CLASS NOT LESS THAN 1/4 INCH THICK. ANY GLASS WHICH IS LOCATED WITH IN 40 INCHES OF THE LOCKING DEVICE ON A DOOR SHALL BE FULLY TEMPERED, OR HAVE
- APPROVED METAL BARS, SCREENS OR GRILLS. SOLID WOODEN HATCHWAYS LESS THAN 1-3/4 INCHES THICK SHALL BE COVERED ON THE INSIDE WITH 16 CAUGE SHEET METAL ATTACHED WITH SCREWS AT 6 INCH ON CENTER AROUND THE PERIMETER AND SHALL BE SECURED FROM THE INSIDE WITH , SLIDE BAR, SLIDE BOLTS, AND/OR PADLOCK WITH HARDENED STEEL SHACKLE. ALL OTHER OPENINGS LARGE THAN 96 SQUARE INCHES WITH A DIMENSION IN EXCESS OF 8 INCHES SHALL BE SECURED BY METAL BARS, SCREENS, OR GRILLS. (EXCEPTION
- . A DEVELOPMENT WHICH INCLUDES 3 OR MORE DWELLING UNITS SHALL BE PROMDED WITH FULLY—ENCLOSED GARAGES. GARAGES SPACE FOR EACH TENANT SHALL BE SEPARATED BY PARTITIONS OF 3% INCH PLYWOOD OR EQUIVALENT WITH STUDS SET NO MORE
- THAN 24 INCHES ON CENTER. 12. All doors & windows shall meet Huntington Beach Security ordinance

CITY OF HUNTINGTON BEACH NOTES:

- a. Every permit issued shall become invalid unless work authorized is commenced within 180 days or if the work authorized is suspended or abandon for a period of 180 days. A successful inspection must be obtained within 180 days. A permit may be extended if a written request stating justification for extension and an extension fee is received prior to expiration of the permit and granted by the Building Official. No more than one (1) extension may be granted. Permits that have become invalid shall pay a reactivation fee of approximately 50% of the original permit fee amount when the permit has been expired for up to six (6) months. When a permit has been expired for a period in excess of one (1) year, the reactivation fee shall be approximately 100% of the original permit fee. (R105.5)
- b. Concrete slab and under-floor inspections shall be made after in-slab or under-floor reinforcing steel and building service equipment, conduits, piping or other ancillary building trade products or equipment are installed, but before any concrete is placed or floor sheathing is installed, including the subfloor. (R109.1.1.1)
- Rough inspection of plumbing, mechanical, gas and electrical systems shall be made prior to covering or concealment, before fixtures or appliances are set or installed, and prior to framing inspection. (R109.1.2)
- d. The plans shall provide a statement specifically listing all required special inspections for the Special inspections shall be as required by Section 1705 of the CBC.
- e. Water piping materials within a building shall be in accordance with Sec. 604.1 of the California Plumbing Code. PEX, CPVC and other plastic water piping systems shall be installed in accordance with the requirements of Sec. 604 of the CPC, Installation Standards of Appendix I of the CPC and manufacturers recommended installation standards. CPVC water piping requires a Certification of Compliance as specified in Sec 604.1.1 of the CPC prior to permit issuance.



**HEET, SHEET INDEX, VICINITY & PROJECT INFORMATION

**DONNA DOAN RESIDENTAL TWO STORY RESIDENTIAL TWO STORY R

PRO

DATE: 06-25-2023


JOB NO.: 0321 184B

DRAWN BY: QD

SCALE: AS SHOWN

SHEET NO. 1

A-000

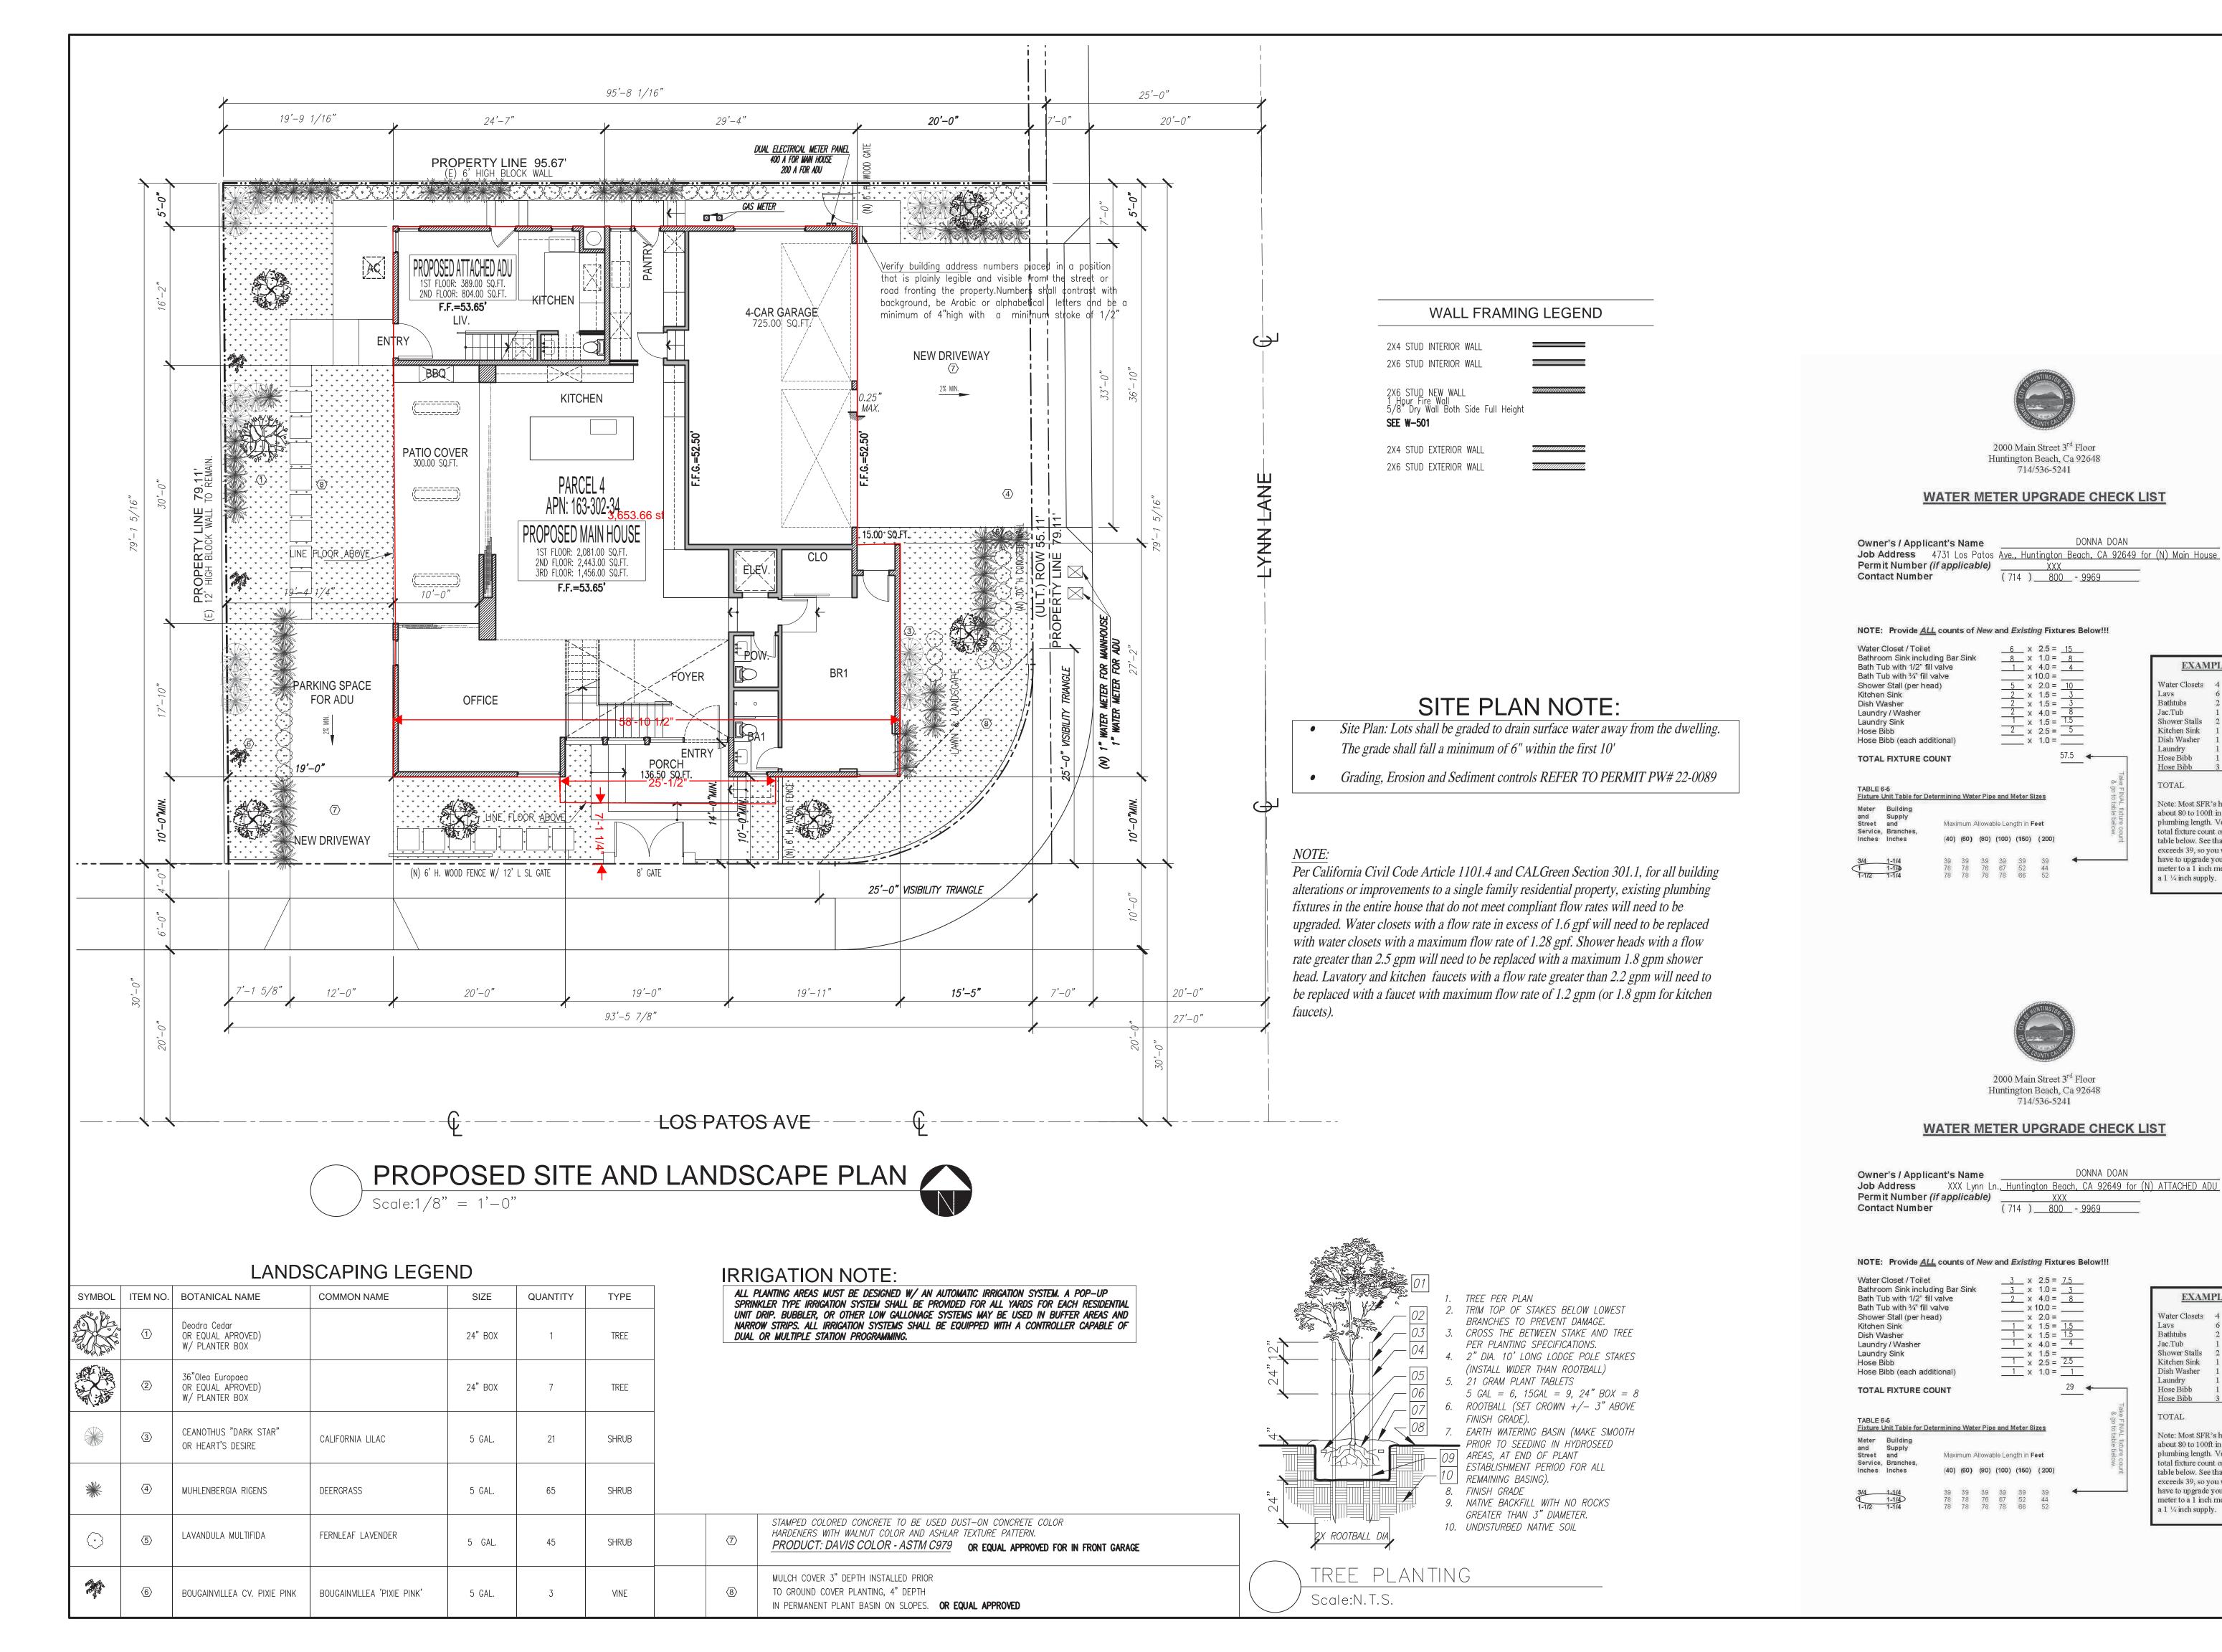



Water Closets 4 = 10

Note: Most SFR's have about 80 to 100ft in total

plumbing length. Verify your

meter to a 1 inch meter with

Water Closets 4 = 10

Lavs 6 = 6
Bathtubs 2 = 8
Jac.Tub 1 = 10
Shower Stalls 2 = 4

Note: Most SFR's have

about 80 to 100ft in total

plumbing length. Verify your

total fixture count on the

exceeds 39, so you would

have to upgrade your water meter to a 1 inch meter with

table below. See that 50.5

a 1 ¼ inch supply.

1 = 1.5

1 = 1.5

1 = 2.5

1 = 4

Kitchen Sink

Dish Washer

Laundry

Hose Bibb

TOTAL

Hose Bibb

a 1 ¼ inch supply.

otal fixture count on the

table below. See that 50.5 exceeds 39, so you would

1 = 1.5

1 = 2.5

Lavs Bathtubs Jac.Tub Shower Stalls Kitchen Sink

Dish Washer

Laundry

Hose Bibb

Hose Bibb

TOTAL

ENC! PROPOSED SITE AND LANDSCAPE PLAN
WATER METER UPGRADE CHECK LIST

DONNA DOAN RESIDE
PROPOSED NEW MAIN HOUSE AND ATTACH
TWO STORY RESIDENTIAL
TWO STORY RESIDENTIAL
AT31 Los Patos Ave., Huntington Beach, CA 926

PROJECT:

DATE: 06-25-2023 JOB NO.: 0321 184B


DRAWN BY: QD

OF 35

SHEET NO. 6

SCALE: 1/8"=1'-0"

A-001

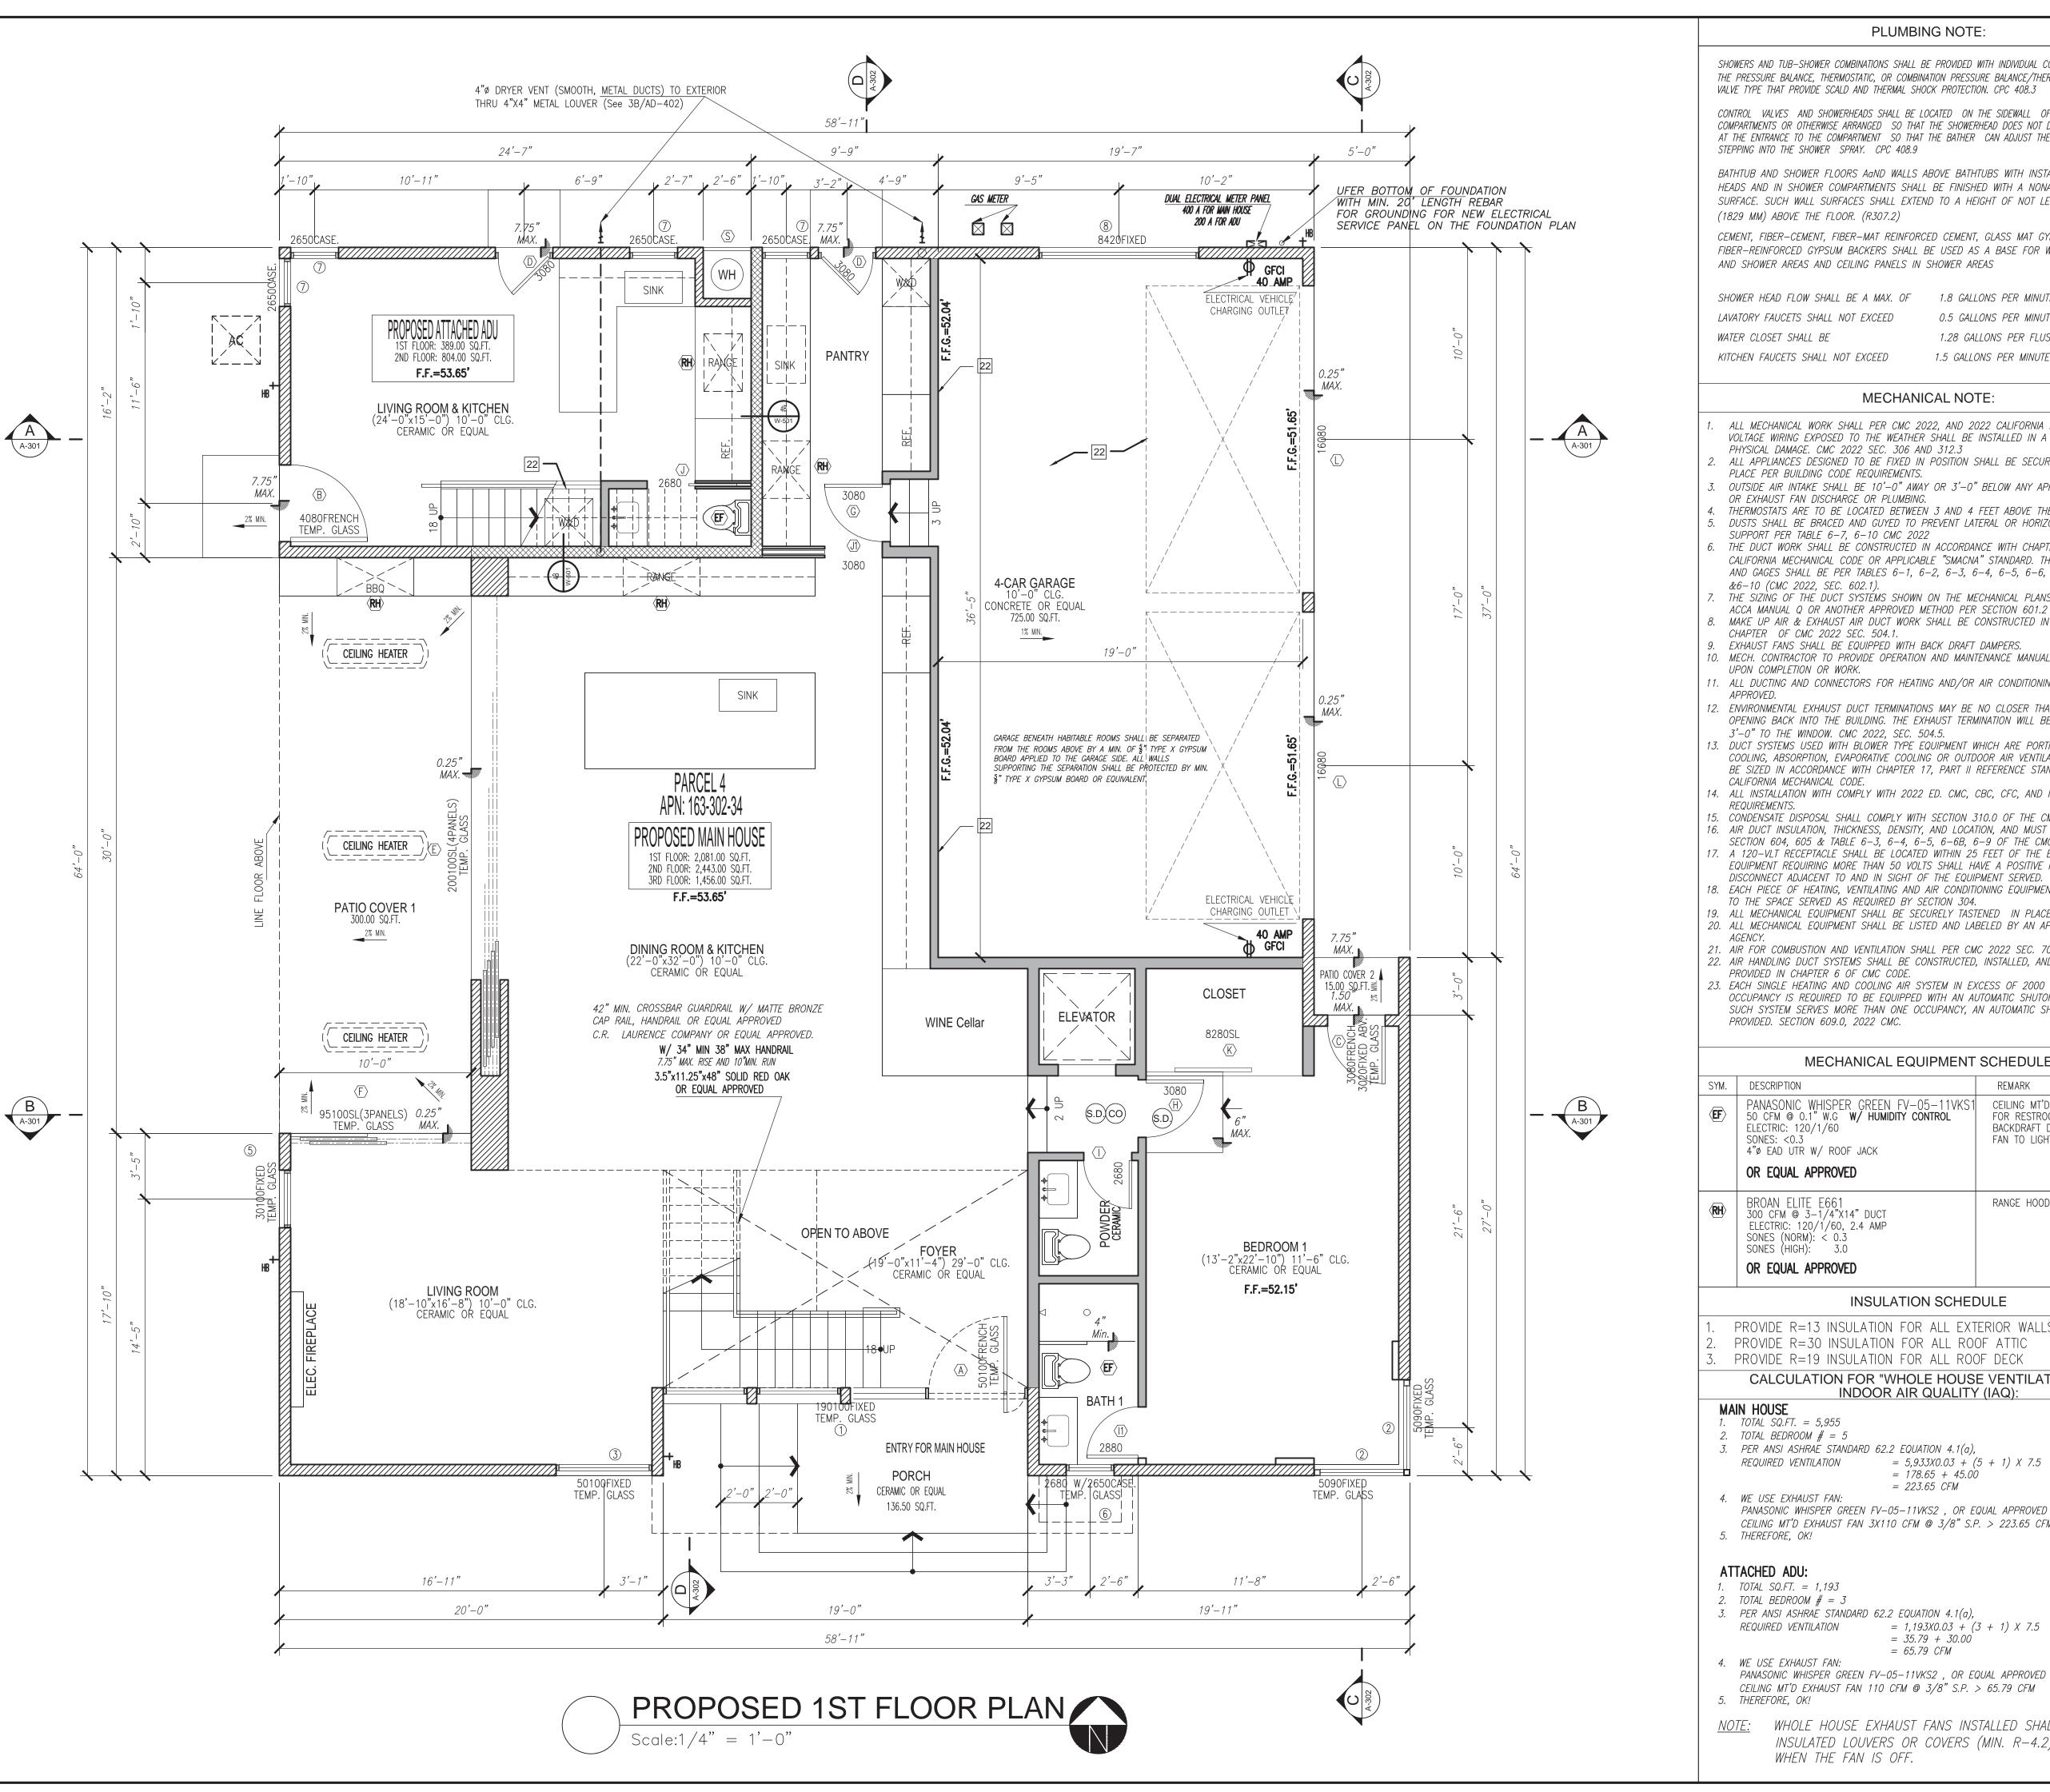

PLUMBING NOTE:

SHOWERS AND TUB-SHOWER COMBINATIONS SHALL BE PROVIDED WITH INDIVIDUAL CONTROL VALVES OF THE PRESSURE BALANCE, THERMOSTATIC, OR COMBINATION PRESSURE BALANCE/THERMOSTATIC MIXING VALVE TYPE THAT PROVIDE SCALD AND THERMAL SHOCK PROTECTION. CPC 408.3

CONTROL VALVES AND SHOWERHEADS SHALL BE LOCATED ON THE SIDEWALL OF SHOWER COMPARTMENTS OR OTHERWISE ARRANGED SO THAT THE SHOWERHEAD DOES NOT DISCHARGE DIRECTLY AT THE ENTRANCE TO THE COMPARTMENT SO THAT THE BATHER CAN ADJUST THE VALVES PRIOR TO STEPPING INTO THE SHOWER SPRAY. CPC 408.9

BATHTUB AND SHOWER FLOORS AAND WALLS ABOVE BATHTUBS WITH INSTALLED SHOWER HEADS AND IN SHOWER COMPARTMENTS SHALL BE FINISHED WITH A NONABSORBENT SURFACE. SUCH WALL SURFACES SHALL EXTEND TO A HEIGHT OF NOT LESS THAN 6 FEET (1829 MM) ABOVE THE FLOOR. (R307.2)

CEMENT, FIBER-CEMENT, FIBER-MAT REINFORCED CEMENT, GLASS MAT GYPSUM OR FIBER-REINFORCED GYPSUM BACKERS SHALL BE USED AS A BASE FOR WALL TILE IN TUB AND SHOWER AREAS AND CEILING PANELS IN SHOWER AREAS

1.5 GALLONS PER MINUTE AT 60 P.S.I..

SHOWER HEAD FLOW SHALL BE A MAX. OF 1.8 GALLONS PER MINUTE AT 80 P.S.I.. LAVATORY FAUCETS SHALL NOT EXCEED 0.5 GALLONS PER MINUTE AT 60 P.S.I.. WATER CLOSET SHALL BE 1.28 GALLONS PER FLUSH MAXIMUM

MECHANICAL NOTE:

- ALL MECHANICAL WORK SHALL PER CMC 2022, AND 2022 CALIFORNIA ENERGY CODE. LOW VOLTAGE WIRING EXPOSED TO THE WEATHER SHALL BE INSTALLED IN A MANNER TO PREVENT PHYSICAL DAMAGE. CMC 2022 SEC. 306 AND 312.3
- ALL APPLIANCES DESIGNED TO BE FIXED IN POSITION SHALL BE SECURELY FASTENED IN PLACE PER BUILDING CODE REQUIREMENTS.
- OUTSIDE AIR INTAKE SHALL BE 10'-0" AWAY OR 3'-0" BELOW ANY APPLIANCE VENT OUTLET OR EXHAUST FAN DISCHARGE OR PLUMBING.
- THERMOSTATS ARE TO BE LOCATED BETWEEN 3 AND 4 FEET ABOVE THE FLOOR. DUSTS SHALL BE BRACED AND GUYED TO PREVENT LATERAL OR HORIZONTAL SWING. DUCTS
- SUPPORT PER TABLE 6-7, 6-10 CMC 2022 THE DUCT WORK SHALL BE CONSTRUCTED IN ACCORDANCE WITH CHAPTER 6 OF THE 2022 CALIFORNIA MECHANICAL CODE OR APPLICABLE "SMACNA" STANDARD. THE DUCT MATERIALS AND GAGES SHALL BE PER TABLES 6-1, 6-2, 6-3, 6-4, 6-5, 6-6, 6-7, 6-8, 6-9,
- THE SIZING OF THE DUCT SYSTEMS SHOWN ON THE MECHANICAL PLANS WILL COMPLY WITH ACCA MANUAL Q OR ANOTHER APPROVED METHOD PER SECTION 601.2 OF THE 2022 CMC. R. MAKE UP AIR & EXHAUST AIR DUCT WORK SHALL BE CONSTRUCTED IN ACCORDANCE WITH CHAPTER OF CMC 2022 SEC. 504.1.
- EXHAUST FANS SHALL BE EQUIPPED WITH BACK DRAFT DAMPERS. 10. MECH. CONTRACTOR TO PROVIDE OPERATION AND MAINTENANCE MANUALS TO THE OWNER UPON COMPLETION OR WORK.
- 1. ALL DUCTING AND CONNECTORS FOR HEATING AND/OR AIR CONDITIONING SHALL BE UL 181
- 2. ENVIRONMENTAL EXHAUST DUCT TERMINATIONS MAY BE NO CLOSER THAN 3'-0" TO AN OPENING BACK INTO THE BUILDING. THE EXHAUST TERMINATION WILL BE NO CLOSER THAN 3'-0" TO THE WINDOW. CMC 2022, SEC. 504.5.
- '3. DUCT SYSTEMS USED WITH BLOWER TYPE EQUIPMENT WHICH ARE PORTIONS OF A HEATING, COOLING, ABSORPTION, EVAPORATIVE COOLING OR OUTDOOR AIR VENTILATION SYSTEM SHALL BE SIZED IN ACCORDANCE WITH CHAPTER 17, PART II REFERENCE STANDARDS OF THE CALIFORNIA MECHANICAL CODE.
- 14. ALL INSTALLATION WITH COMPLY WITH 2022 ED. CMC, CBC, CFC, AND NFPA 2022 REQUIREMENTS.
- 15. CONDENSATE DISPOSAL SHALL COMPLY WITH SECTION 310.0 OF THE CMC 2022. 16. AIR DUCT INSULATION, THICKNESS, DENSITY, AND LOCATION, AND MUST COMPLY WITH
- SECTION 604, 605 & TABLE 6-3, 6-4, 6-5, 6-6B, 6-9 OF THE CMC 2022. 7. A 120-VLT RECEPTACLE SHALL BE LOCATED WITHIN 25 FEET OF THE EQUIPMENT, AND EQUIPMENT REQUIRING MORE THAN 50 VOLTS SHALL HAVE A POSITIVE MEANS OF
- DISCONNECT ADJACENT TO AND IN SIGHT OF THE EQUIPMENT SERVED. 18. EACH PIECE OF HEATING, VENTILATING AND AIR CONDITIONING EQUIPMENT SHALL BE LABELED
- TO THE SPACE SERVED AS REQUIRED BY SECTION 304. 19. ALL MECHANICAL EQUIPMENT SHALL BE SECURELY TASTENED IN PLACE BY SECTION 304.4 20. ALL MECHANICAL EQUIPMENT SHALL BE LISTED AND LABELED BY AN APPROVED TESTING
- 21. AIR FOR COMBUSTION AND VENTILATION SHALL PER CMC 2022 SEC. 701 22. AIR HANDLING DUCT SYSTEMS SHALL BE CONSTRUCTED, INSTALLED, AND INSULTED AS
- PROVIDED IN CHAPTER 6 OF CMC CODE. 23. EACH SINGLE HEATING AND COOLING AIR SYSTEM IN EXCESS OF 2000 CFM IN THIS TYPE OCCUPANCY IS REQUIRED TO BE EQUIPPED WITH AN AUTOMATIC SHUTOFF. ALSO, WHENEVER SUCH SYSTEM SERVES MORE THAN ONE OCCUPANCY, AN AUTOMATIC SHUT OFF SHALL BE PROVIDED. SECTION 609.0, 2022 CMC.

MECHANICAL EQUIPMENT SCHEDULE

SYM.	DESCRIPTION	REMARK
(F)	PANASONIC WHISPER GREEN FV-05-11VKS1 50 CFM @ 0.1" W.G W/ HUMIDITY CONTROL ELECTRIC: 120/1/60 SONES: <0.3 4"Ø EAD UTR W/ ROOF JACK OR EQUAL APPROVED	CEILING MT'D EXHAUST FAN FOR RESTROOM. FURNISH W/ BACKDRAFT DAMPER. INTERLOCK FAN TO LIGHT SWITCH
(RH)	BROAN ELITE E661 300 CFM @ 3-1/4"X14" DUCT ELECTRIC: 120/1/60, 2.4 AMP SONES (NORM): < 0.3	RANGE HOOD FOR KITCHEN

INSULATION SCHEDULE

PROVIDE R=13 INSULATION FOR ALL EXTERIOR WALLS PROVIDE R=30 INSULATION FOR ALL ROOF ATTIC

PROVIDE R=19 INSULATION FOR ALL ROOF DECK

CALCULATION FOR "WHOLE HOUSE VENTILATION FOR **INDOOR AIR QUALITY (IAQ):**

MAIN HOUSE

- 1. $TOTAL \ SQ.FT. = 5,955$ 2. TOTAL BEDROOM # = 5
- 3. PER ANSI ASHRAE STANDARD 62.2 EQUATION 4.1(a), = 5,933X0.03 + (5 + 1) X 7.5REQUIRED VENTILATION
 - = 178.65 + 45.00 = 223.65 CFM
- 4. WE USE EXHAUST FAN: PANASONIC WHISPER GREEN FV-05-11VKS2, OR EQUAL APPROVED CEILING MT'D EXHAUST FAN 3X110 CFM @ 3/8" S.P. > 223.65 CFM

ATTACHED ADU:

- 1. TOTAL SQ.FT. = 1,193
- 2. TOTAL BEDROOM # = 33. PER ANSI ASHRAE STANDARD 62.2 EQUATION 4.1(a), = 1.193X0.03 + (3 + 1) X 7.5REQUIRED VENTILATION
- = 35.79 + 30.00 = 65.79 CFM 4. WE USE EXHAUST FAN:
- <u>NOTE:</u> WHOLE HOUSE EXHAUST FANS INSTALLED SHALL HAVE

INSULATED LOUVERS OR COVERS (MIN. R-4.2) WHICH CLOSE WHEN THE FAN IS OFF.

FLOOR PLAN NOTES

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1ST

OSED

01. DOUBLE SINK WITH GARBAGE DISPOSAL (REFER TO

- INTERIOR ELEVATIONS) 02. BUILT-IN DISHWASHER WITH AIR GAP (REFER TO INTERIOR
- *ELEVATIONS)* 03. DROP-IN COOK TOP RANGE WITH EXHAUST HOOD 04. PROVIDE 39" REFRIGERATOR SPACE (PROVIDE PLUMBING
- RECESSED IN WALL FOR ICE MAKER 05. 30" WIDE MICROWAVE OVEN OVER CONVENTIONAL OVEN. MANUFACTURER TO BE DETERMINED BY OWNER (REFER TO
- SPECIFICATIONS) 06. PANTRY WITH ADJUSTABLE SHELVES U.N.O. (REFER TO
- INTERIOR ELEVATIONS) 07. LINE OF CABINETS/SHELF ABOVE (REFER TO INTERIOR ELEVATIONS)
- 08. PROVIDE CURTAIN ROD 09. 32" X 60" FIBERGLASS TUB WITH SHOWER TO 72" A.F.F. WITH SHOWER HEAD AT +80" A.F.F.
- 10. 42" X 60" FIBERGLASS OVAL TUB ON 18" HIGH MOISTURE RESISTANT PLATFORM
- . 114" X 42" FIBERGLASS TUB/SHOWER WITH WAINSCOT TO 78"ABOVE FINISH FLOOR AND SHOWER HEAD AT 80" A.F.F.
- 2. RECESSED MEDICINE CABINET (REFER TO INTERIOR ELEVATIONS)
- 13. SHATTER RESISTANT SHOWER ENCLOSURE FULLY TEMPERED OR LAMINATED SAFETY GLASS
- 14. WASHER SPACE (PROVIDE RECESS NICHE IN WALL FOR PLUMBING AND PROVIDE WASTE LINE)
- 15. DRYER SPACE (VENT TO O.S.A.)
- 16. LINE OF EXHAUST VENT 7. BACK DRAFT DAMPER
- 18. WATER HEATER PER C.M.C. PROVIDE SEISMIC STRAPS AT POINTS WITHIN THE UPPER AND LOWER ONE—THIRD OF ITS VERTICAL DIMENSION. LOWER STRAP LOCATED TO MAINTAIN MINIMUM 4"
- DISTANCE ABOVE CONTROLS. - PLACE W/H ON 18" HIGH RIGID PLATFORM. - PROVIDE P.T. RELIEF VALVE TO OUTSIDE OR APPROVED
- 19. FORCED AIR UNIT PER C.M.C.
- PROVIDE RIGID WOOD PLATFORM W/ R.A.G. (14" MIN.) - PROVIDE CONDENSATE LINE TO DRAIN OUTSIDE OR APPROVED TRAPPED DRAIN (REFER TO HVAC DRAWINGS) - VERIFY SIZE AND CLEARANCE
- 20. AIR CONDITIONER PAD (VERIFY SIZE WITH MANUFACTURER) 21. PEDESTAL SINK
- 22. PROVIDE 5/8" TYPE 'X' APPROVED GYPSUM BOARD AT GARAGE AT ALL WALLS, CEILINGS, BEAMS AND SUPPORTING MEMBERS ADJACENT TO HABITABLE AREAS. PROVIDE 2-LAYERS AT MEMBERS SPACED GREATER THAN 16" O.C. (REFER TO GENERAL NOTE SHEETS IN SPECIFICATIONS FOR
- 24. NON-COMBUSTIBLE HEARTH MINIMUM 20" IN FRONT OF AND 12" ON EACH SIDE OF FIREPLACE OPENING
- 25. LAUNDRY SINK 26. LINE OF SHELF (REFER TO PLAN FOR HEIGHT)
- 27. LINE OF SOFFIT ABOVE 28. LINE OF SHELF ABOVE (REFER TO PLAN FOR HEIGHT)
- 29. LINEN (REFER TO INTERIOR ELEVATION) 30. SHELF AND POLE *31. SHELF AND DOUBLE POLE*
- 32. 22" X 30" MINIMUM ATTIC ACCESS (30" X 30" MINIMUM W/ ATTIC MTD. FAU)
- 33. GAS CO. SERVICE RISER(VERIFY LOCATION W/UTILITY CO.) 34. ELECTRIC SERVICE MAIN - PROVIDE UFER GROUND (VERIFY LOCATION WITH UTILITY COMPANY)
- 35. LOW WALL (REFER TO PLAN FOR HEIGHT) 37. HAND MADE SHOWER PAN - SEE PLAN FOR SIZE 38. DUCT CHASE
- 39. DEAD BOLT AT TOP AND BOTTOM OF ENTRY DOOR AND TOP ONLY OF INTERIOR DOORS 40. WATER CLOSET (MAXIMUM 1.28 GALLONS PER FLUSH)

SMOKE & CARBON MONOXIDE ALARM NOTES

THE ALARM DEVICES SHALL BE INTERCONNECTED IN SUCH A MANNER THAT THE ACTUATION OF ONE ALARM WILL ACTIVATE ALL OF THE ALARMS IN INDIVIDUAL UNIT.

SMOKE ALARMS SHALL RECEIVE THEIR PRIMARY POWER FROM THE BUILDING WIRING AND BE EQUIPPED WITH A BATTERY

CARBON MONOXIDE ALARMS SHALL RECEIVE THEIR PRIMARY POWER FROM THE BUILDING WIRING AND BE EQUIPPED WITH A

BATTERY BACK-UP.

SMOKE DETECTOR, U.L 217 APPROVED-CEILING MOUNTED U.N.(CARBON MONOXIDE ALARMS,

WALL FRAMING LEGEND

2X4 STUD INTERIOR WALL 2X6 STUD INTERIOR WAL

2X6 STUD NEW WALL 1 Hour Fire Wall 5/8" Dry Wall Both Side Full Height SEE W-501

PROVIDE FIRE BLOCKING IN CONCEALED SPACE VERTICALLY AND HORIZONTALLY

IN ACCORDANCE WITH CRC R302.11

2X4 STUD EXTERIOR WALL 2X6 STUD EXTERIOR WALL

SHEET NO. 7


A-101


DATE: 06-25-2023

JOB NO.: 0321 184B

DRAWN BY: QD

SCALE: 1/4"=1'-0"

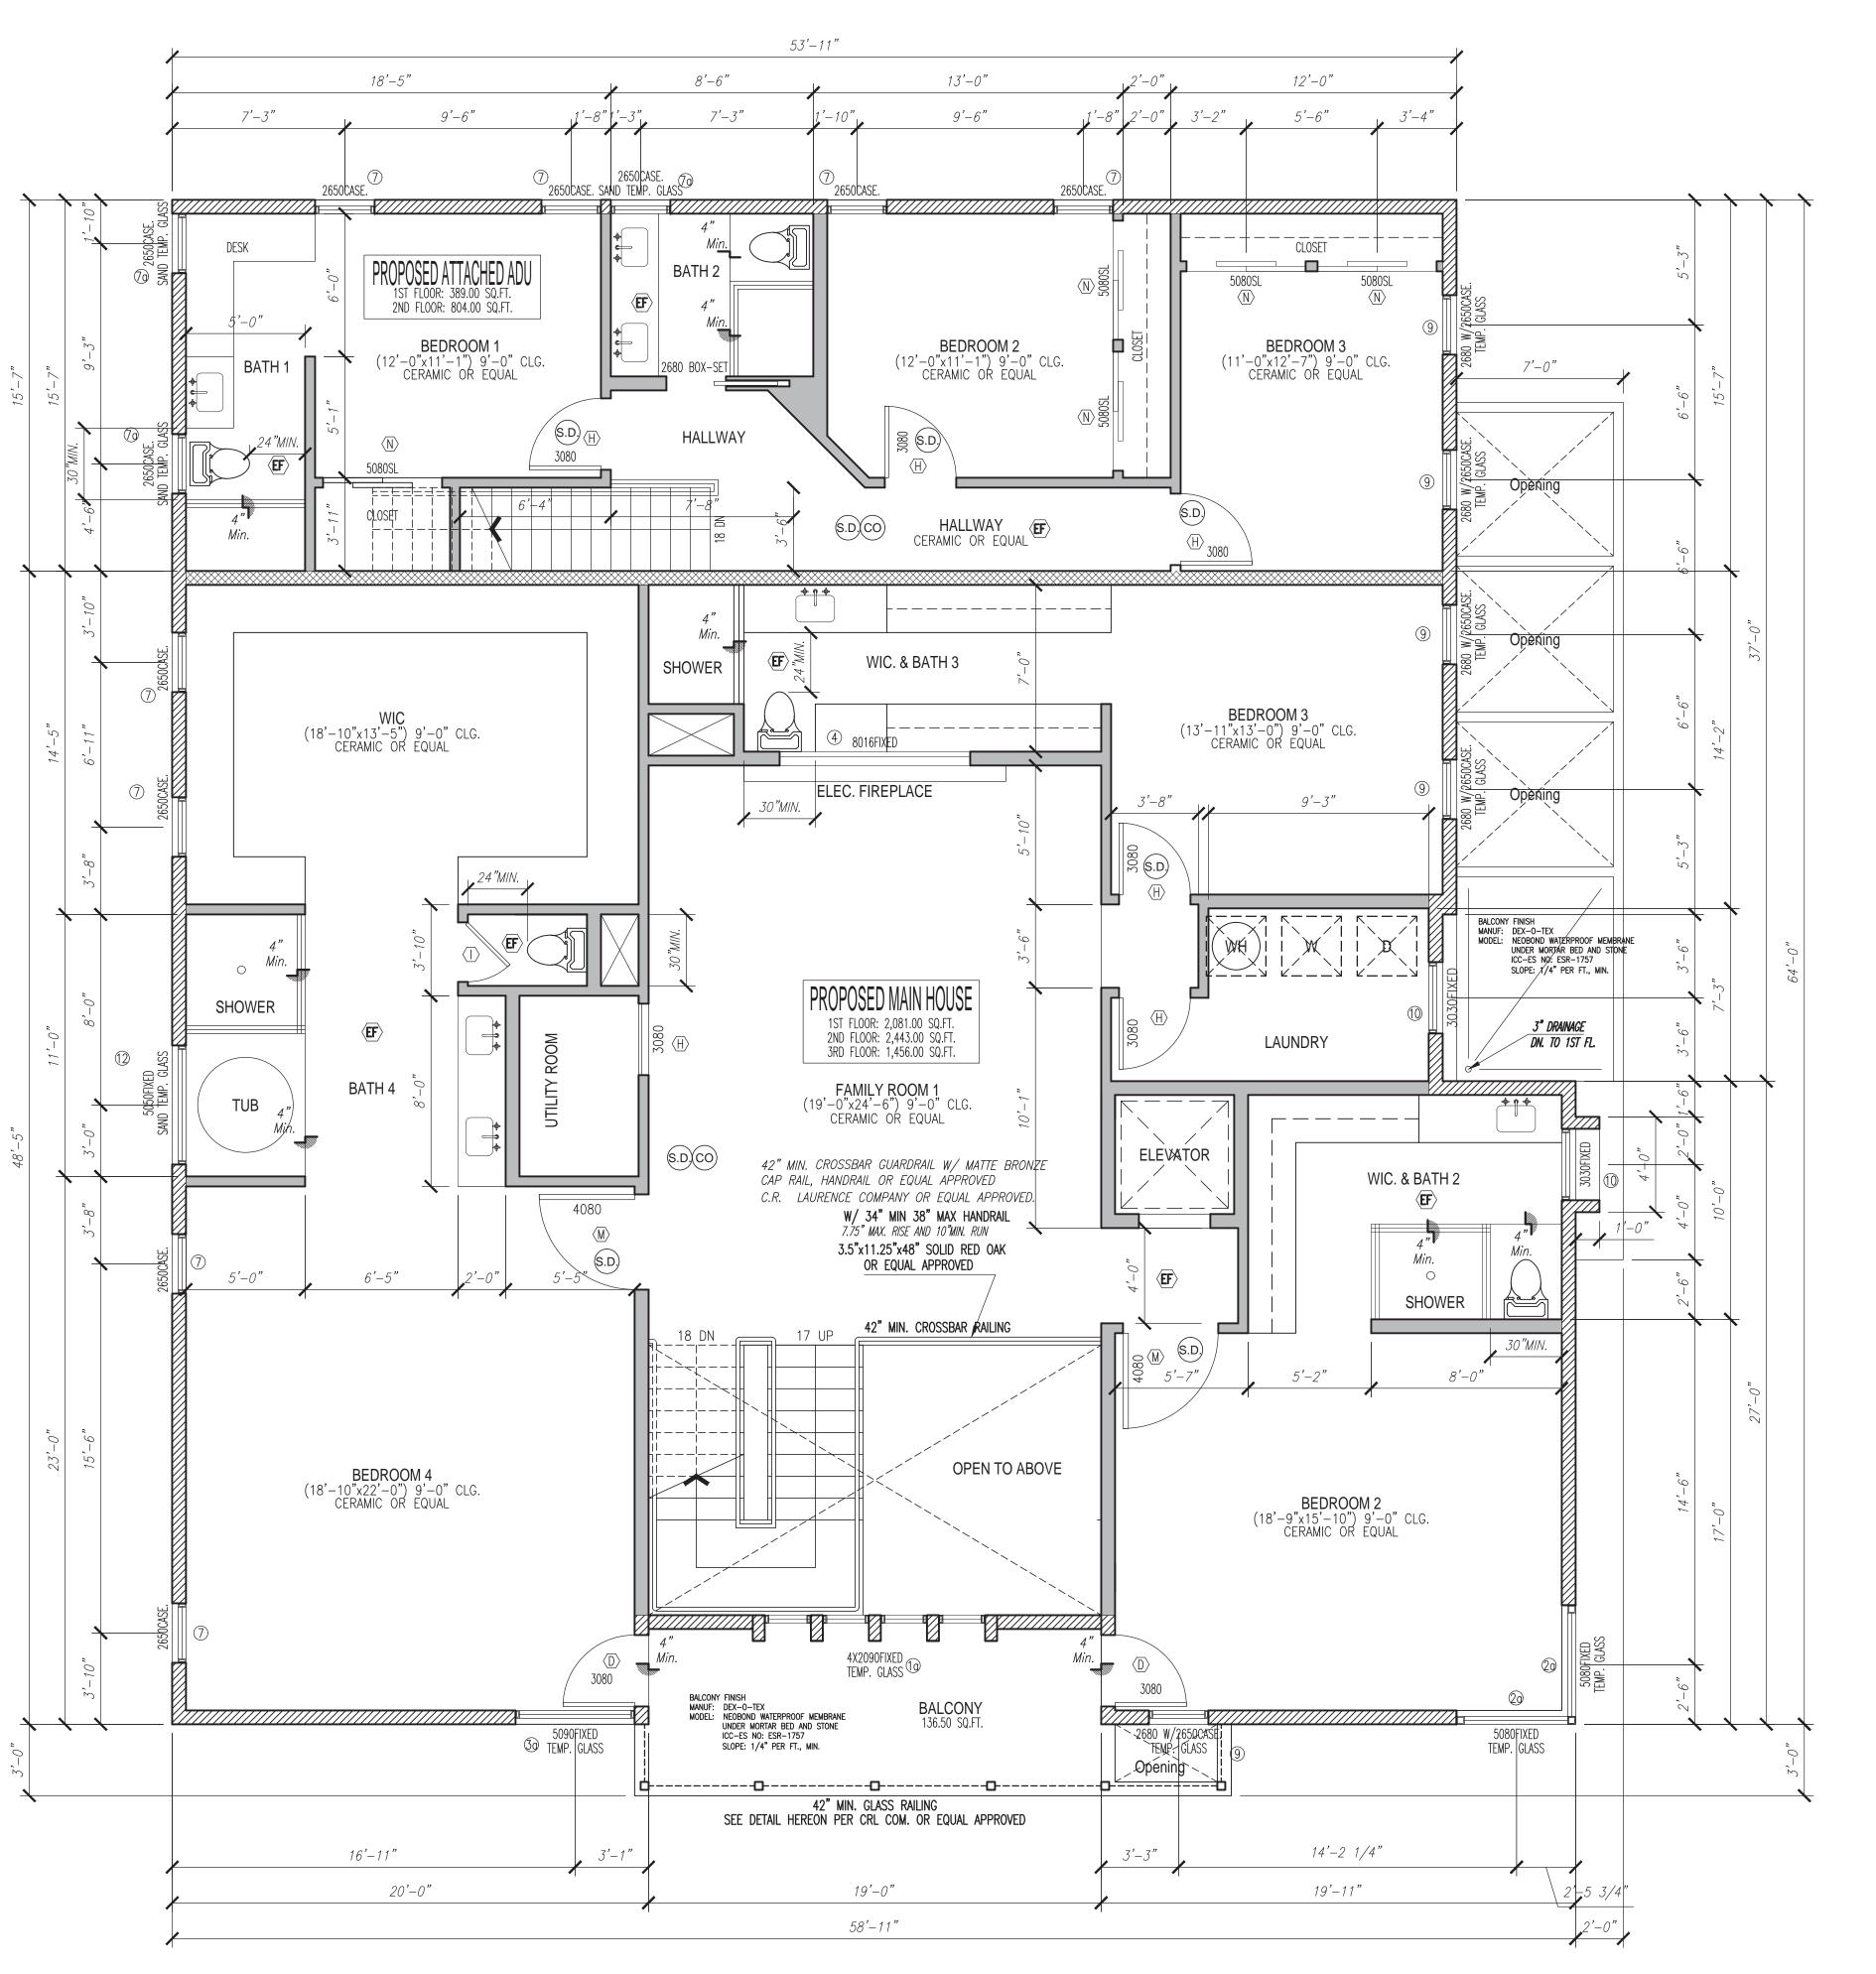

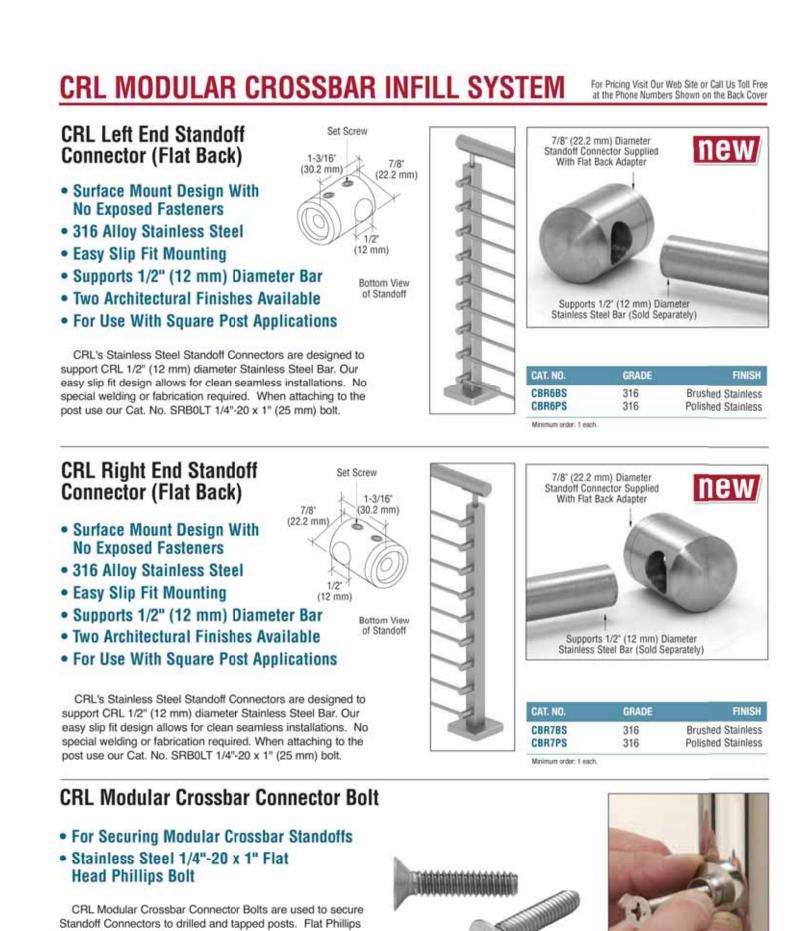

criaurence.com

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head bolt has 1/4"-20 thread.

Minimum order: 50 each. Must be ordered in increments of 50.

1/4°-20 x 1° (25 mm)



No. C 18585

Rem 3-31-25

Rem 6-00 CON FORMURE

TO CAN FORMURE

ADDRESS: ONG, FRANCIS PHAT
4122 GLENWOOD STREET, IRVINE, CA 92
Phone: (714) 296 3844

3Y: Q3 DESIGN & CONSTRUCTION INC.

Q3 DESIGN & CONSTRUCTION INC.
1218 CAMDEN PL. SANTA ANA, CA 92707
(CELL): 714 458 5374 - EMAIL: DOQUOCPL@YAHOO.COM
CONTACT PERSON: QUOC DO

PROPOSED 2ND FLOOR PLAN

DONNA DOAN RESIDENCE
PROPOSED NEW MAIN HOUSE AND ATTACHED ADU
TWO STORY RESIDENTIAL
4731 Los Patos Ave., Huntington Beach, CA 92649

DATE:

TITLE:


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APN: 163-302-3

DRAWN BY: QD SCALE: 1/4"=1'-0"

SHEET NO. 8

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WINDOW SCHEDULE			
SYM.	SIZE	TYPE	QUAN.
1	19'-0"x10'-0"	FIXED TEMP. GLASS W/ DOOR A (50100)	1
1a	4X2'-0"x9'-0"	FIXED TEMP. GLASS	1
1b	4X2'-0"x8'-0"	FIXED TEMP. GLASS	1
2	5'-0"x9'-0"	FIXED TEMP. GLASS	2
2a	5'-0"x8'-0"	FIXED TEMP. GLASS	2
3	5'-0"x10'-0"	FIXED TEMP. GLASS	1
3a	5'-0"x9'-0"	FIXED TEMP. GLASS	1
4	8'-0"x1'-6"	FIXED TEMP. GLASS	1
5	3'-0"x10'-0"	FIXED TEMP. GLASS	1
6	2'-6"x8'-0"	w/ LOWER 2650 Casement TEMP. GLASS	1
7	2'-6"x5'-0"	Casement WINDOWS	12
7a	2'-6"x5'-0"	Casement WINDOWS W/SAND TEMP. GLASS	3
8	8'-4"x2'-0"	FIXED TEMP. GLASS	1
9	2'-6"x8'-0"	w/ UPPER 2650 Casement TEMP. GLASS	5
10	3'-0"x3'-0"	FIXED TEMP. GLASS	2
11	4'-0"x4'-0"	Casement WINDOWS	3
12	5'-0"x5'-0"	FIXED TEMP. GLASS	1

All doors & windows shall meet Huntington Beach Security ordinance

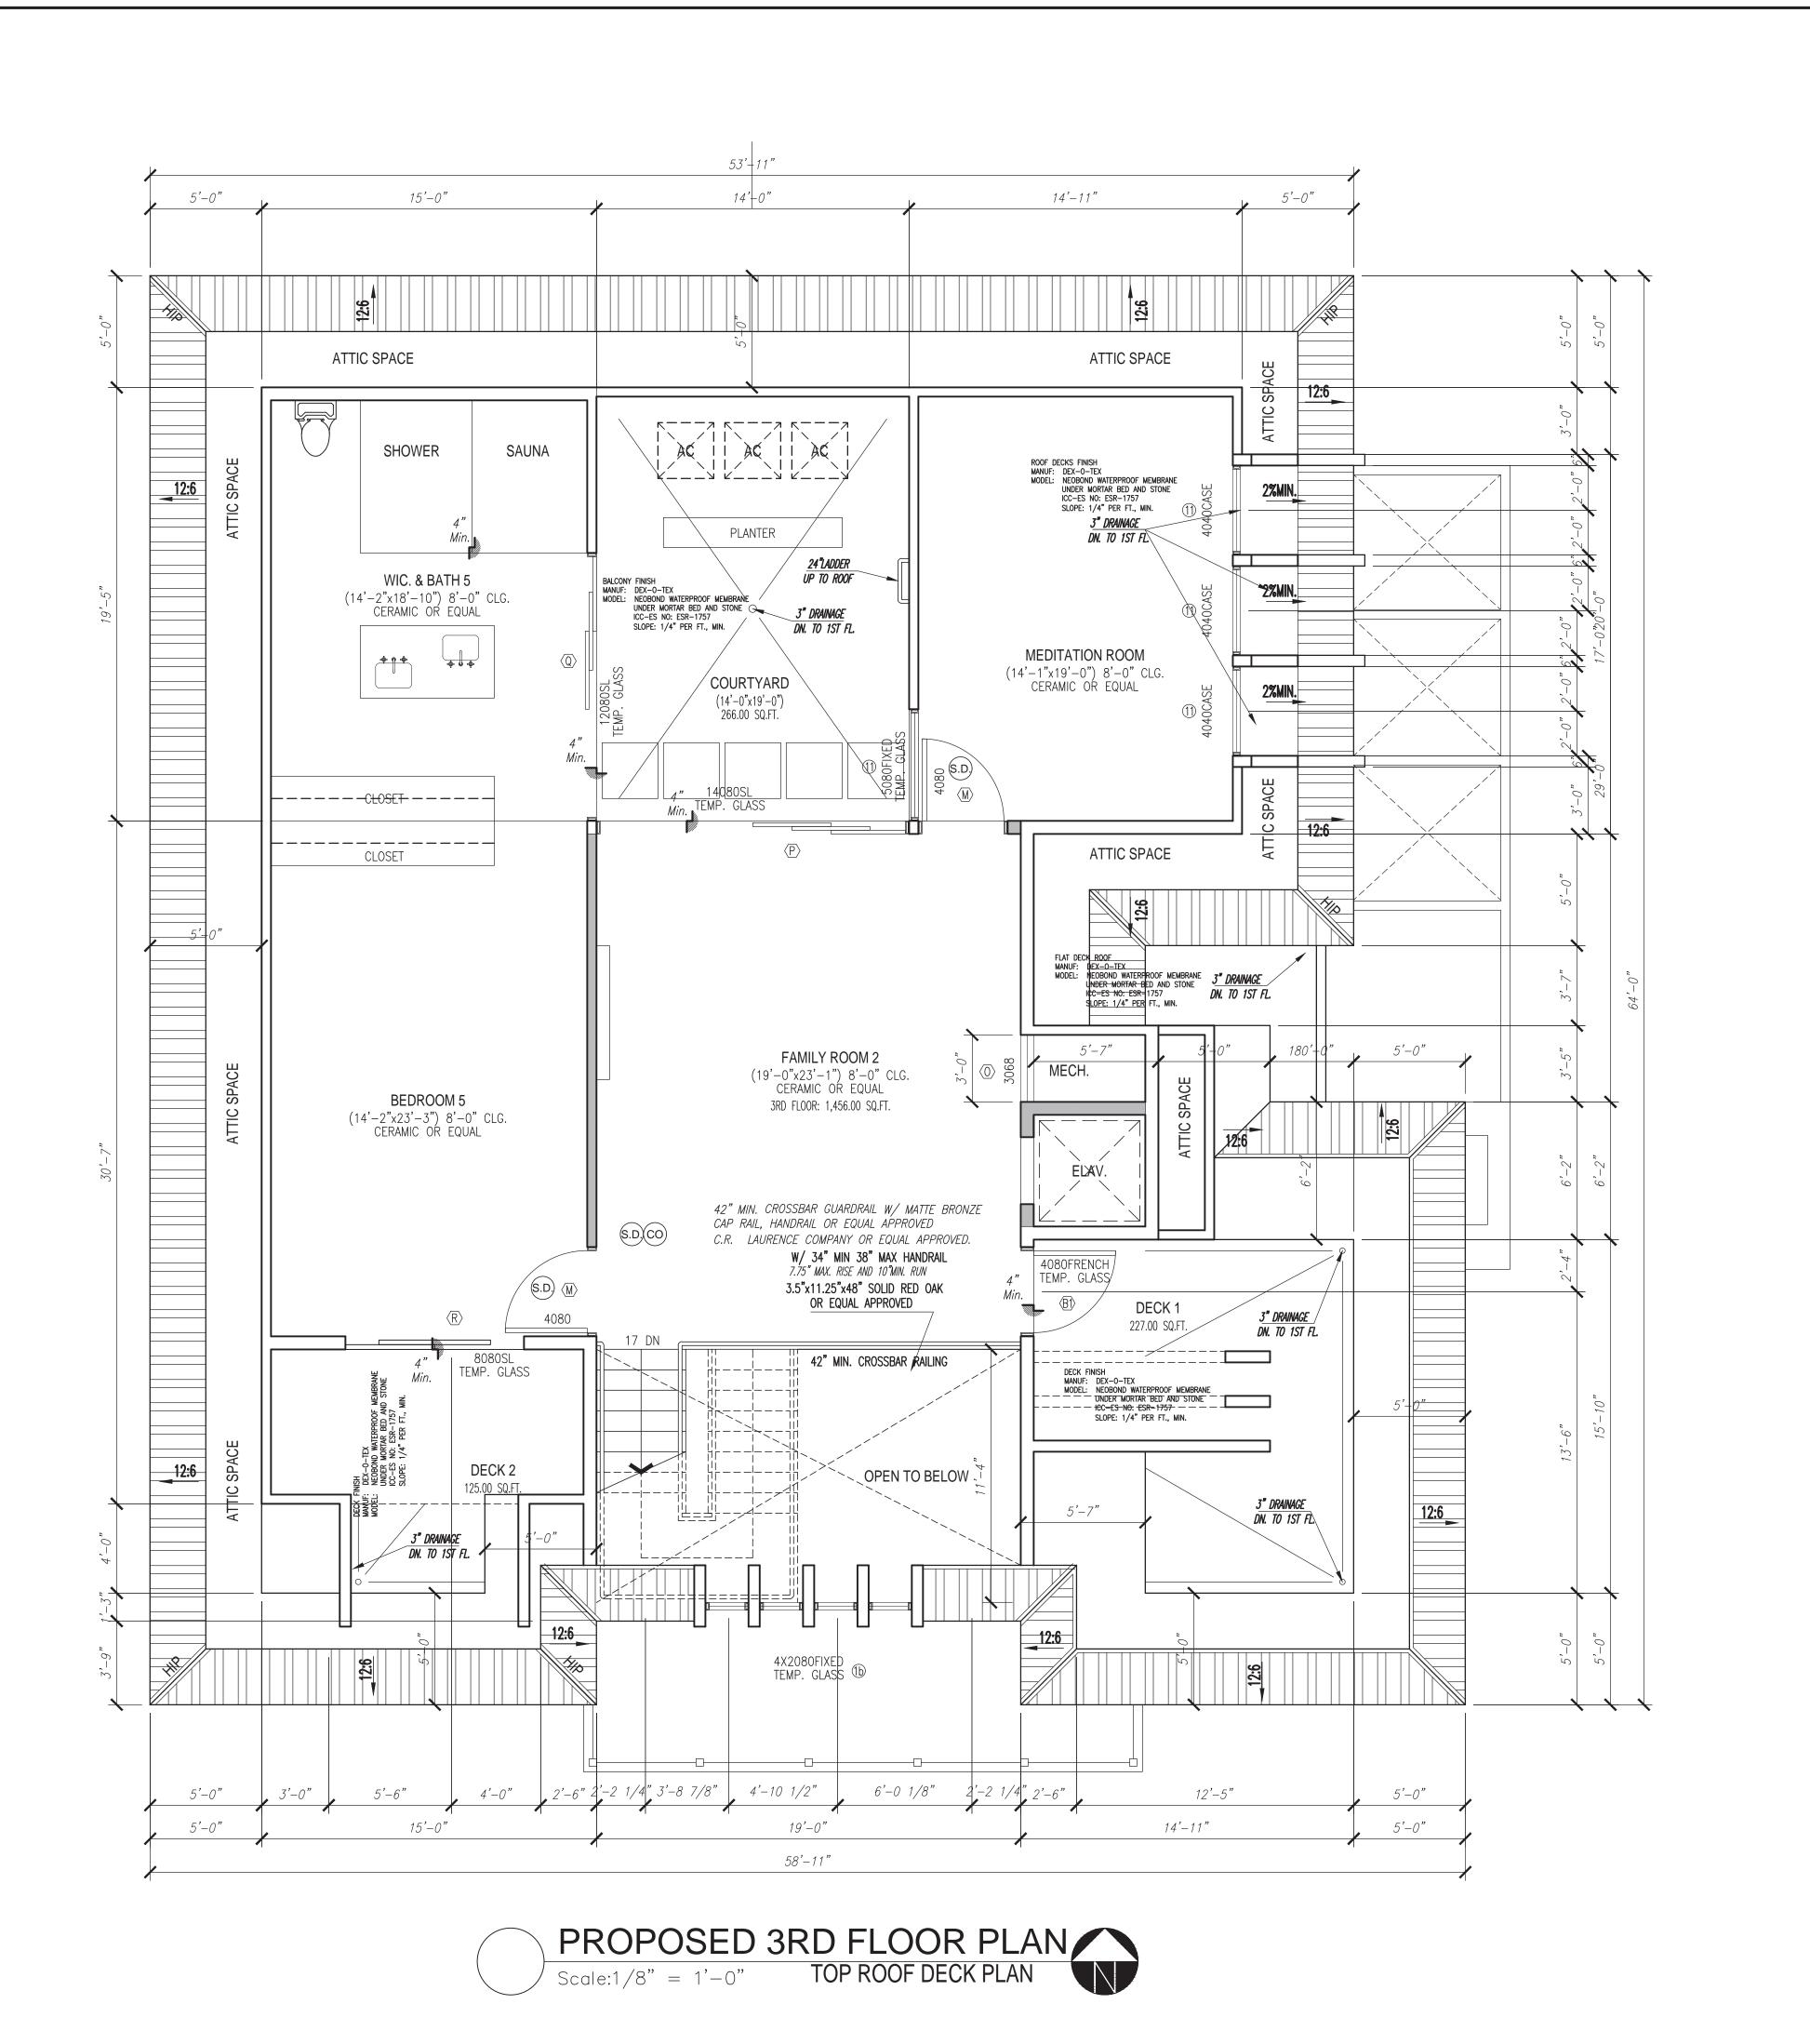ALL WINDOWS AND GLAZED DOORS SHALL BE DUAL GLAZED AND LABELED "The NFRC temporary label displayed on windows must remain on the unit until final inspection has been completed". EVERY SLEEPING ROOM SHALL HAVE AN EGRESS WINDOW HAVING A FINISHED SILL HEIGHT. NOT MORE THAN 44" ABOVE THE FINISHED FLOOR

ALL NEW GLAZING SHALL COMPLY WITH STANDARDS OF THE U.S. CONSUMER PRODUCT SAFETY COMISSION. MANUFACTERS TO SUPPLY CERTIFICATE OF COMPLIANCE TO THE OWNER.

NOTE:

DOOR & WINDOW: ALUMINUM BRONZE ANODIZED (C.R. LAURENCE COMPANY) STAIR GUARD RAIL C.R. LAURENCE COMPANY

OR EQUAL APPROVED

U-FACTOR = 0.30 AND SHGC = 0.23 OR SEE T-24 SHEET




PHAT VINE, CA 9 FRANCIS I ONG, GLENWOO

DESIGN & CONSTRUCTION IN 1218 CAMDEN PL. SANTA ANA, CA 92707 LL): 714 458 5374 - EMAIL: DOQUOCPL@YAHOO. CONTACT PERSON: QUOC DO **Q**3 ED ED

PROPOSED 3RD FLOOR PLAN
AND TOP ROOF DECK PLAN
DONNA DOAN RESIDENCE
PROPOSED NEW MAIN HOUSE AND ATTACHED ADU
TWO STORY RESIDENTIAL
T

PROJECT

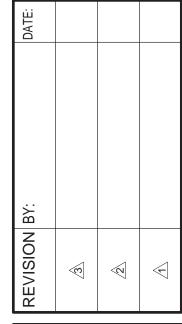


DATE: 06-25-2023 JOB NO.: 0321 184B

DRAWN BY: QD SCALE: 1/4"=1'-0"

SHEET NO. 9

OF 35

A-103

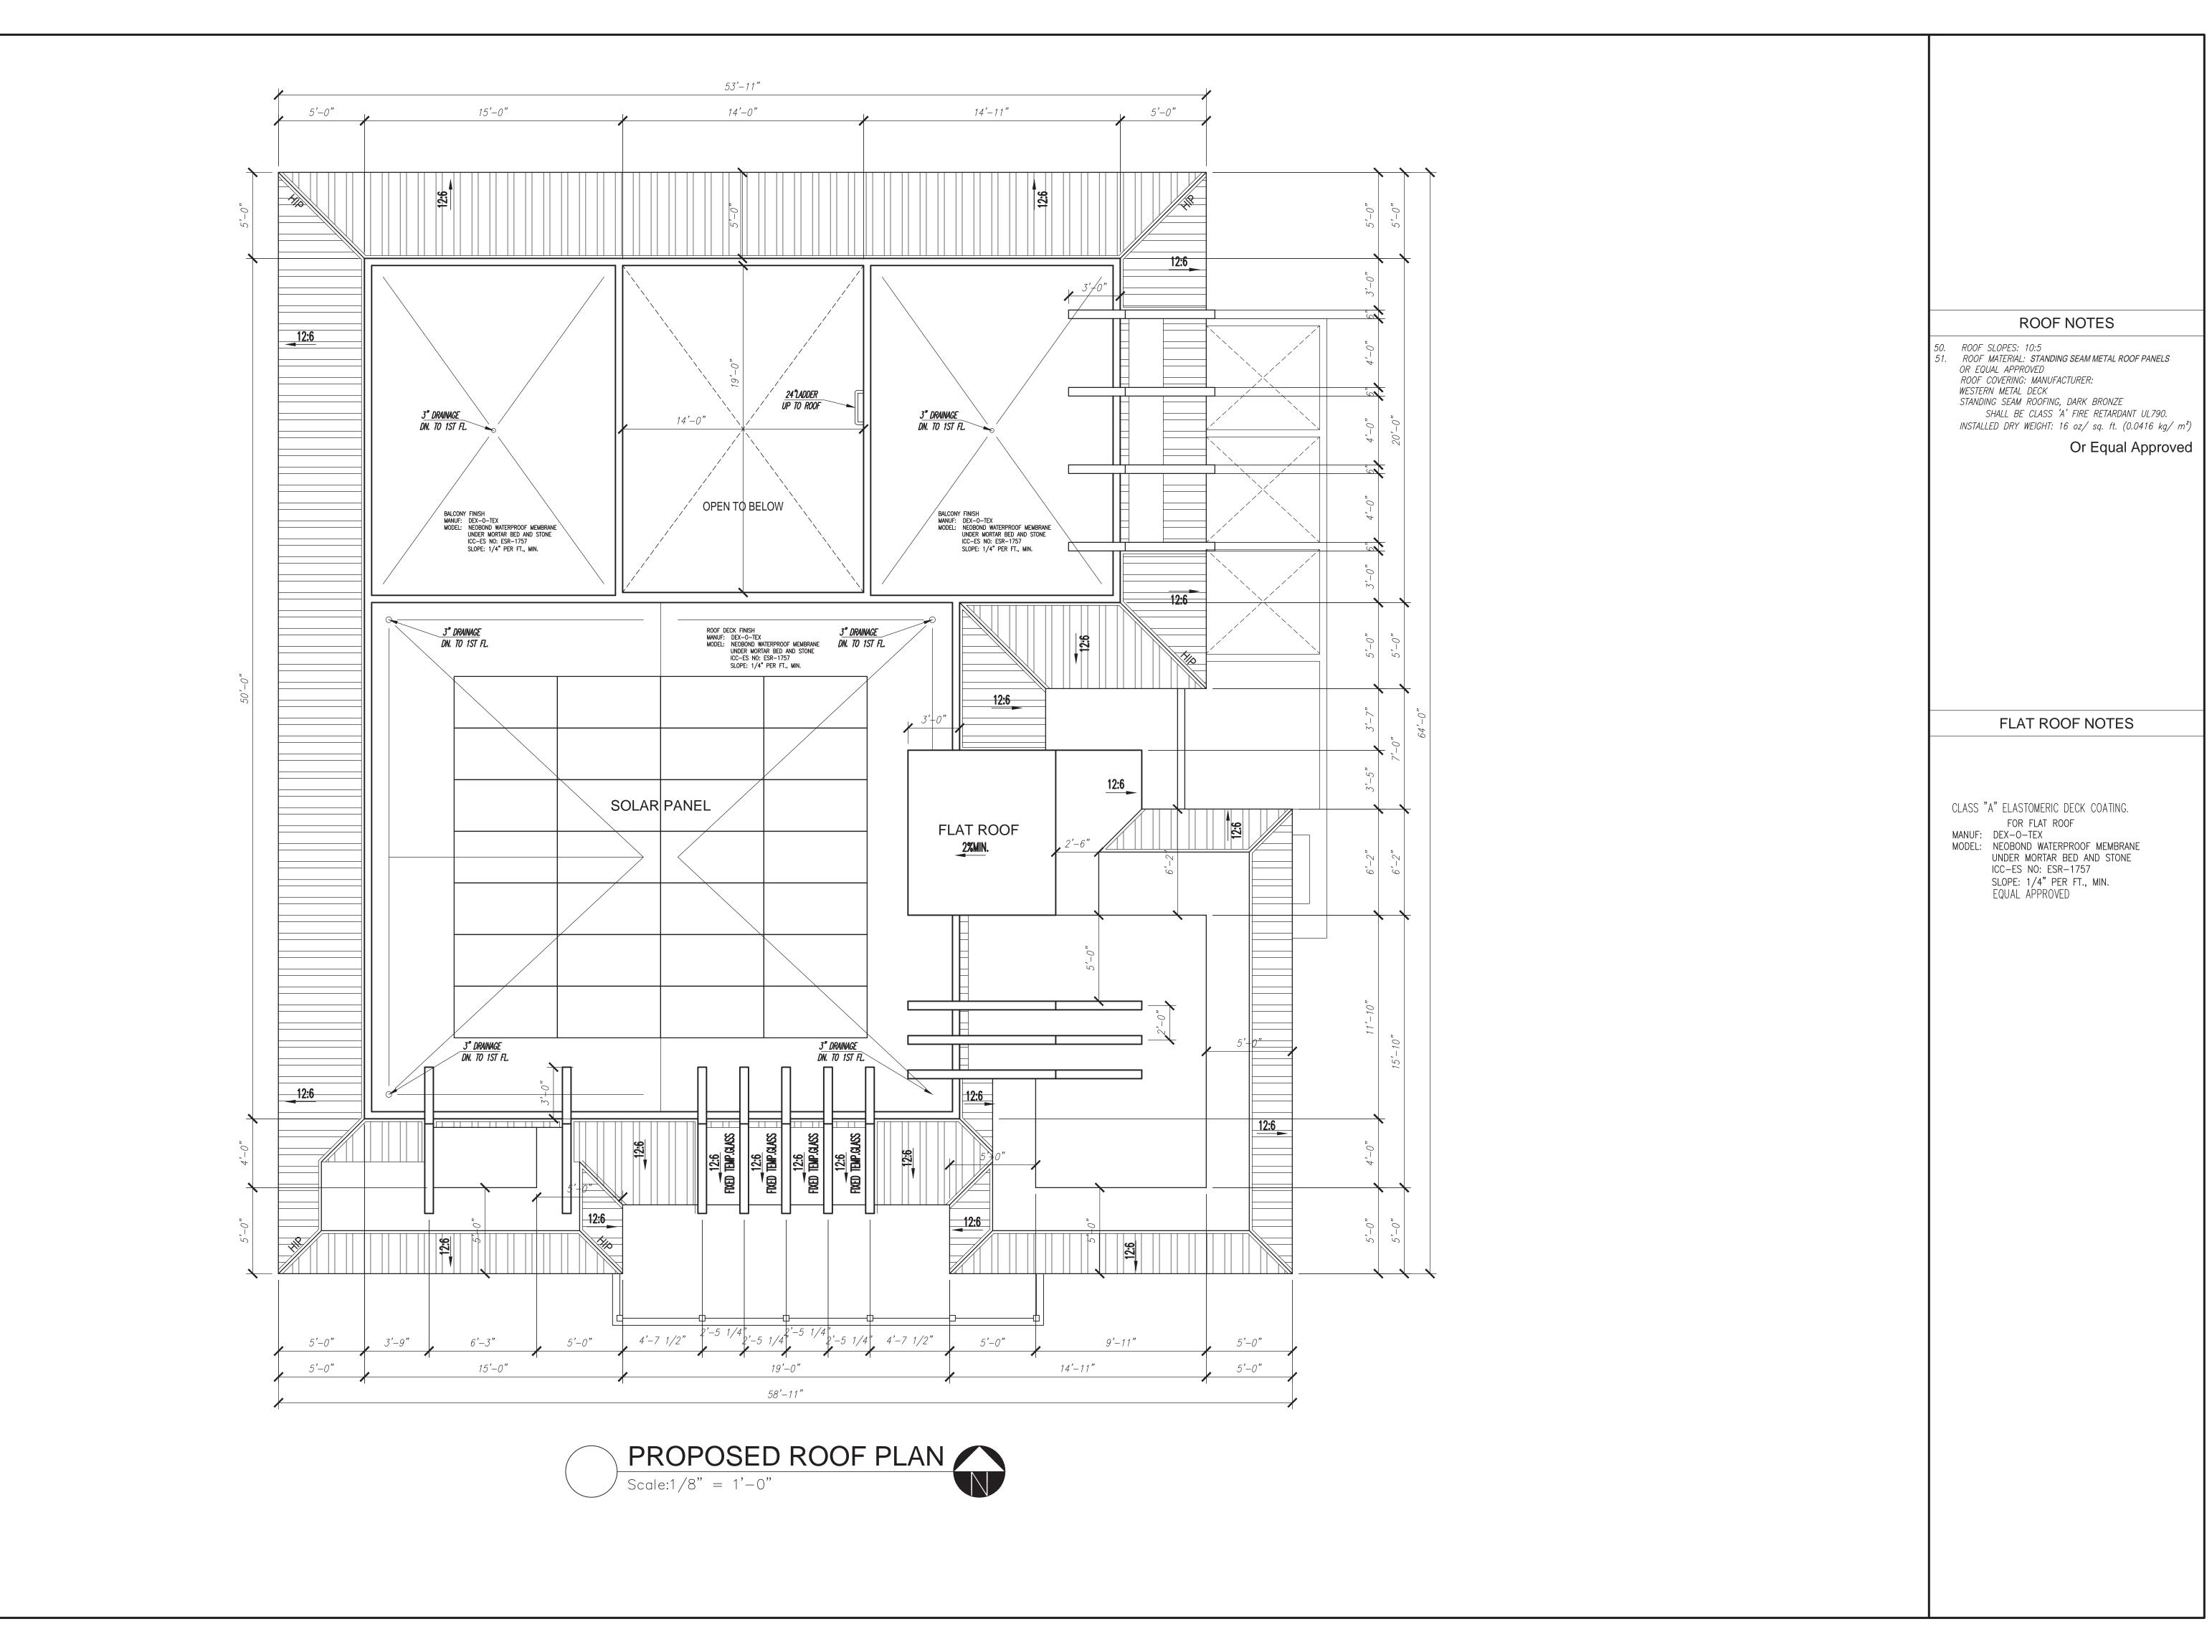

ONG, FRANCIS PHAT 2 GLENWOOD STREET, IRVINE, CA 920 Phone: (714) 296 3844

Q3 DESIGN & CONSTRUCTION INC 3 DESIGN & CONSTRUCTION IN 1218 CAMDEN PL. SANTA ANA, CA 92707 ELL): 714 458 5374 - EMAIL: DOQUOCPL@YAHOO. CONTACT PERSON: QUOC DO Q3 (CELL GNED BY:

DONNA DOAN RESIDENCE
PROPOSED NEW MAIN HOUSE AND ATTACHED ADU
TWO STORY RESIDENTIAL
4731 Los Patos Ave., Huntington Beach, CA 92649

DATE: 06-25-2023 JOB NO.: 0321 184B DRAWN BY: QD

SCALE: 1/4"=1'-0"

SHEET NO. 10

A-104

